

MONTGOMERY COUNTY DEPARTMENT OF HOUSING AND COMMUNITY AFFAIRS

MONTGOMERY VILLAGE SOUTH VILLAGE HOMES LIGHTING AND SITE IMPROVEMENTS PROJECT

MONTGOMERY COUNTY MARYLAND

TREE CANOPY REQUIREMENTS TABLE		
To be completed by the consultant and placed on the first sheet of the Sediment Control / Stormwater Management plan set for all projects.		
Exempt: Yes <input type="checkbox"/> No <input checked="" type="checkbox"/> If exempt under Section 55-5 of the Code, please check the applicable exemption category below.		
Total Property Area	Total Disturbed Area	
62,291 square feet	11,761 square feet	
Shade Trees Required	Shade Trees Proposed to be Planted	
9		
Fee in Lieu (Trees Required - Trees Planted) x \$250	\$ 2,250	
Required Number of Shade Trees		
Area (sq. ft.) of the Limits of Disturbance	Number of Shade Trees Required	
FROM	TO	
1	6,000	3
6,001	8,000	6
8,001	12,000	9
12,001	14,000	12
14,001	40,000	15
If the square footage of the limits of disturbance is more than 40,000, then the number of shade trees required must be calculated using the following formula: (Number of Square Feet in Limits of Disturbance ÷ 40,000) x 15		
EXEMPTION CATEGORIES:		
<input type="checkbox"/> 55-5(a) any activity that is subject to Article II of Chapter 22A;	<input type="checkbox"/> maintenance has obtained all required permits;	
<input type="checkbox"/> 55-5(b) any commercial logging or timber harvesting operation with an approved exemption from Article II of Chapter 22A;	<input type="checkbox"/> 55-5(h) any stream restoration project if the person performing the work has obtained all necessary permits;	
<input type="checkbox"/> 55-5(i) any activity conducted by the County Parks Department;	<input type="checkbox"/> 55-5(i) cutting or clearing any tree to comply with applicable provisions of any federal, state, or local law governing safety of dams;	
<input type="checkbox"/> 55-5(j) routine or emergency maintenance of an existing stormwater management facility, including an existing access road, if the person performing the	<input type="checkbox"/> OTHER: Specify per Section 55-5 of the Code.	

SHEET NO.	DESCRIPTION	DRAWING NO.
1	TITLE SHEET*	GN-01
2	ABBREVIATIONS AND SYMBOLS	GN-02
3	KEY SHEET	GN-03
4-5	EXISTING CONDITIONS PLAN - CENTER STAGE	EC-01-02
6-7	EXISTING CONDITIONS PLAN - GROVER'S FORGE	EC-03-04
8-9	EXISTING CONDITIONS PLAN - THE HAMPTONS	EC-05-06
10-12	EXISTING CONDITIONS PLAN - WALKER'S CHOICE	EC-07-09
13-14	DEMOLITION PLAN - CENTER STAGE	DM-01-02
15-16	DEMOLITION PLAN - GROVER'S FORGE	DM-03-04
17-18	DEMOLITION PLAN - THE HAMPTONS	DM-05-06
19-21	DEMOLITION PLAN - WALKER'S CHOICE	DM-07-09
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24-26	LIGHTING PLAN - GROVER'S FORGE	LT-03-05
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29-31	LIGHTING PLAN - WALKER'S CHOICE	LT-08-10
32-33	LIGHTING DETAILS	DE-01-02
34	GROVER'S FORGE - SIDEWALK PLAN	PS-01
35	GROVER'S FORGE - SIDEWALK PROFILE	HP-01
36	GROVER'S FORGE - SIDEWALK DETAILS	DT-01
37-38	GROVER'S FORGE - GRADING AND DRAINAGE*	DD-01-02
39	GROVER'S FORGE - STORMWATER MANAGEMENT PLAN*	SW-01
40	GROVER'S FORGE - E&SC NOTES SHEET*	EN-01
41	GROVER'S FORGE - LANDSCAPE PLAN*	LS-01
42-46	GROVER'S FORGE - CROSS SECTIONS	XS-01-05

* MCDPS SCSWM SHEETS


SHEET NO.	DESCRIPTION	DRAWING NO.
1	TITLE SHEET*	GN-01
37-38	GROVER'S FORGE - GRADING AND DRAINAGE*	DD-01-02
39	GROVER'S FORGE - STORMWATER MANAGEMENT PLAN*	SW-01
40	GROVER'S FORGE - E&SC NOTES SHEET*	EN-01
41	GROVER'S FORGE - LANDSCAPE PLAN*	LS-01

REVISIONS
 NOTE:
 See Index of Sheets for List of Revised Sheet Numbers

- January 8, 2020
- January 30, 2020 Sheet 23, LT-02
- Sheet 29, LT-10
- Sheet 34, PS-01

RIGHT OF WAY LIMITS ARE APPROXIMATE WITH EXCEPTION OF SURVEYED STORMWATER MANAGEMENT EASEMENT

CENTER STAGE PROJECT SITE

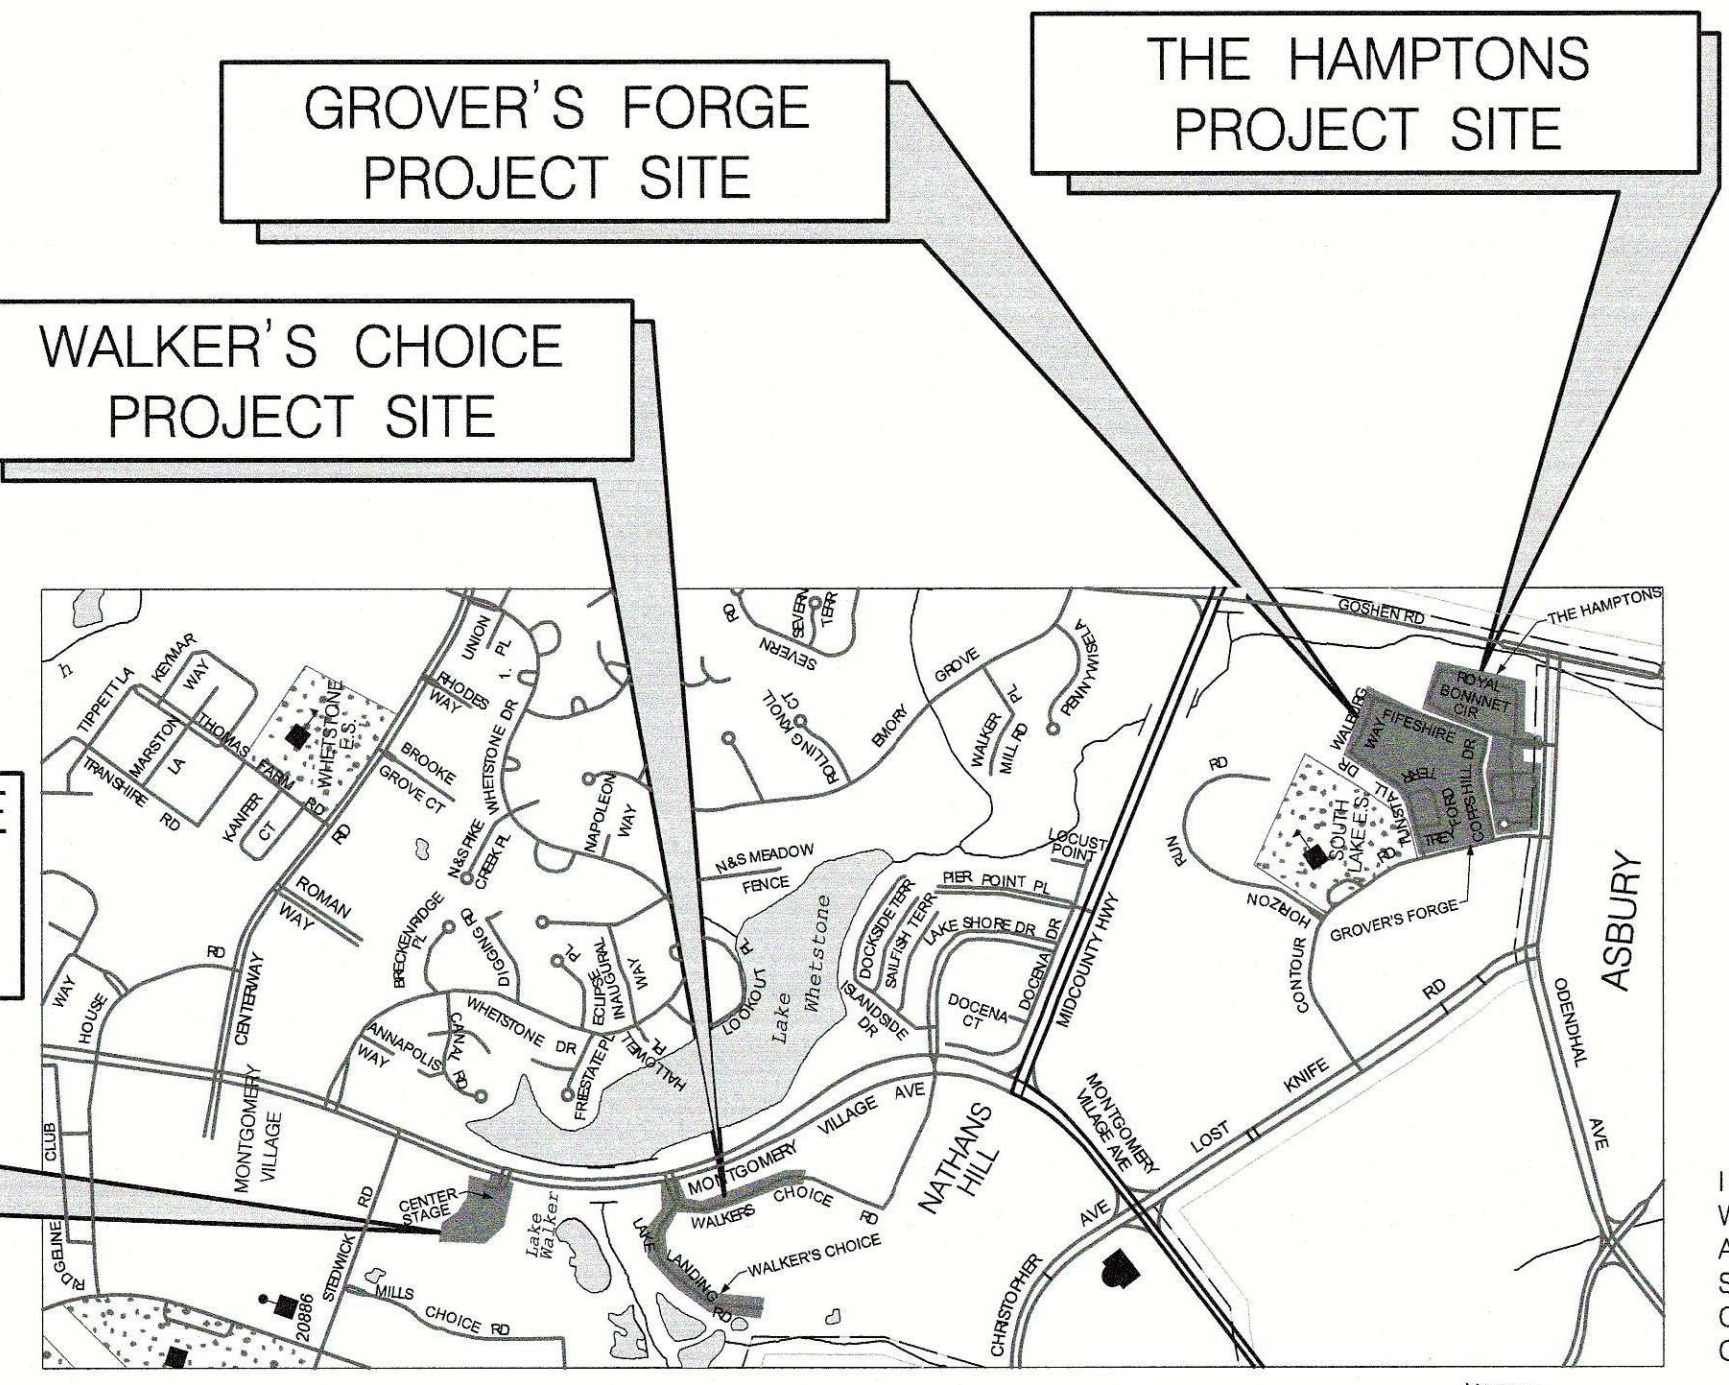

RELATED REQUIRED PERMITS					
To be completed by the consultant and placed on the first sheet of the Sediment Control / Stormwater Management plan set for all projects.					
IT IS THE RESPONSIBILITY OF PERMITTEE/OWNER OF THIS SITE TO OBTAIN ALL REQUIRED PERMITS PRIOR TO ISSUANCE OF THE APPROVED SEDIMENT CONTROL PERMIT					
TYPE OF PERMIT	REQD	NOT REQD	PERMIT #	EXPIRATION DATE	WORK RESTRICTION DATES
MCDPS Floodplain District		X			
WATERWAYS/WETLAND(S):		X			
a. Corps of Engineers		X			
b. MDE		X			
c. MDE Water Quality Certification		X			
MDE Dam Safety		X		Approval Date	
DNR Roadside Tree Care Permit		X		Approval Date	
DPS Roadside Tree Protection Plan		X		Approval Date	
N.P.D.E.S. NOTICE OF INTENT		X		DATE FILED	
OTHERS (Please List):		X			

DESIGN CERTIFICATION

I HEREBY CERTIFY THAT THIS PLAN HAS BEEN PREPARED IN ACCORDANCE WITH THE "2011 MARYLAND STANDARDS AND SPECIFICATIONS FOR SOIL EROSION AND SEDIMENT CONTROL," MONTGOMERY COUNTY DEPARTMENT OF PERMITTING SERVICES EXECUTIVE REGULATIONS 5-90, 7-02AM, AND 36-90, AND MONTGOMERY COUNTY DEPARTMENT OF PUBLIC WORKS AND TRANSPORTATION "STORM DRAIN CRITERIA" DATED AUGUST 1988.

12/9/19 DATE
 KEVIN SCHEFFER, PE
 MD REGISTRATION NO. 43192

OWNER'S CERTIFICATION


I HEREBY CERTIFY THAT ALL CLEARING, GRADING, AND /OR DEVELOPMENT WILL BE DONE PURSUANT TO THIS PLAN AND THAT ANY RESPONSIBLE PERSONNEL INVOLVED IN THE CONSTRUCTION PROJECT WILL HAVE A CERTIFICATE OF ATTENDANCE AT A DEPARTMENT OF NATURAL RESOURCES APPROVED TRAINING PROGRAM FOR THE CONTROL OF SEDIMENT AND EROSION BEGINNING THE PROJECT.

Rogers D. Stanley
 ROGERS D. STANLEY, RL
 CHIEF, NEIGHBORHOOD REVITALIZATION SECTION
 12/09/19 DATE

PROFESSIONAL CERTIFICATION

I HEREBY CERTIFY THAT THESE DOCUMENTS WERE PREPARED OR APPROVED BY ME, AND THAT I AM A DULY LICENSED PROFESSIONAL ENGINEER UNDER THE STATE LAWS OF THE STATE OF MARYLAND, LICENSE NO. 17673, EXPIRATION DATE: 01/29/2020.


Douglas H. Simmons, PE
 Digitally signed by Douglas H. Simmons, PE
 Date: 2019.12.09 15:31:28 -0500

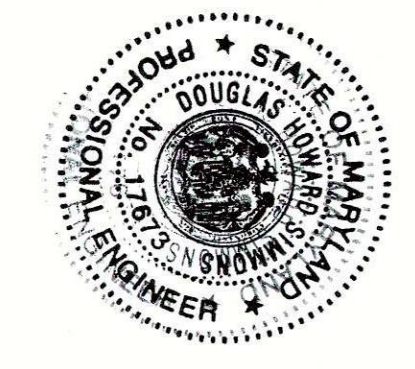

CERTIFICATION OF THE QUANTITIES

I HEREBY CERTIFY THAT THE ESTIMATED TOTAL AMOUNT OF EXCAVATION AND FILL AS SHOWN ON THESE PLANS HAS BEEN COMPUTED TO BE 122 CUBIC YARDS OF EXCAVATION, 113 CUBIC YARDS OF FILL, AND THE TOTAL AREA TO BE DISTURBED AS SHOWN ON THESE PLANS HAS BEEN DETERMINED TO BE 11,761 SQUARE FEET OR 0.27 ACRES.

12/09/19 DATE
 DOUGLAS H. SIMMONS, PE
 MD REGISTRATION NO. 17673

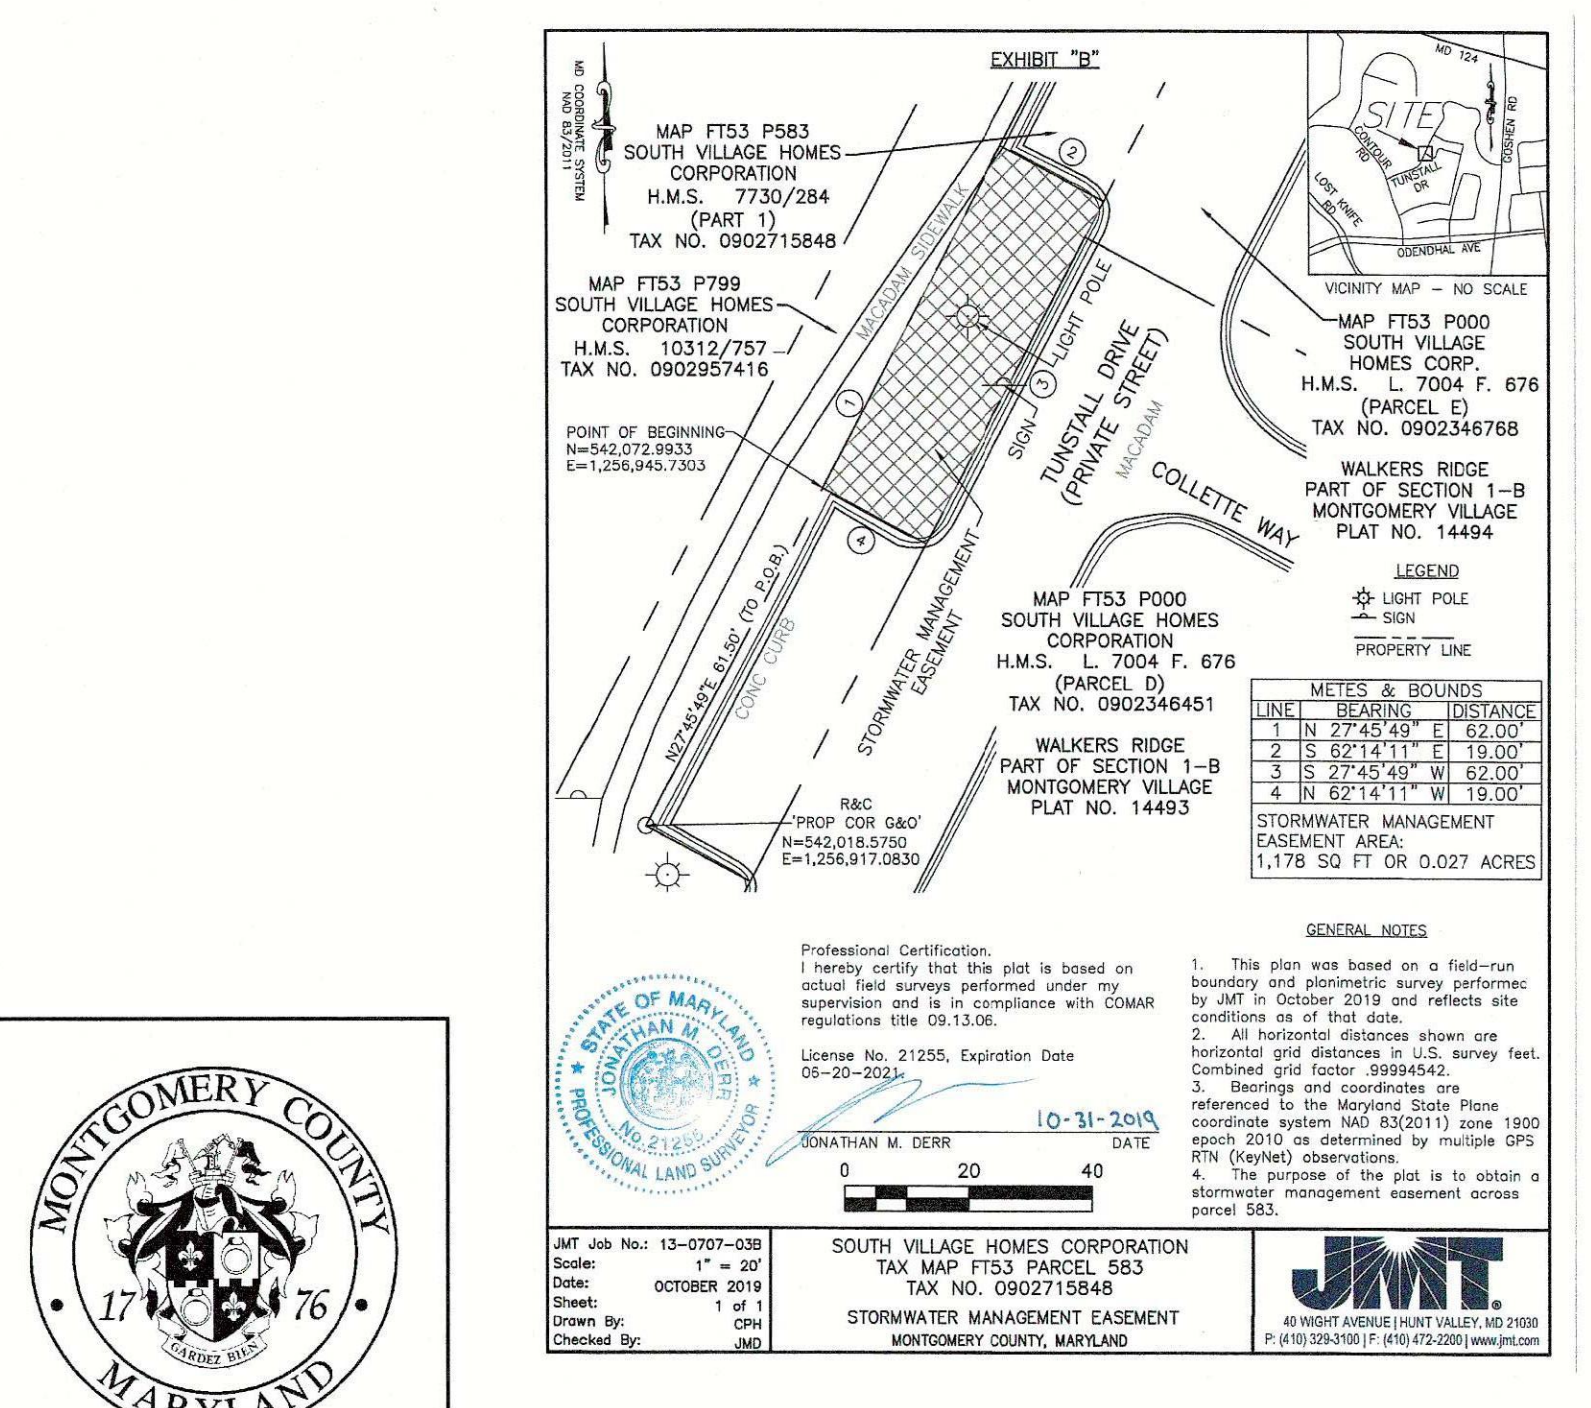

DESCRIPTION OF A STORMWATER MANAGEMENT EASEMENT

Part of Parcel 853 - Tax Map FT53 Grid 0009
 Property of South Village Homes Corporation
 9th Election District
 Tax Act. No. 090215848
 Montgomery County, Maryland

BEING A PART of the property as described as "Part One" in a Deed from Kettler Brothers, Inc. to South Village Homes Corporation, recorded June 29, 1987 among the Land Records of Montgomery County, Maryland in H.M.S. Liber 7730 Folio 284.

ALSO BEING SHOWN on a Montgomery County, Maryland Plat as Exhibit "B", prepared by Johnson Mimmitt & Thompson attached hereto and immediately following this description.

ALSO BEING A PART of a parcel of land situate, lying and being in the 9th Election District, Montgomery County, Maryland and being more particularly described by course and distances, as now surveyed, based on the Maryland State Plane Coordinate System, North American Datum 83/011, that is to say:

BEGINNING FOR THE SAME at a point which has a Maryland State Plane Coordinate of North 542,072.9933, East 1,256,945.7203, said point also being located North 27°45'49" East 61.50 feet from a rebar and cap marked "PROJ COR 6807", having a Maryland State Plane Coordinate of North 542,018.5750, East 1,256,917.0830, found at the beginning of the 2nd or North 27°45'49" East, 197.00 foot line of "Part One" as described in the aforementioned deed H.M.S. Liber 7730 Folio 284, thence bearing on a portion of the aforementioned 2nd line, as follows:

- North 27°45'49" East, 62.00 feet, thence leaving the aforementioned 2nd line and running across and through the lands of the grantor the following course and distance as now surveyed, viz;
- South 62°14'11" East, 19.00 feet, to intersect the 4th or South 27°45'50" West, 197.00 foot line of "Part One" as described in the aforementioned deed H.M.S. Liber 7730 Folio 284, said line also being the westerly side of Tunsall Drive, (Private Street), as shown on subdivision plats entitled "Walkers Ridge, Part of Section 1-B of Montgomery Village" recorded October 4th, 1983 among the Land Records of Montgomery County, Maryland as Plat 14493 & 14494, thence bearing on a portion of the aforementioned 4th line, and a portion of the westerly side of Tunsall Drive, (Private Street),
- South 27°45'49" West, 62.00 feet, thence leaving the aforementioned 4th line and westerly side of Tunsall Drive, (Private Street), and running across and through the lands of the grantor the following course and distance as now surveyed, viz;
- North 62°14'11" West, 19.00 feet, to the Point of Beginning.

Containing 1,178 sq. ft. or 0.027 acres of land, more or less.

The above description and surveying work associated with its preparation has been prepared under my responsible charge and as in compliance with COMAR Regulations Title 09.13.06.08. My License expires on June 20th, 2021.

Jonathan M. Dear, Professional Land Surveyor
 Maryland License No. 21255

TECHNICAL REVIEW OF SEDIMENT CONTROL		ADMINISTRATIVE REVIEW	
Thomas Weadon	1/10/20	Thomas Weadon	1/10/20
REVIEWED	DATE	REVIEWED	DATE
TECHNICAL REVIEW OF STORMWATER MANAGEMENT		SMALL LOT DRAINAGE APPROVAL	
Thomas Weadon	1/10/20	N/A	OR
REVIEWED	DATE	REVIEWED	DATE
MCDPS APPROVAL OF THIS PLAN WILL EXPIRE TWO YEARS FROM THE DATE OF APPROVAL IF THE PROJECT HAS NOT STARTED		NOTE: MCDPS APPROVAL DOES NOT NEGATE THE NEED FOR A MCDPS ACCESS PERMIT.	

DPS approval of a sediment control or stormwater management plan is for demonstrated compliance with minimum environmental runoff treatment standards and does not create or imply any right to divert or concentrate runoff onto any adjacent property without that property owner's permission. It does not relieve the design engineer or other responsible person of professional liability or ethical responsibility for the adequacy of the drainage design as it affects uphill or downhill properties

285298
 284408
 SEDIMENT CONTROL PERMIT NO.
 SM FILE NO.
 STORMWATER MANAGEMENT
 Landscape Infiltration/ Full ESD

MONTGOMERY COUNTY DEPARTMENT OF HOUSING AND COMMUNITY AFFAIRS

MONTGOMERY VILLAGE /SOUTH VILLAGE HOMES LIGHTING AND SITE IMPROVEMENTS PROJECT

TITLE SHEET

SCALE: NTS _____ ADVERTISED DATE: N/A _____ CONTRACT NO. _____

DESIGNED BY: RJS COUNTY: MONTGOMERY COUNTY
 DRAWN BY: RJS LOGMILE: _____
 CHECKED BY: JWR
 DPS PERMIT: 284408

DRAWING NO. **GN-01** OF **03** SHEET NO. 1 OF 46

ABBREVIATIONS

A.D.T.	AVERAGE DAILY TRAFFIC	NO.	NUMBER
AHD	AHEAD	PAVT.	PAVEMENT
BC	BACK OF CURB	P.C.	POINT OF CURVE
BEG.	BEGIN	P.C.C.	POINT OF COMPOUND CURVE
BG&E	BALTIMORE GAS & ELECTRIC	P.I./PI	POINT OF INTERSECTION
BK	BACK	P.LOT	PARKING LOT
B	BASELINE	POB	POINT OF BEGINNING
BIT.	BITUMINOUS	P.O.C.	POINT ON CURVE
BLDG.	BUILDING	POE	POINT OF END
B.M.	BENCHMARK	P.O.T.	POINT ON TANGENT
B.P.C	BROWN POLYESTER COATED	P.O.V.T.	POINT ON VERTICAL CURVE
C	CUT	P./G.L.	PROFILE GROUND LINE
C.A.T.V.	CABLE T.V.	P.G.L.	PROFILE GRADE LINE
C.C.	CENTER TO CENTER	P./G.E.	PROFILE GROUND ELEVATION
CEN.	CENTER	P.G.E.	PROFILE GRADE ELEVATION
C&G	CURB AND GUTTER	P/R	POINT OF ROTATION
CL	CENTERLINE	P/C	POINT OF CROWN
CL	CLASS	P.R.C.	POINT OF REVERSE CURVATURE
C.M.P./CMP	CORRUGATED METAL PIPE	PROP.	PROPOSED
C.M.P.A.	CORRUGATED METAL PIPE ARCH	P.T., PT	POINT OF TANGENT
C&P	CHESAPEAKE AND POTOMAC TELEPHONE	P.U.E.	PUBLIC UTILITY EASEMENT
COG	CONCRETE GRATE	P.V.C.	POLYVINYL CHLORIDE OR POINT OF VERTICAL CURVE
COL.	COLUMN	P.V.C.C.	POINT OF VERTICAL COMPOUND CURVE
CONC.	CONCRETE	P.V.I.	POINT OF VERTICAL INTERSECTION
CONN.	CONNECTION	P.V.R.C.	POINT OF VERTICAL REVERSE CURVATURE
CONSTR.	CONSTRUCTION	P.V.T.	POINT OF VERTICAL TANGENCE
CONTR.	CONTRACT	R	RADIUS
CORR.	CORRECTION	R/W, R-O-W, ROW	RIGHT-OF-WAY
C.P.	CONCRETE PIPE	R.C.	REMOVE CROWN
C.T.B.	CONCRETE TRAFFIC BARRIER	R.C.C.P.	REINFORCED CIRCULAR CONCRETE PIPE
D	DEGREE OF CURVE	R.C.P.	REINFORCED CONCRETE PIPE
D.H.V.	DESIGN HOURLY VOLUME	RSC	RIGID STEEL CONDUIT
D.I.	DRAINAGE INLET	RT.	RIGHT
DIR	DIRECTION	SAN.	SEWER/SANITARY LINE
DW	DRIVEWAY	S.B.	SOUTHBOUND ROADWAY
DWG.	DRAWING	S.D.	STORM DRAIN
DWS	DETECTABLE WARNING SURFACE	S.D.D.	SURFACE DRAIN DITCH
E&S	EROSION AND SEDIMENT	SDMH	STORM DRAIN MANHOLE
ELECT.	UNDERGROUND ELECTRIC LINE	SDWK	SIDEWALK
E.B.	EASTBOUND ROADWAY	\$	SURVEY LINE
EL./ELEV.	ELEVATION	S.E., S/E	SUPERELEVATION
E.T.	ELECTRIC TRANSFORMER	SHLD.	SHOULDER
E.M.	ELECTRIC MANHOLE	SHT.	SHEET
EX./EXIST.	EXISTING	S&M	SEED AND MULCH
F	FILL	SS	SEWER STRUCTURE
F.B.	FIELD BOOK	S.S.M.	SOIL STABILIZATION MATTING
F.H./HYD.	FIRE HYDRANT	S.S.M.H.	SANITARY SEWER MANHOLE
F.O.	FIBER OPTIC	STA.	STATION
G	GAS LINE	STD.	STANDARD
GA	GAUGE OR GAGE	S.W.M.A.	STORMWATER MANAGEMENT AREA
G&E	GAS AND ELECTRIC	TB	TOP OF BERM
GM	GAS METER	TEL.	UNDERGROUND TELECOMMUNICATION LINE
GR	GROUND	T.C./TC	TOP OF CURB, TOP OF COVER
HBX	HAND BOX	T.C.E.	TEMPORARY CONSTRUCTION EASEMENT
H.D.W.L.	HEADWALL	T.C.P.	TERRA COTTA PIPE
H.E.R.C.P.	HORIZONTAL ELLIPTICAL REINFORCED CONCRETE PIPE	TEMP.	TEMPORARY
HH	HANDHOLE	T.G.	TOP OF GRATE
HMA	HOT MIX ASPHALT	TOE	TOP OF ELEVATION
H.P.	HIGH POINT	T.R.	TOP OF RIM
INV.	INVERT	TRANS.	TRANSFORMER, TRANSITION
I.B.	INFILTRATION BASIN	TRV	TRAVERSE
I.P.	INLET PROTECTION	TRB	TRAFFIC BARRIER
I.S.T.	INLET SEDIMENT TRAP	T.S.E.C.B.	TEMPORARY SEDIMENT AND EROSION CONTROL BASIN.
J.B.	JUNCTION BOX	T.S.T.	TEMPORARY SEDIMENT TRAP
JMT	JOHNSON MIRMIRAN AND THOMPSON	T.S.O.S.	TEMPORARY STONE OUTLET STRUCTURE
KV	KILOVOLT	TTCTA	TEMPORARY TRAFFIC CONTROL TYPICAL APPLICATION
L.F., LF	LINEAR FEET	TL	TRAVERSE LINE
LOD/L.O.D.	LIMIT OF DISTURBANCE	TYP.	TYPICAL
L.P./LP	LOW POINT	UG	UNDERGROUND
LT.	LEFT	UNK	UNKNOWN
LTG.	LIGHTING	V.C.	VERTICAL CURVE
MAC	MACADAM	V.C.L.	VERTICAL CURVE LENGTH
MAINT.	MAINTENANCE	W	WATER LINE
MAX.	MAXIMUM	W.B.	WESTBOUND ROADWAY
MDE	MARYLAND DEPARTMENT OF THE ENVIRONMENT	W/L	WEDGE AND/OR LEVEL
M.H./MH	MANHOLE	WM	WATER METER
MIN.	MINIMUM	WS	WATER SUPPLY
MRKG	MARKING	W.S.S.C.	WASHINGTON SANITARY SEWER COMMISSION
M.S.H.A./SHA	MARYLAND STATE HIGHWAY ADMINISTRATION	WV	WATER VALVE
N.A./N/A	NOT AVAILBLE, NOT APPLICABLE	Δ	DELTA ANGLE
N.B.	NORTHBOUND ROADWAY		

LEGEND

EXISTING

	UTILITY POLE
	CONTOUR
	STORM DRAIN PIPE
	MANHOLE
	INLET
	OVERHEAD ELECTRIC
	WATER MAIN
	GAS MAIN
	ELECTRIC LINE
	SANITARY SEWER PIPE
	ELEVATION
	ENDWALL
	TREE - EVERGREEN
	TREE - DECIDUOUS
	HEDGE LINE
	CHAIN LINK FENCE
	FARM TYPE FENCE
	WATER VALVE
	ELECTRICAL HANDBOX
	FIRE HYDRANT
	WOODS LINE
	GUARDRAIL
	UTILITY GUIDEWIRE
	MISC TRAFFIC SIGN
	TRAFFIC LIGHT
	TRAVERSE POINT
	GRADE BREAK LINE
	FLOW LINE
	WOODEN FENCE
	LIGHT POLE
	UNDERGROUND TELEPHONE LINE
	RIGHT-OF-WAY LINE
	ROAD EDGE
	ELECTRIC METER

PROPOSED

	LIMIT OF DISTURBANCE
	TREE - EVERGREEN
	TREE - DECIDUOUS
	PROPOSED LIGHT
	CONCRETE SIDEWALK
	FULL DEPTH PATCHING
	COMBINATION CURB & GUTTER
	6' CHAIN LINK FENCE
	ASPHALT REMOVAL
	SIDEWALK REMOVAL
	PROPOSED CONTOURS
	PROPOSED TYPE III BARRICADE



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DOUGLAS H. SIMMONS, PE


MONTGOMERY COUNTY
DEPARTMENT OF HOUSING AND COMMUNITY AFFAIRS
MONTGOMERY VILLAGE /SOUTH VILLAGE HOMES
LIGHTING AND SITE IMPROVEMENTS PROJECT

ABBREVIATIONS AND SYMBOLS


SCALE	NTS	ADVERTISED DATE	N/A	CONTRACT NO.
DESIGNED BY	RJS	COUNTY	MONTGOMERY COUNTY	
DRAWN BY	RJS	LOGMILE		
CHECKED BY	MTF			
DPS PERMIT				
DRAWING NO.	GN - 02	OF	03	SHEET NO. 2 OF 46

BY: Stratmeyer



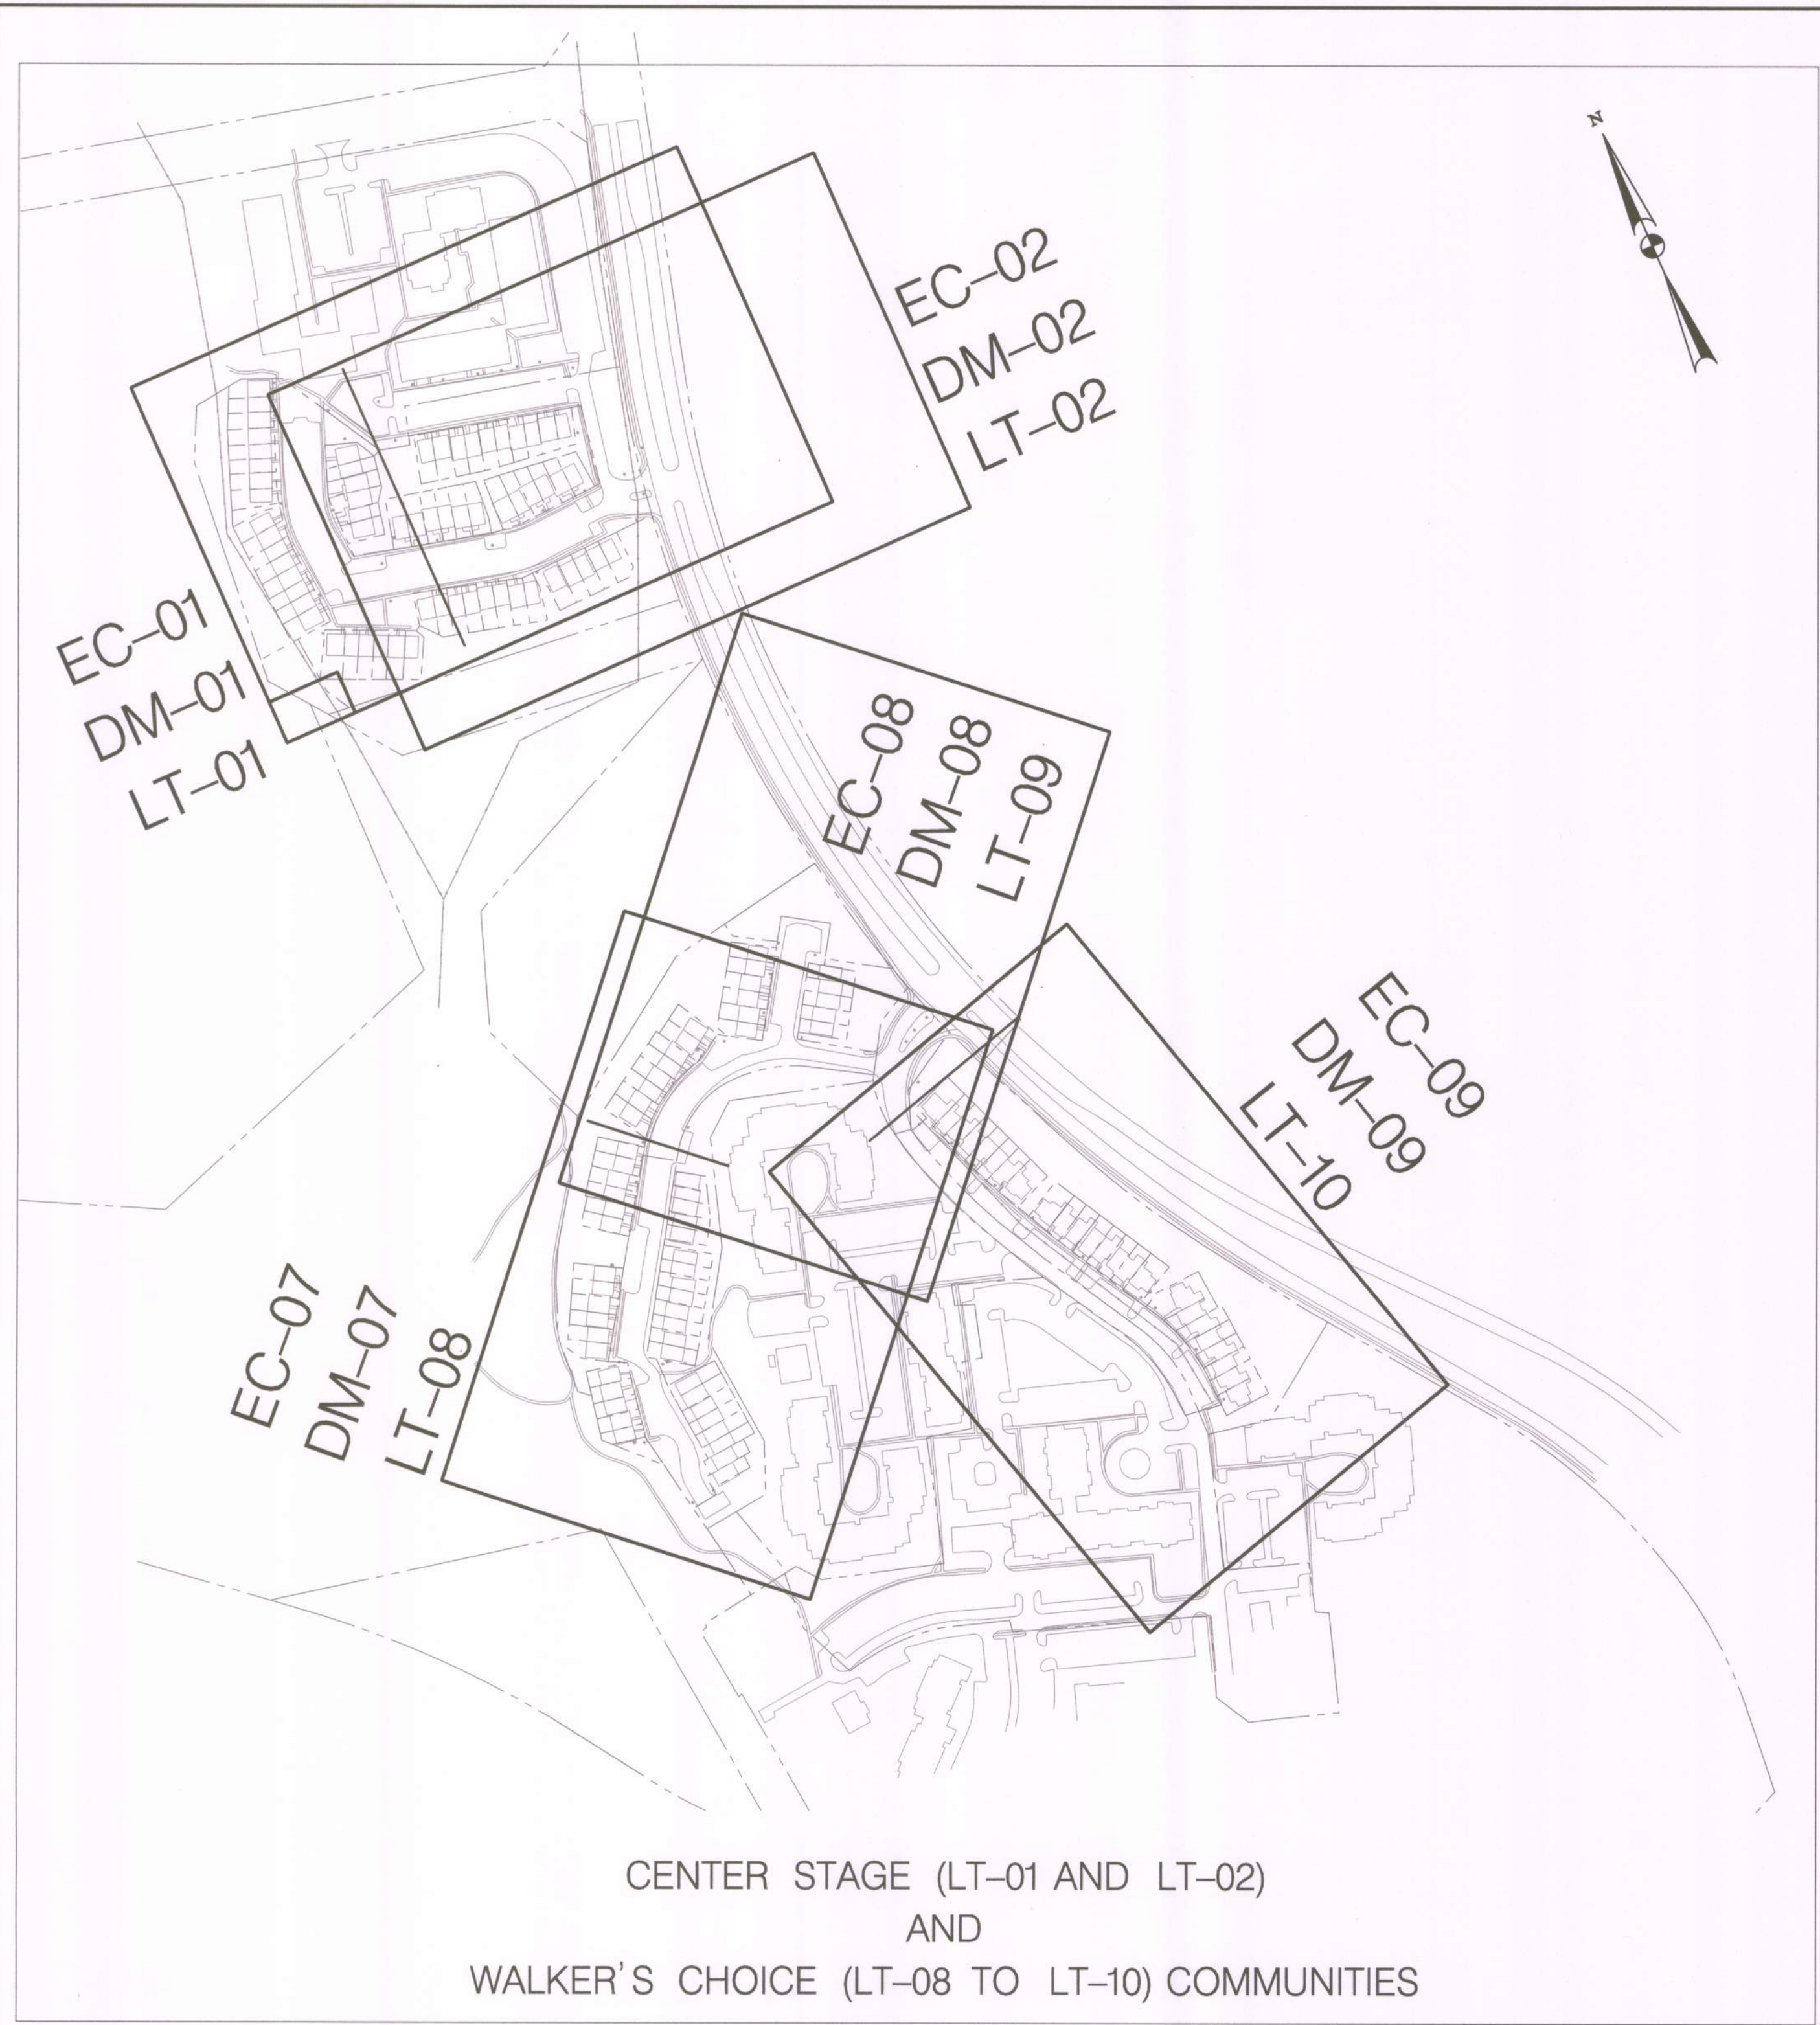


CENTER STAGE (LT-01 AND LT-02)
AND
WALKER'S CHOICE (LT-08 TO LT-10) COMMUNITIES

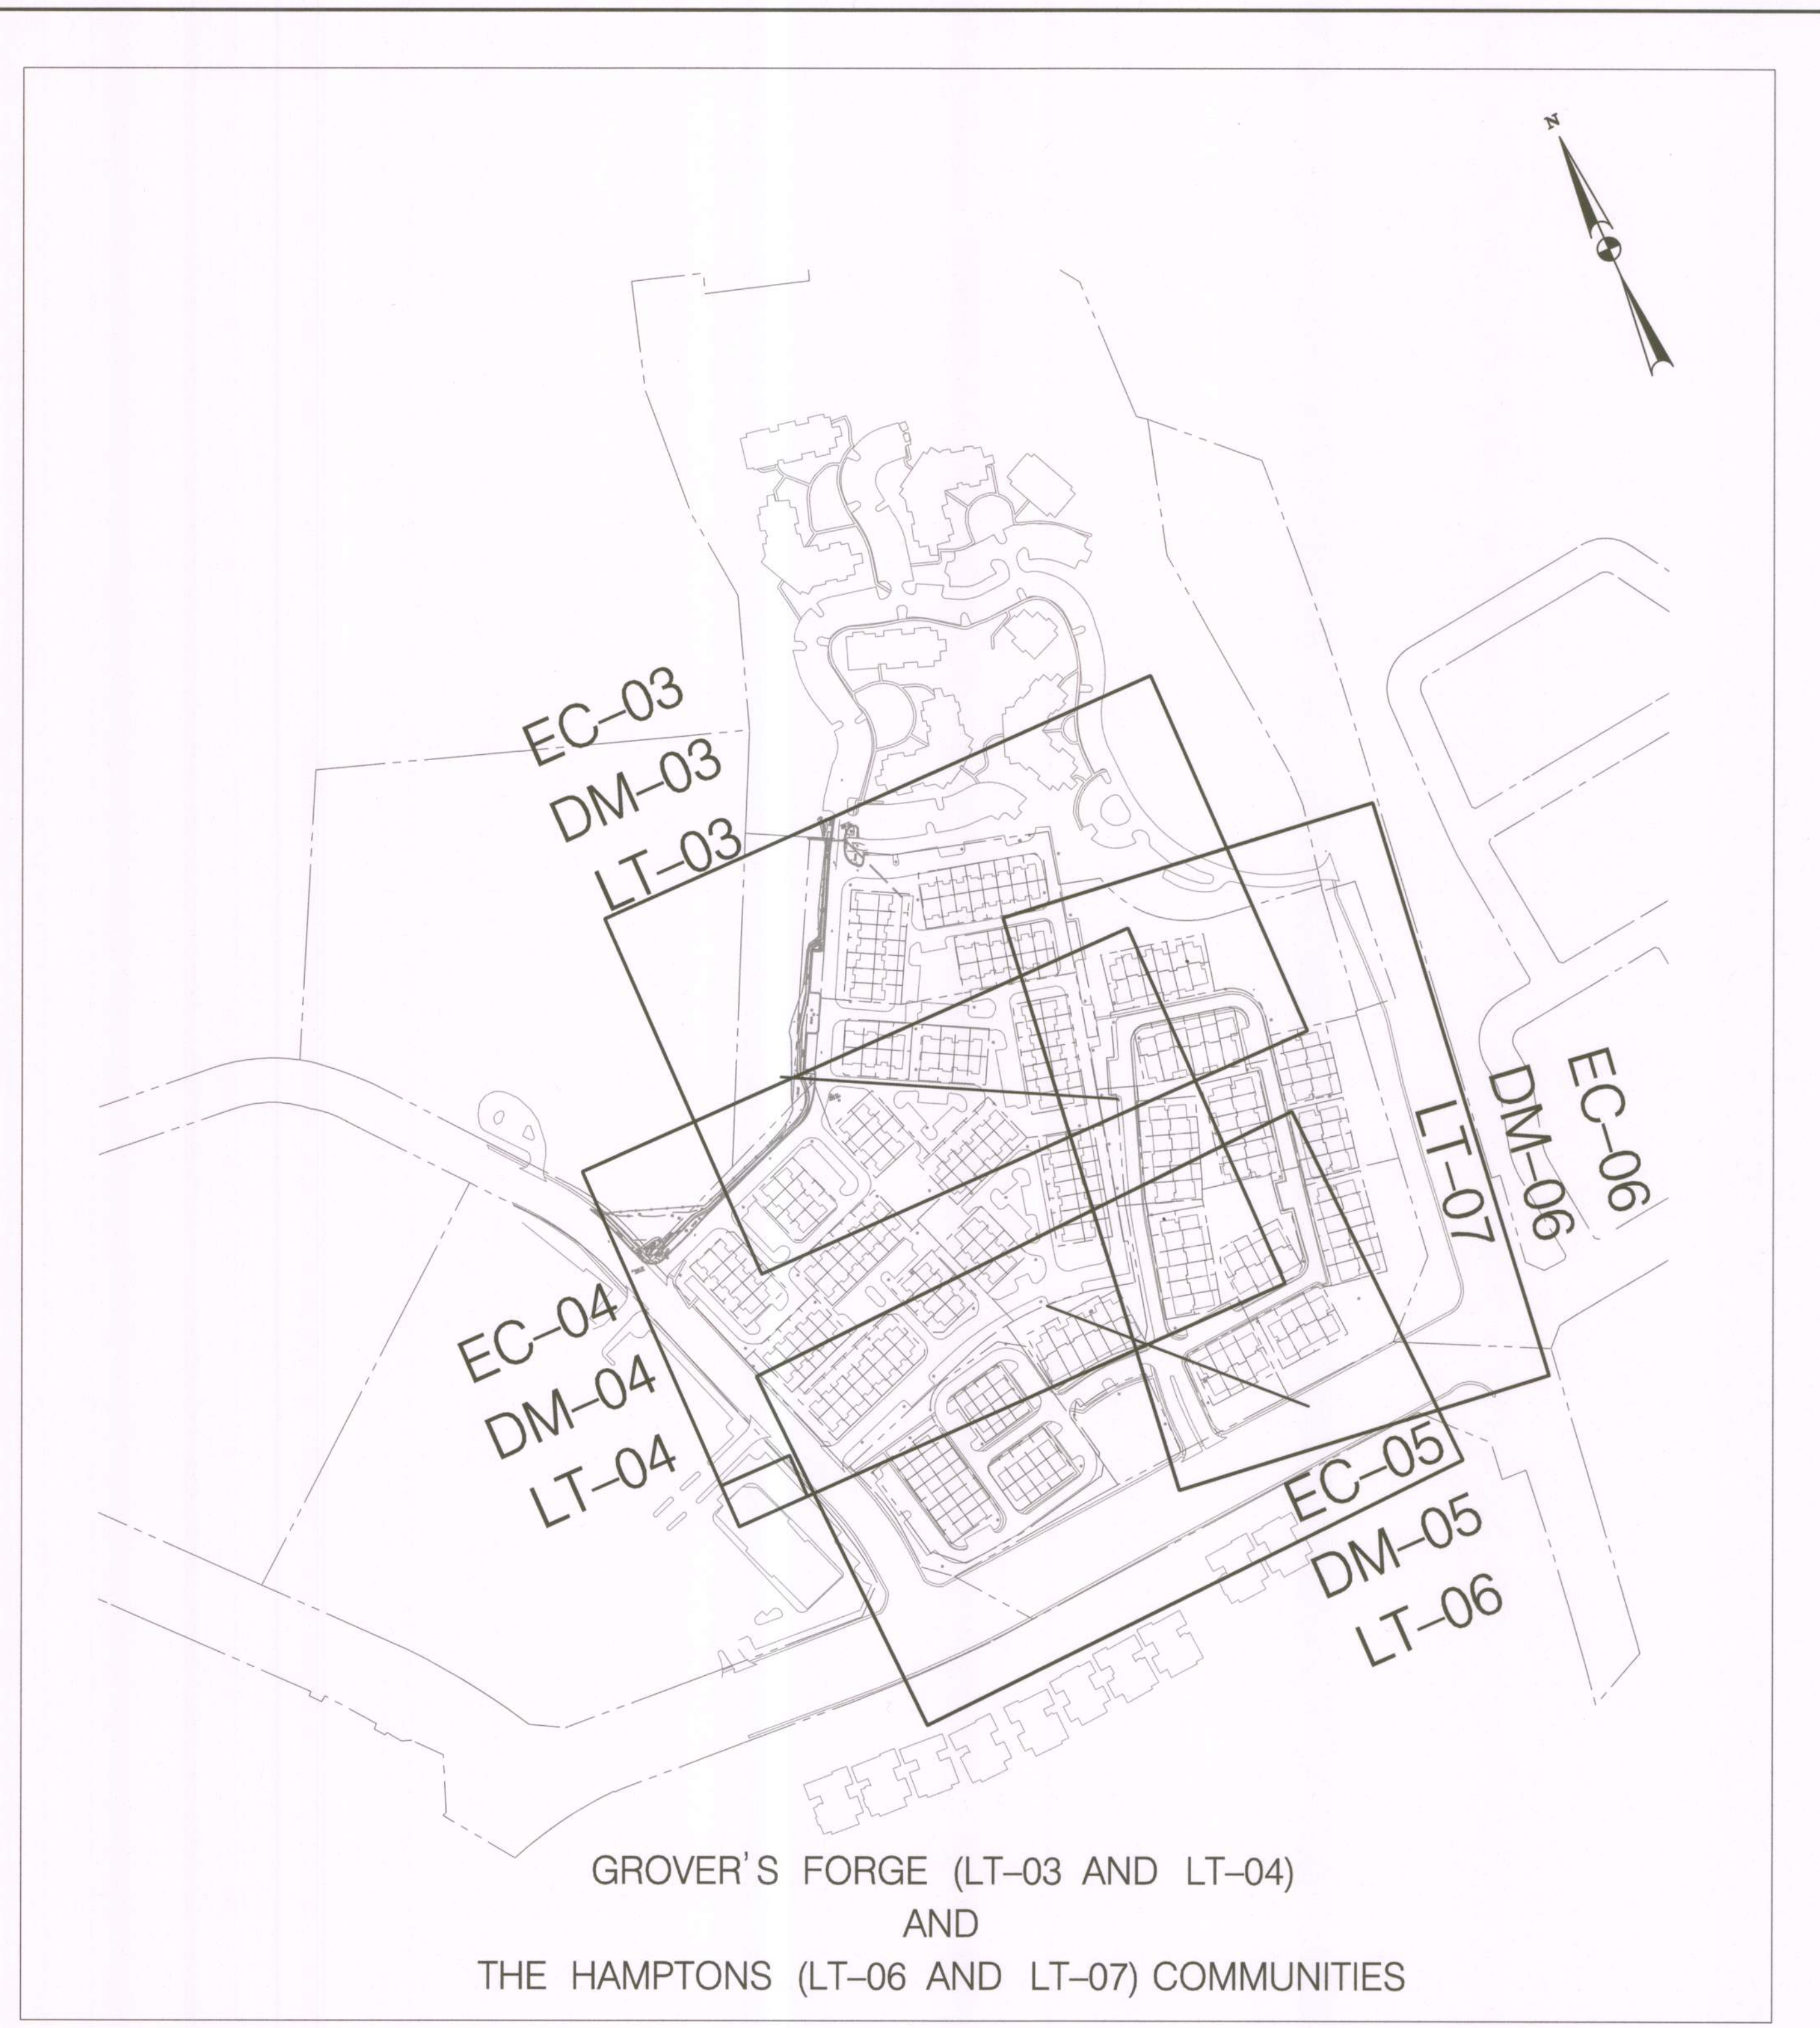

GROVER'S FORGE (LT-03 AND LT-04)
AND
THE HAMPTONS (LT-06 AND LT-07) COMMUNITIES

BY: Stratmeyer -

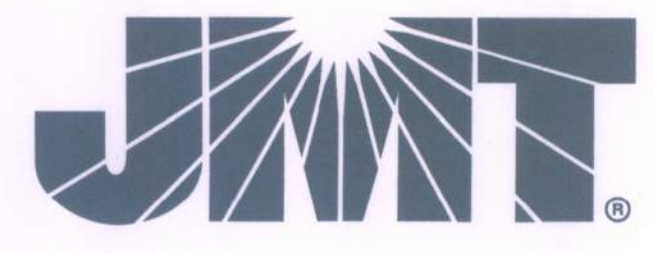




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PROFESSIONAL CERTIFICATION
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[Signature]
DOUGLAS H. SIMMONS, PE

MONTGOMERY COUNTY
DEPARTMENT OF HOUSING AND COMMUNITY AFFAIRS
MONTGOMERY VILLAGE /SOUTH VILLAGE HOMES
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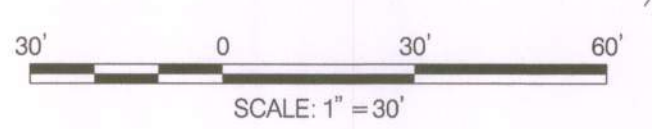
KEY SHEET			
SCALE	200	SCALE	ADVERTISED DATE
DESIGNED BY	RJS	COUNTY	MONTGOMERY COUNTY
DRAWN BY	RJS	LOGMILE	
CHECKED BY	JJR		
DPS PERMIT			
DRAWING NO.	GN - 03	OF	03
SHEET NO.	3	OF	46



MATCH LINE - SEE SHEET EC-02

MONTGOMERY VILLAGE AVE.

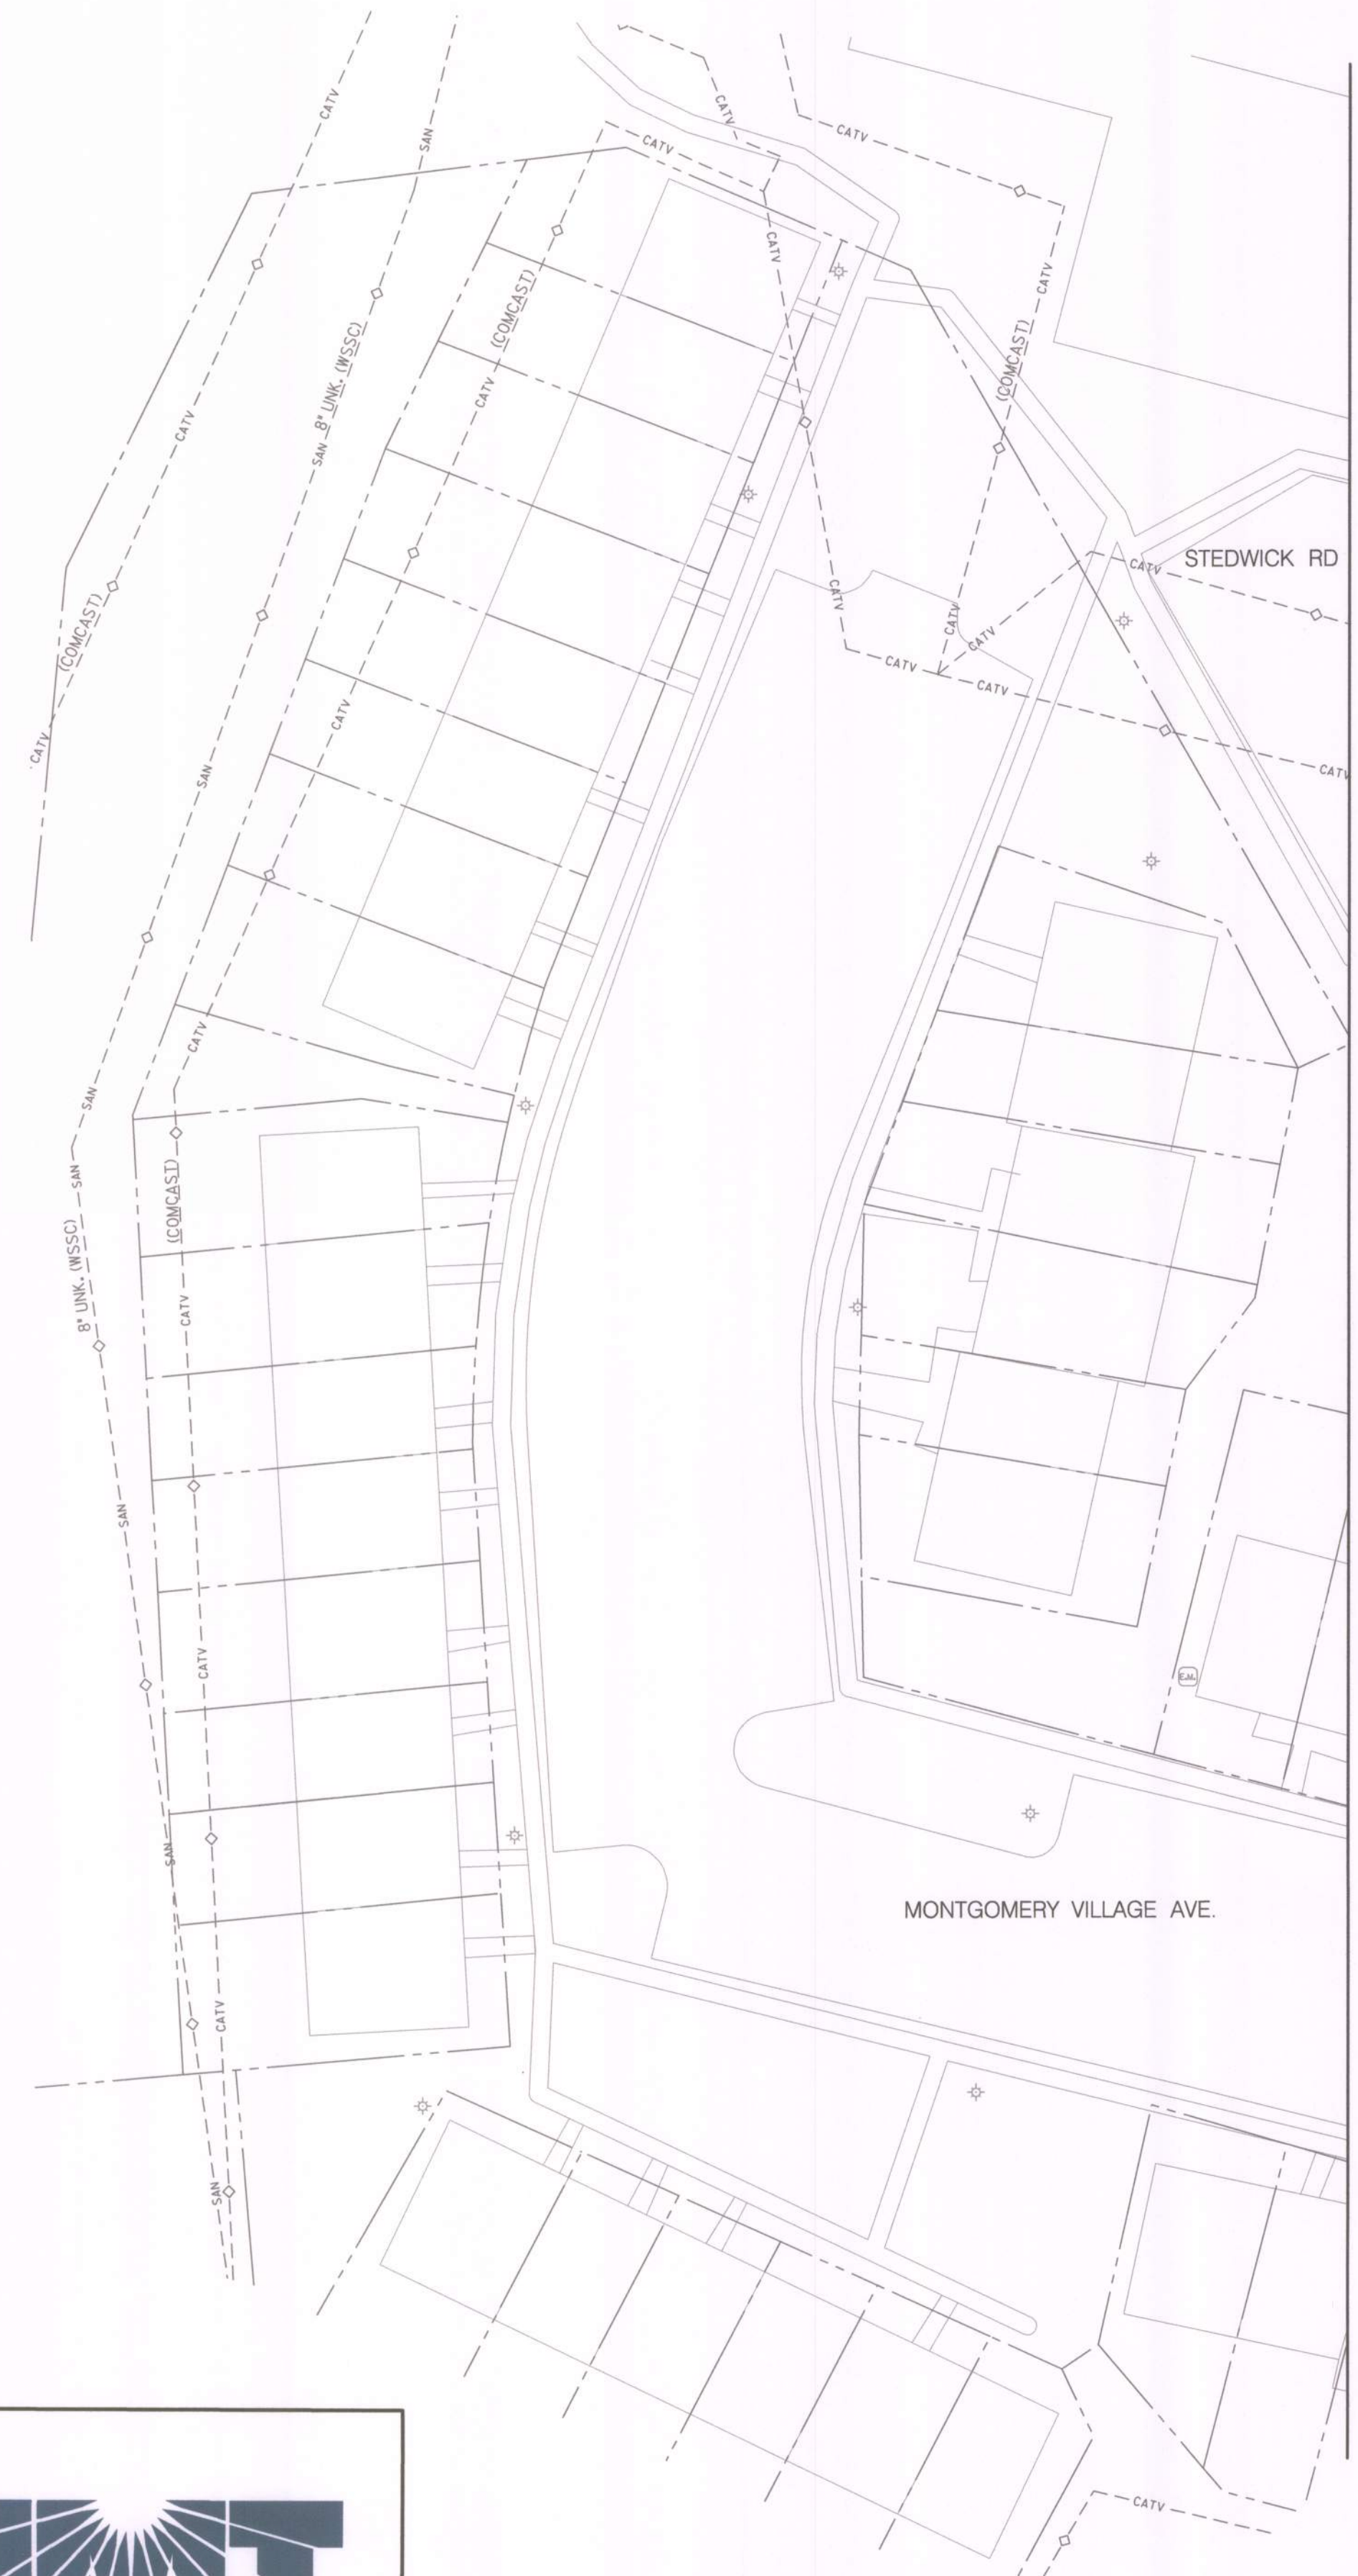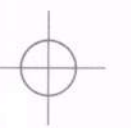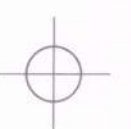STEDWICK RD



BY: Stratmeyer -

PLOTTED: Wednesday, May 22, 2019 AT 08:19 AM
 FILE: Q:\2013\130707_003_Montgomery_Village_CADD\pEC-MontVillage.dgn



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Douglas H. Simmons
 DOUGLAS H. SIMMONS, PE



MONTGOMERY COUNTY
 DEPARTMENT OF HOUSING AND COMMUNITY AFFAIRS
 MONTGOMERY VILLAGE / SOUTH VILLAGE HOMES
 LIGHTING AND SITE IMPROVEMENTS PROJECT

EXISTING CONDITIONS PLAN - CENTER STAGE

SCALE	30' SCALE	ADVERTISED DATE	N/A	CONTRACT NO.	
DESIGNED BY	RJS	COUNTY	MONTGOMERY COUNTY		
DRAWN BY	RJS	LOGMILE			
CHECKED BY	JJR				
DPS PERMIT					
DRAWING NO.	EC - 01	OF	09	SHEET NO.	4 OF 46



MATCH LINE - SEE SHEET EC-01

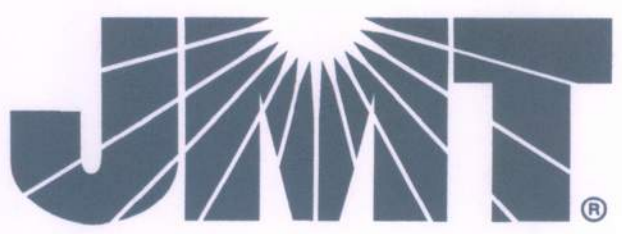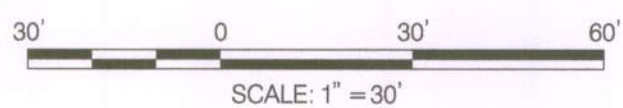

BY: Stratmeyer

PLOTTED: Wednesday, May 22, 2019 AT 08:20 AM
FILE: Q:\2019\130707_003_Montgomery_Village_CADD\pEC-MontVillage.dgn



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[Signature]
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DEPARTMENT OF HOUSING AND COMMUNITY AFFAIRS
MONTGOMERY VILLAGE /SOUTH VILLAGE HOMES
LIGHTING AND SITE IMPROVEMENTS PROJECT

EXISTING CONDITIONS PLAN - CENTER STAGE	
SCALE <u>30</u> SCALE <u>ADVERTISED</u> DATE <u>N/A</u> CONTRACT NO. _____	
DESIGNED BY <u>RJS</u> COUNTY <u>MONTGOMERY COUNTY</u>	
DRAWN BY <u>RJS</u> LOGMILE _____	
CHECKED BY <u>JJR</u>	
DPS PERMIT _____	
DRAWING NO. EC - 02 OF 09	SHEET NO. 5 OF 46





MATCH LINE - SEE SHEET EC-04



PROFESSIONAL CERTIFICATION
I HEREBY CERTIFY THAT THESE DOCUMENTS WERE PREPARED OR APPROVED BY ME, AND THAT I AM A DULY LICENSED PROFESSIONAL ENGINEER UNDER THE STATE LAWS OF THE STATE OF MARYLAND, LICENSE NO. 17673, EXPIRATION DATE: 01/29/2020.
[Signature]
DOUGLAS H. SIMMONS, PE

MONTGOMERY COUNTY
DEPARTMENT OF HOUSING AND COMMUNITY AFFAIRS
MONTGOMERY VILLAGE / SOUTH VILLAGE HOMES
LIGHTING AND SITE IMPROVEMENTS PROJECT

EXISTING CONDITIONS PLAN - GROVER'S FORGE	
SCALE <u>30</u> SCALE ADVERTISED DATE <u> </u> N / A CONTRACT NO. <u> </u>	
DESIGNED BY <u> RJS </u> COUNTY <u> MONTGOMERY COUNTY </u>	
DRAWN BY <u> RJS </u> LOGMILE <u> </u>	
CHECKED BY <u> JJR </u>	
DPS PERMIT <u> </u>	
DRAWING NO. EC - 03 OF 09	SHEET NO. 6 OF 46

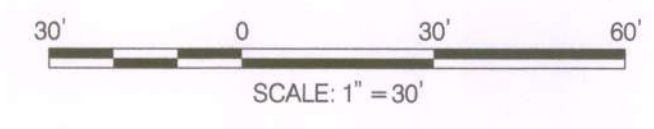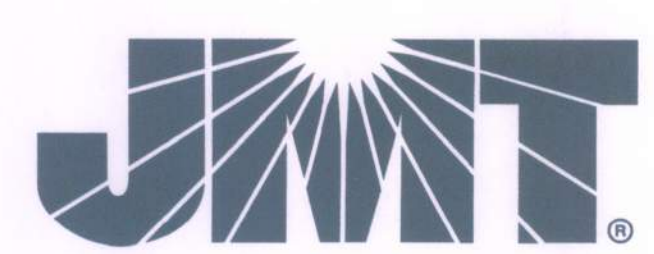

BY: Stratmeyer



PROFESSIONAL CERTIFICATION

I HEREBY CERTIFY THAT THESE DOCUMENTS WERE PREPARED OR APPROVED BY ME, AND THAT I AM A DULY LICENSED PROFESSIONAL ENGINEER UNDER THE STATE LAWS OF THE STATE OF MARYLAND, LICENSE NO. 17673, EXPIRATION DATE: 01/29 /2020.

DHS 4/25/19
DOUGLAS H. SIMMONS, PE


MONTGOMERY COUNTY
DEPARTMENT OF HOUSING AND COMMUNITY AFFAIRS
MONTGOMERY VILLAGE /SOUTH VILLAGE HOMES
LIGHTING AND SITE IMPROVEMENTS PROJECT

EXISTING CONDITIONS PLAN - GROVER'S FORGE

SCALE 30 SCALE ADVERTISED DATE N/A CONTRACT NO. _____

DESIGNED BY FJS COUNTY MONTGOMERY COUNTY
DRAWN BY FJS LOGMILE _____
CHECKED BY JJR
DPS PERMIT _____


DRAWING NO. **EC - 04** OF **09** SHEET NO. 7 OF 46

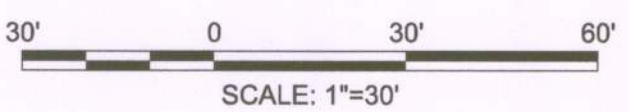

BY: Stratmeyer -




MATCH LINE - SEE SHEET EC-06

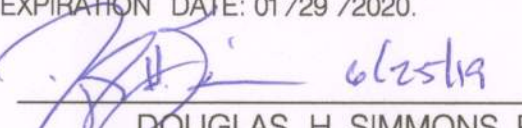
PROFESSIONAL CERTIFICATION
 I HEREBY CERTIFY THAT THESE DOCUMENTS WERE PREPARED OR APPROVED BY ME, AND THAT I AM A DULY LICENSED PROFESSIONAL ENGINEER UNDER THE STATE LAWS OF THE STATE OF MARYLAND, LICENSE NO. 17673, EXPIRATION DATE: 01/29 /2020.

 DOUGLAS H. SIMMONS, PE

MONTGOMERY COUNTY
 DEPARTMENT OF HOUSING AND COMMUNITY AFFAIRS
 MONTGOMERY VILLAGE /SOUTH VILLAGE HOMES
 LIGHTING AND SITE IMPROVEMENTS PROJECT


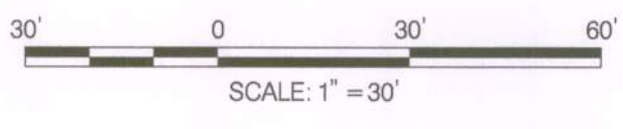
EXISTING CONDITIONS PLAN - THE HAMPTONS
 SCALE 30 SCALE ADVERTISED DATE N/A CONTRACT NO. _____
 DESIGNED BY RJS COUNTY MONTGOMERY COUNTY
 DRAWN BY RJS LOGMILE _____
 CHECKED BY JJR
 DPS PERMIT _____
 DRAWING NO. **EC - 05** OF **09** SHEET NO. **8** OF **46**

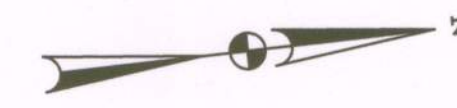

BY: Stratmeyer -



MATCH LINE - SEE SHEET EC-05

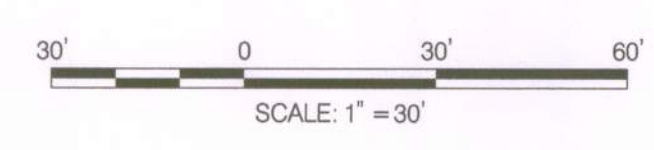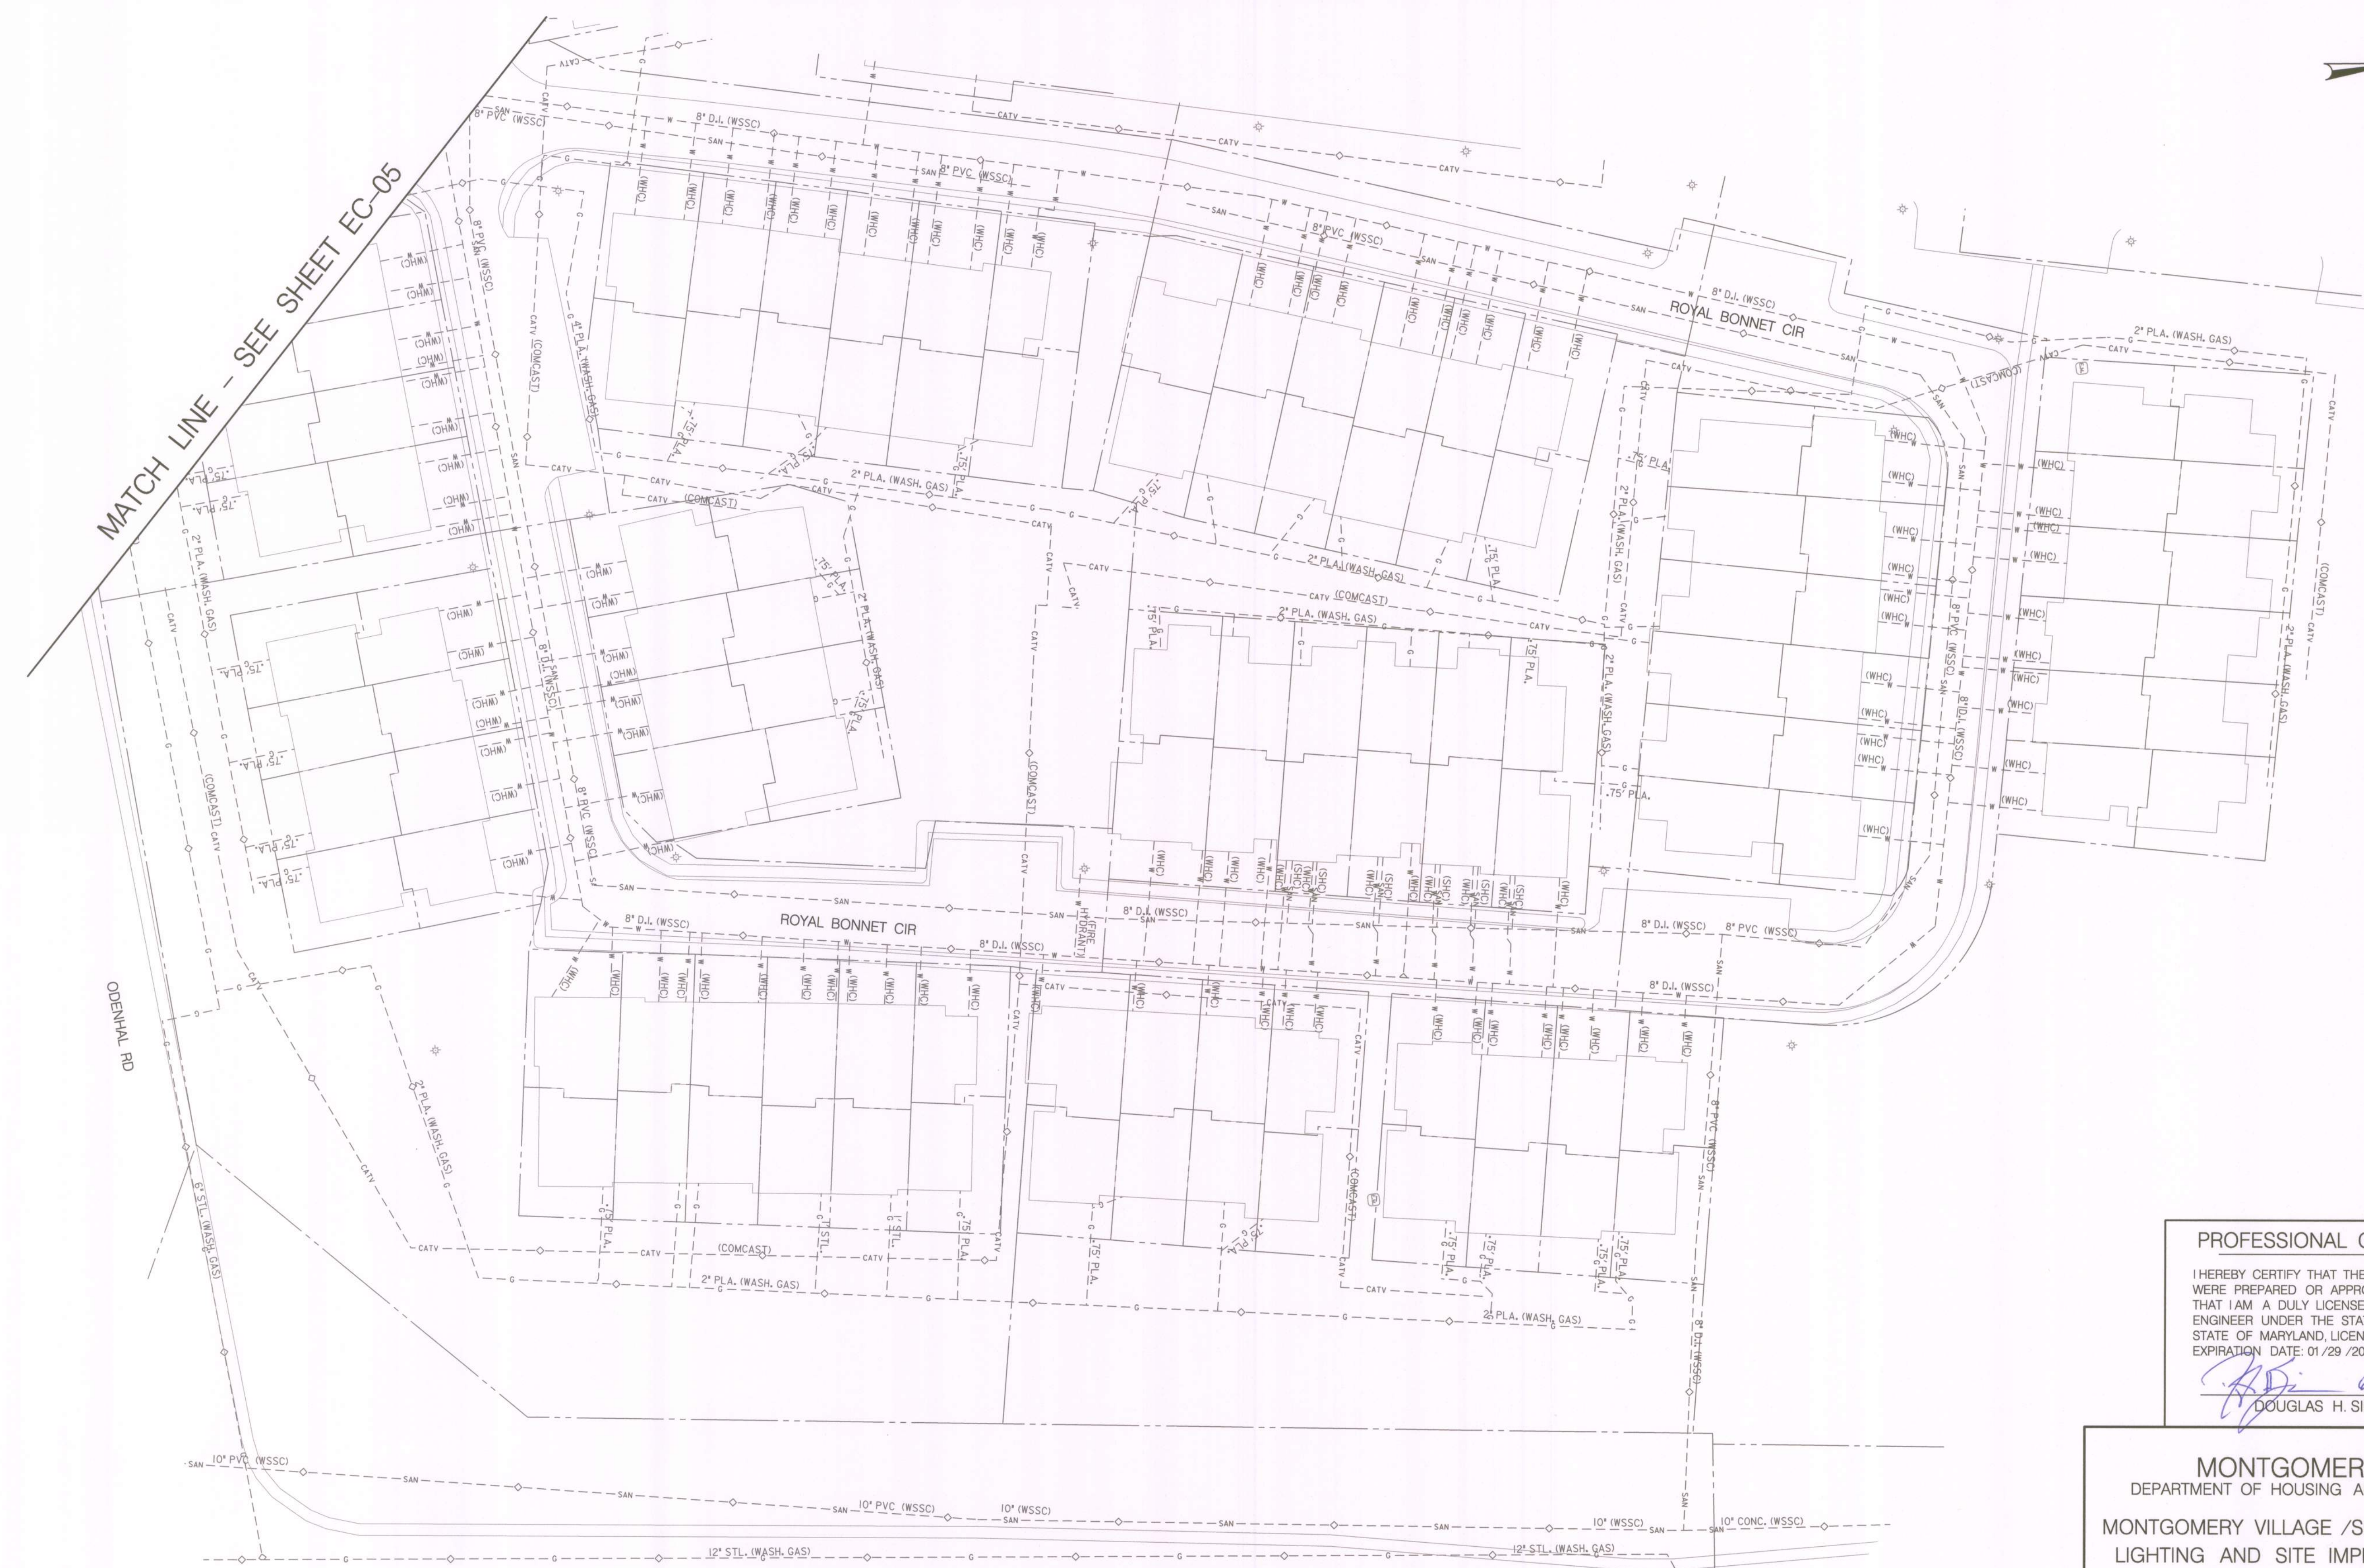

PROFESSIONAL CERTIFICATION

I HEREBY CERTIFY THAT THESE DOCUMENTS WERE PREPARED OR APPROVED BY ME, AND THAT I AM A DULY LICENSED PROFESSIONAL ENGINEER UNDER THE STATE LAWS OF THE STATE OF MARYLAND, LICENSE NO. 17873, EXPIRATION DATE: 01/29/2020.


DH Simmons
DOUGLAS H. SIMMONS, PE

MONTGOMERY COUNTY
DEPARTMENT OF HOUSING AND COMMUNITY AFFAIRS
MONTGOMERY VILLAGE /SOUTH VILLAGE HOMES
LIGHTING AND SITE IMPROVEMENTS PROJECT


EXISTING CONDITIONS PLAN - THE HAMPTONS	
SCALE 30 SCALE ADVERTISED DATE N/A CONTRACT NO.	
DESIGNED BY RJS	COUNTY MONTGOMERY COUNTY
DRAWN BY RJS	LOGMILE
CHECKED BY JJR	
DPS PERMIT	
DRAWING NO. EC - 06 OF 09	SHEET NO. 9 OF 46



BY: Stratmeyer -

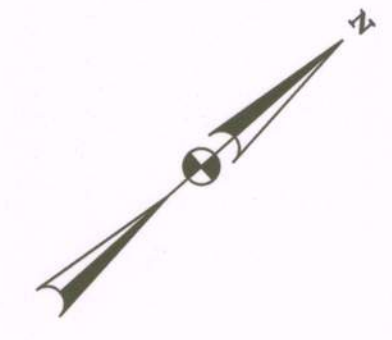

MATCH LINE - SEE SHEET EC-08

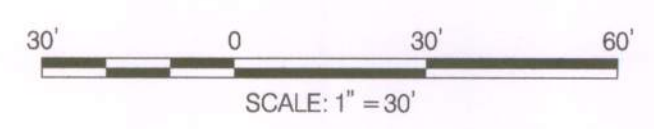

PROFESSIONAL CERTIFICATION

I HEREBY CERTIFY THAT THESE DOCUMENTS WERE PREPARED OR APPROVED BY ME, AND THAT I AM A DULY LICENSED PROFESSIONAL ENGINEER UNDER THE STATE LAWS OF THE STATE OF MARYLAND, LICENSE NO. 17673, EXPIRATION DATE-01/29/2020.

DOUGLAS H. SIMMONS
DOUGLAS H. SIMMONS, PE

MONTGOMERY COUNTY
DEPARTMENT OF HOUSING AND COMMUNITY AFFAIRS
MONTGOMERY VILLAGE /SOUTH VILLAGE HOMES
LIGHTING AND SITE IMPROVEMENTS PROJECT

EXISTING CONDITIONS PLAN - WALKER'S CHOICE


SCALE 30' SCALE ADVERTISED DATE N /A CONTRACT NO.


DESIGNED BY RJS COUNTY MONTGOMERY COUNTY
DRAWN BY RJS LOGMILE

CHECKED BY JJR
DPS PERMIT

DRAWING NO. **EC - 07** OF **09** SHEET NO. 10 OF 46

BY: Stratmeyer -

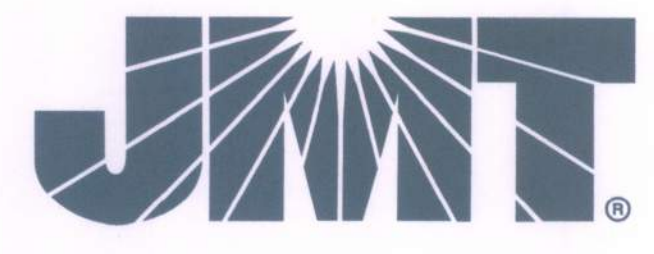

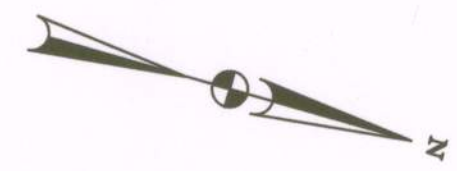

MATCH LINE - SEE SHEET EC-08

MONTGOMERY COUNTY
DEPARTMENT OF HOUSING AND COMMUNITY AFFAIRS
MONTGOMERY VILLAGE /SOUTH VILLAGE HOMES
LIGHTING AND SITE IMPROVEMENTS PROJECT

EXISTING CONDITIONS PLAN - WALKER'S CHOICE

SCALE 30 SCALE ADVERTISED DATE N/A CONTRACT NO.

DESIGNED BY RJS COUNTY MONTGOMERY COUNTY

DRAWN BY RJS LOGMILE

CHECKED BY JJR


DPS PERMIT

DRAWING NO. EC - 09 OF 09 SHEET NO. 12 OF 46

PROFESSIONAL CERTIFICATION


I HEREBY CERTIFY THAT THESE DOCUMENTS WERE PREPARED OR APPROVED BY ME, AND THAT I AM A DULY LICENSED PROFESSIONAL ENGINEER UNDER THE STATE LAWS OF THE STATE OF MARYLAND, LICENSE NO. 17673, EXPIRATION DATE: 01/29/2020.

[Signature]
DOUGLAS H. SIMMONS, PE

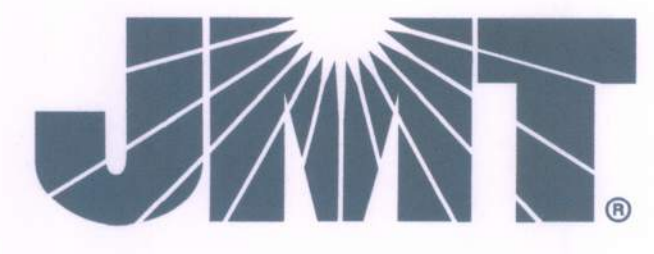

30' 0 30' 60'
SCALE: 1"=30'

BY: Stratmeyer -

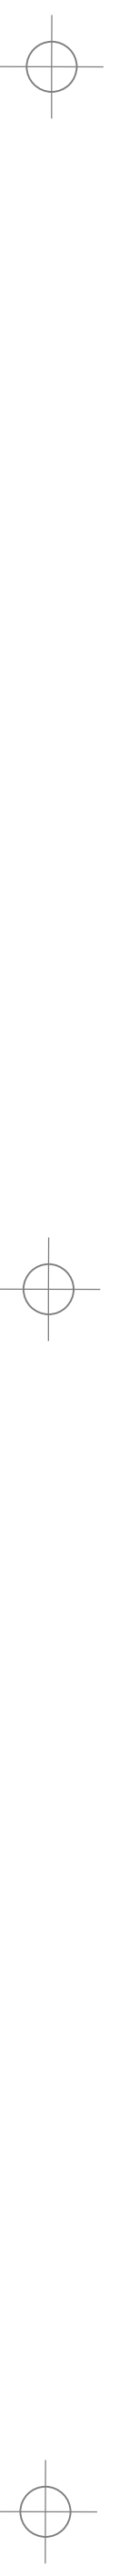


KEY NOTES

- (A) REMOVE EXISTING POLE, ALL ASSOCIATED EQUIPMENT, AND FOUNDATION 12 IN. BELOW GRADE AND BACKFILL. SEE LIGHTING DETAILS; SHEET DE-01 AND DE-02.


PLAN NOTES

- DISCONNECT AND REMOVE EXISTING CABLE, CAP AND ABANDON EXISTING CONDUIT.
- EXISTING LIGHTING MUST REMAIN OPERATIONAL UNTIL PROPOSED LIGHTING IS INSTALLED AND APPROVED BY THE COUNTY.
- REPAIR OR REPLACE ANY PAVEMENT DISTURBED AS A RESULT OF LIGHTING EQUIPMENT REMOVAL AT NO ADDITIONAL COST TO THE COUNTY.

EQUIPMENT SCHEDULE			
CATEGORY CODE	DESCRIPTION	UNIT	QUANTITY
860296	REMOVE AND DISPOSE OF LIGHTING STRUCTURE	EA	9

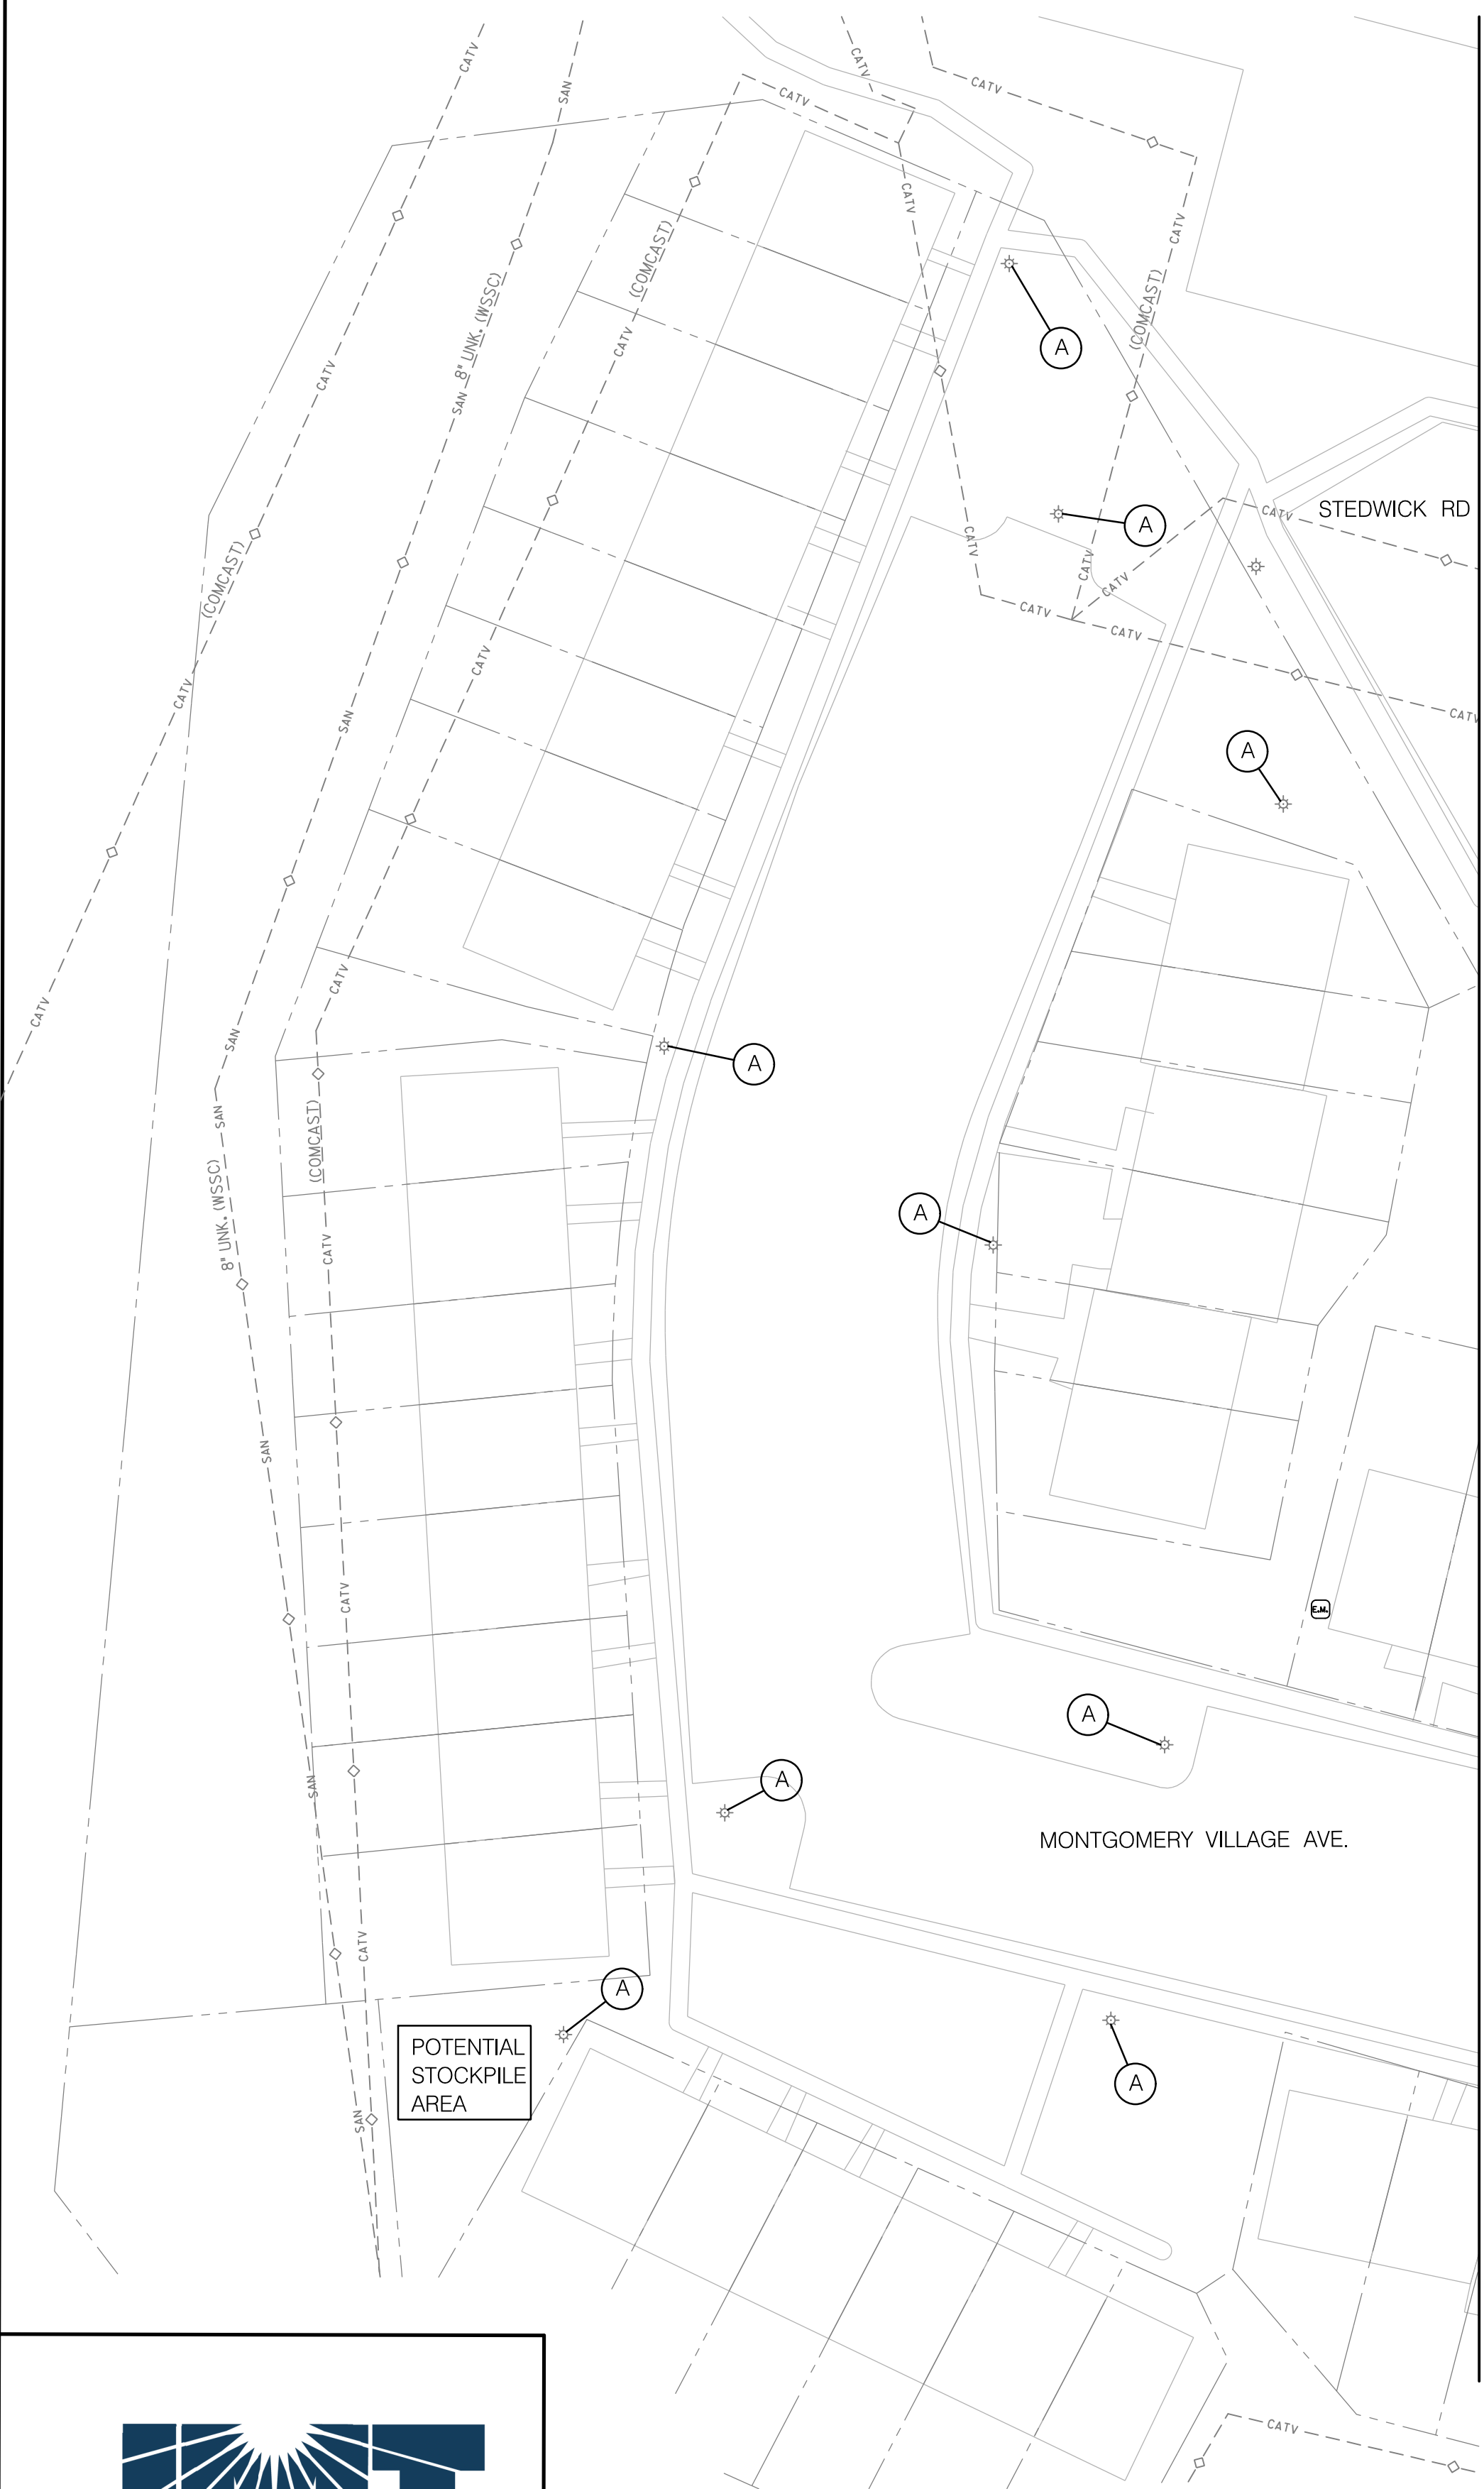


MATCH LINE - SEE SHEET DM-02

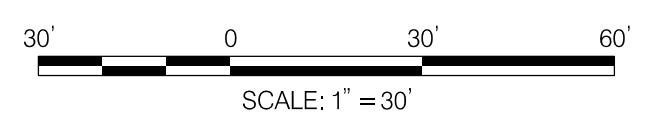

BY: aborkiewicz -

PLOTTED: Thursday, August 29, 2019 AT 11:33 AM
FILE: Q:\2013\130707_003_Montgomery_Village_ICADD\pdm-Baseline.dgn

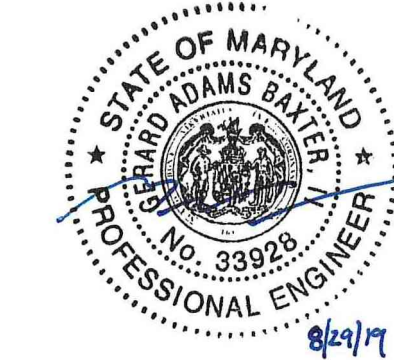

PROFESSIONAL CERTIFICATION

I HEREBY CERTIFY THAT THESE DOCUMENTS WERE PREPARED OR APPROVED BY ME, AND THAT I AM A DULY LICENSED PROFESSIONAL ENGINEER UNDER THE STATE LAWS OF THE STATE OF MARYLAND, LICENSE NO. 33928, EXPIRATION DATE: 01/15 /2021.

GERARD ADAMS BAXTER, II, PE

MONTGOMERY COUNTY
DEPARTMENT OF HOUSING AND COMMUNITY AFFAIRS
MONTGOMERY VILLAGE /SOUTH VILLAGE HOMES
LIGHTING AND SITE IMPROVEMENTS PROJECT

DEMOLITION PLAN - CENTER STAGE

SCALE	30' SCALE	ADVERTISED DATE	N / A	CONTRACT NO.	
DESIGNED BY	AHB	COUNTY	MONTGOMERY COUNTY		
DRAWN BY	AHB	LOGMILE			
CHECKED BY	GAB				
DPS PERMIT					
DRAWING NO.	DM-01	OF	09	SHEET NO.	13 OF 46



KEY NOTES

- (A) REMOVE EXISTING POLE, ALL ASSOCIATED EQUIPMENT, AND FOUNDATION 12 IN. BELOW GRADE AND BACKFILL. SEE LIGHTING DETAILS; SHEET DE-01 AND DE-02.

PLAN NOTES

- DISCONNECT AND REMOVE EXISTING CABLE, CAP AND ABANDON EXISTING CONDUIT.
- EXISTING LIGHTING MUST REMAIN OPERATIONAL UNTIL PROPOSED LIGHTING IS INSTALLED AND APPROVED BY THE COUNTY.
- REPAIR OR REPLACE ANY PAVEMENT DISTURBED AS A RESULT OF LIGHTING EQUIPMENT REMOVAL AT NO ADDITIONAL COST TO THE COUNTY.

EQUIPMENT SCHEDULE			
CATEGORY CODE	DESCRIPTION	UNIT	QUANTITY
860296	REMOVE AND DISPOSE OF LIGHTING STRUCTURE	EA	9

MATCH LINE - SEE SHEET DM-01



PROFESSIONAL CERTIFICATION

I HEREBY CERTIFY THAT THESE DOCUMENTS WERE PREPARED OR APPROVED BY ME, AND THAT I AM A DULY LICENSED PROFESSIONAL ENGINEER UNDER THE STATE LAWS OF THE STATE OF MARYLAND, LICENSE NO. 33928, EXPIRATION DATE: 01/15 /2021.

GERARD ADAMS BAXTER, II, PE

MONTGOMERY COUNTY
DEPARTMENT OF HOUSING AND COMMUNITY AFFAIRS
MONTGOMERY VILLAGE /SOUTH VILLAGE HOMES
LIGHTING AND SITE IMPROVEMENTS PROJECT

DEMOLITION PLAN - CENTER STAGE

SCALE 30 SCALE ADVERTISED DATE N/A CONTRACT NO.


DESIGNED BY AHB COUNTY MONTGOMERY COUNTY

DRAWN BY AHB LOGMILE

CHECKED BY GAB

DPS PERMIT

DRAWING NO. DM-02 OF 09 SHEET NO. 14 OF 46

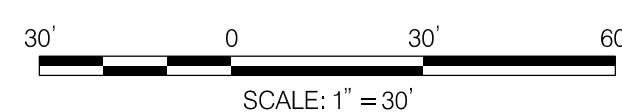

BY: abortkiewicz -

KEY NOTES

- (A) REMOVE EXISTING POLE ALL ASSOCIATED EQUIPMENT, AND FOUNDATION 12 IN. BELOW GRADE AND BACKFILL. SEE LIGHTING DETAILS; SHEET DE-01 AND DE-02.
- (B) REMOVE AND DISPOSE OF EXISTING ELECTRICAL SERVICE.
- (C) REMOVE AND DISPOSE OF EXISTING SIDEWALK ASPHALT. SEE ROADWAY PLAN SHEET PS-01 FOR SIDEWALK REPLACEMENT.
- (D) REMOVE AND DISPOSE OF EXISTING CONCRETE SIDEWALK FOR ADA COMPLIANT RAMPS. SEE ROADWAY PLAN SHEET PS-01 FOR SIDEWALK REPLACEMENT.
- (E) REMOVE AND DISPOSE OF EXISTING SPLIT RAIL FENCE. SEE ROADWAY PLAN SHEET PS-01 FOR FENCE REPLACEMENT

PLAN NOTES

1. DISCONNECT AND REMOVE EXISTING CABLE. CAP AND ABANDON EXISTING CONDUIT.
2. EXISTING LIGHTING MUST REMAIN OPERATIONAL UNTIL PROPOSED LIGHTING IS INSTALLED AND APPROVED BY THE COUNTY.
3. REPAIR OR REPLACE ANY PAVEMENT DISTURBED AS A RESULT OF LIGHTING EQUIPMENT REMOVAL AT NO ADDITIONAL COST TO THE COUNTY.



EQUIPMENT SCHEDULE			
CATEGORY CODE	DESCRIPTION	UNIT	QUANTITY
695190	REMOVE AND DISPOSE OF EXISTING FENCE	LF	231
860296	REMOVE AND DISPOSE OF LIGHTING STRUCTURE	EA	20
873115	REMOVE ELECTRICAL SERVICE	EA	1



MATCH LINE - SEE SHEET DM-04

POTENTIAL STOCKPILE AREA

POTENTIAL STOCKPILE AREA

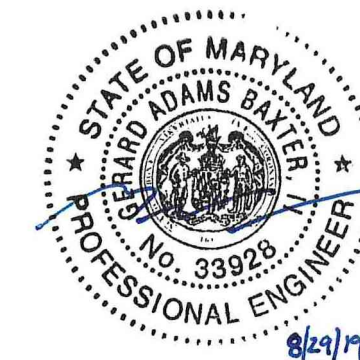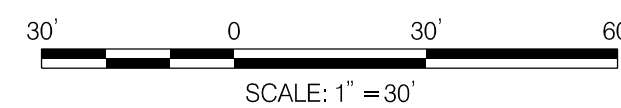

PROFESSIONAL CERTIFICATION

I HEREBY CERTIFY THAT THESE DOCUMENTS WERE PREPARED OR APPROVED BY ME, AND THAT I AM A DULY LICENSED PROFESSIONAL ENGINEER UNDER THE STATE LAWS OF THE STATE OF MARYLAND, LICENSE NO. 33928, EXPIRATION DATE: 01/15/2021.

GERARD ADAMS BAXTER, II, PE

MONTGOMERY COUNTY
DEPARTMENT OF HOUSING AND COMMUNITY AFFAIRS
MONTGOMERY VILLAGE /SOUTH VILLAGE HOMES
LIGHTING AND SITE IMPROVEMENTS PROJECT

DEMOLITION PLAN - GROVER'S FORGE

SCALE 30 SCALE ADVERTISED DATE N/A CONTRACT NO. _____

DESIGNED BY AHB COUNTY MONTGOMERY COUNTY
DRAWN BY AHB LOGMILE _____
CHECKED BY GAB
DPS PERMIT _____

DRAWING NO. **DM-03** OF **09** SHEET NO. 15 OF 46

BY: abortkiewicz -

PLAN NOTES

1. DISCONNECT AND REMOVE EXISTING CABLE, CAP AND ABANDON EXISTING CONDUIT.
2. EXISTING LIGHTING MUST REMAIN OPERATIONAL UNTIL PROPOSED LIGHTING IS INSTALLED AND APPROVED BY THE COUNTY.
3. REPAIR OR REPLACE ANY PAVEMENT DISTURBED AS A RESULT OF LIGHTING EQUIPMENT REMOVAL AT NO ADDITIONAL COST TO THE COUNTY.

KEY NOTES

- (A) REMOVE EXISTING POLE, ALL ASSOCIATED EQUIPMENT, AND FOUNDATION 12 IN. BELOW GRADE AND BACKFILL. SEE LIGHTING DETAILS; SHEET DE-01 AND DE-02.
- (B) REMOVE AND DISPOSE OF EXISTING ELECTRICAL SERVICE.
- (C) REMOVE AND DISPOSE OF EXISTING SIDEWALK ASPHALT. SEE ROADWAY PLAN SHEET CP-01 FOR SIDEWALK REPLACEMENT.



EQUIPMENT SCHEDULE

CATEGORY CODE	DESCRIPTION	UNIT	QUANTITY
860296	REMOVE AND DISPOSE OF LIGHTING STRUCTURE	EA	32
873115	REMOVE ELECTRICAL SERVICE	EA	1

MATCH LINE - SEE SHEET DM-03

POTENTIAL STOCKPILE AREA

POTENTIAL STOCKPILE AREA

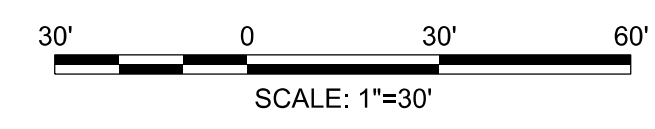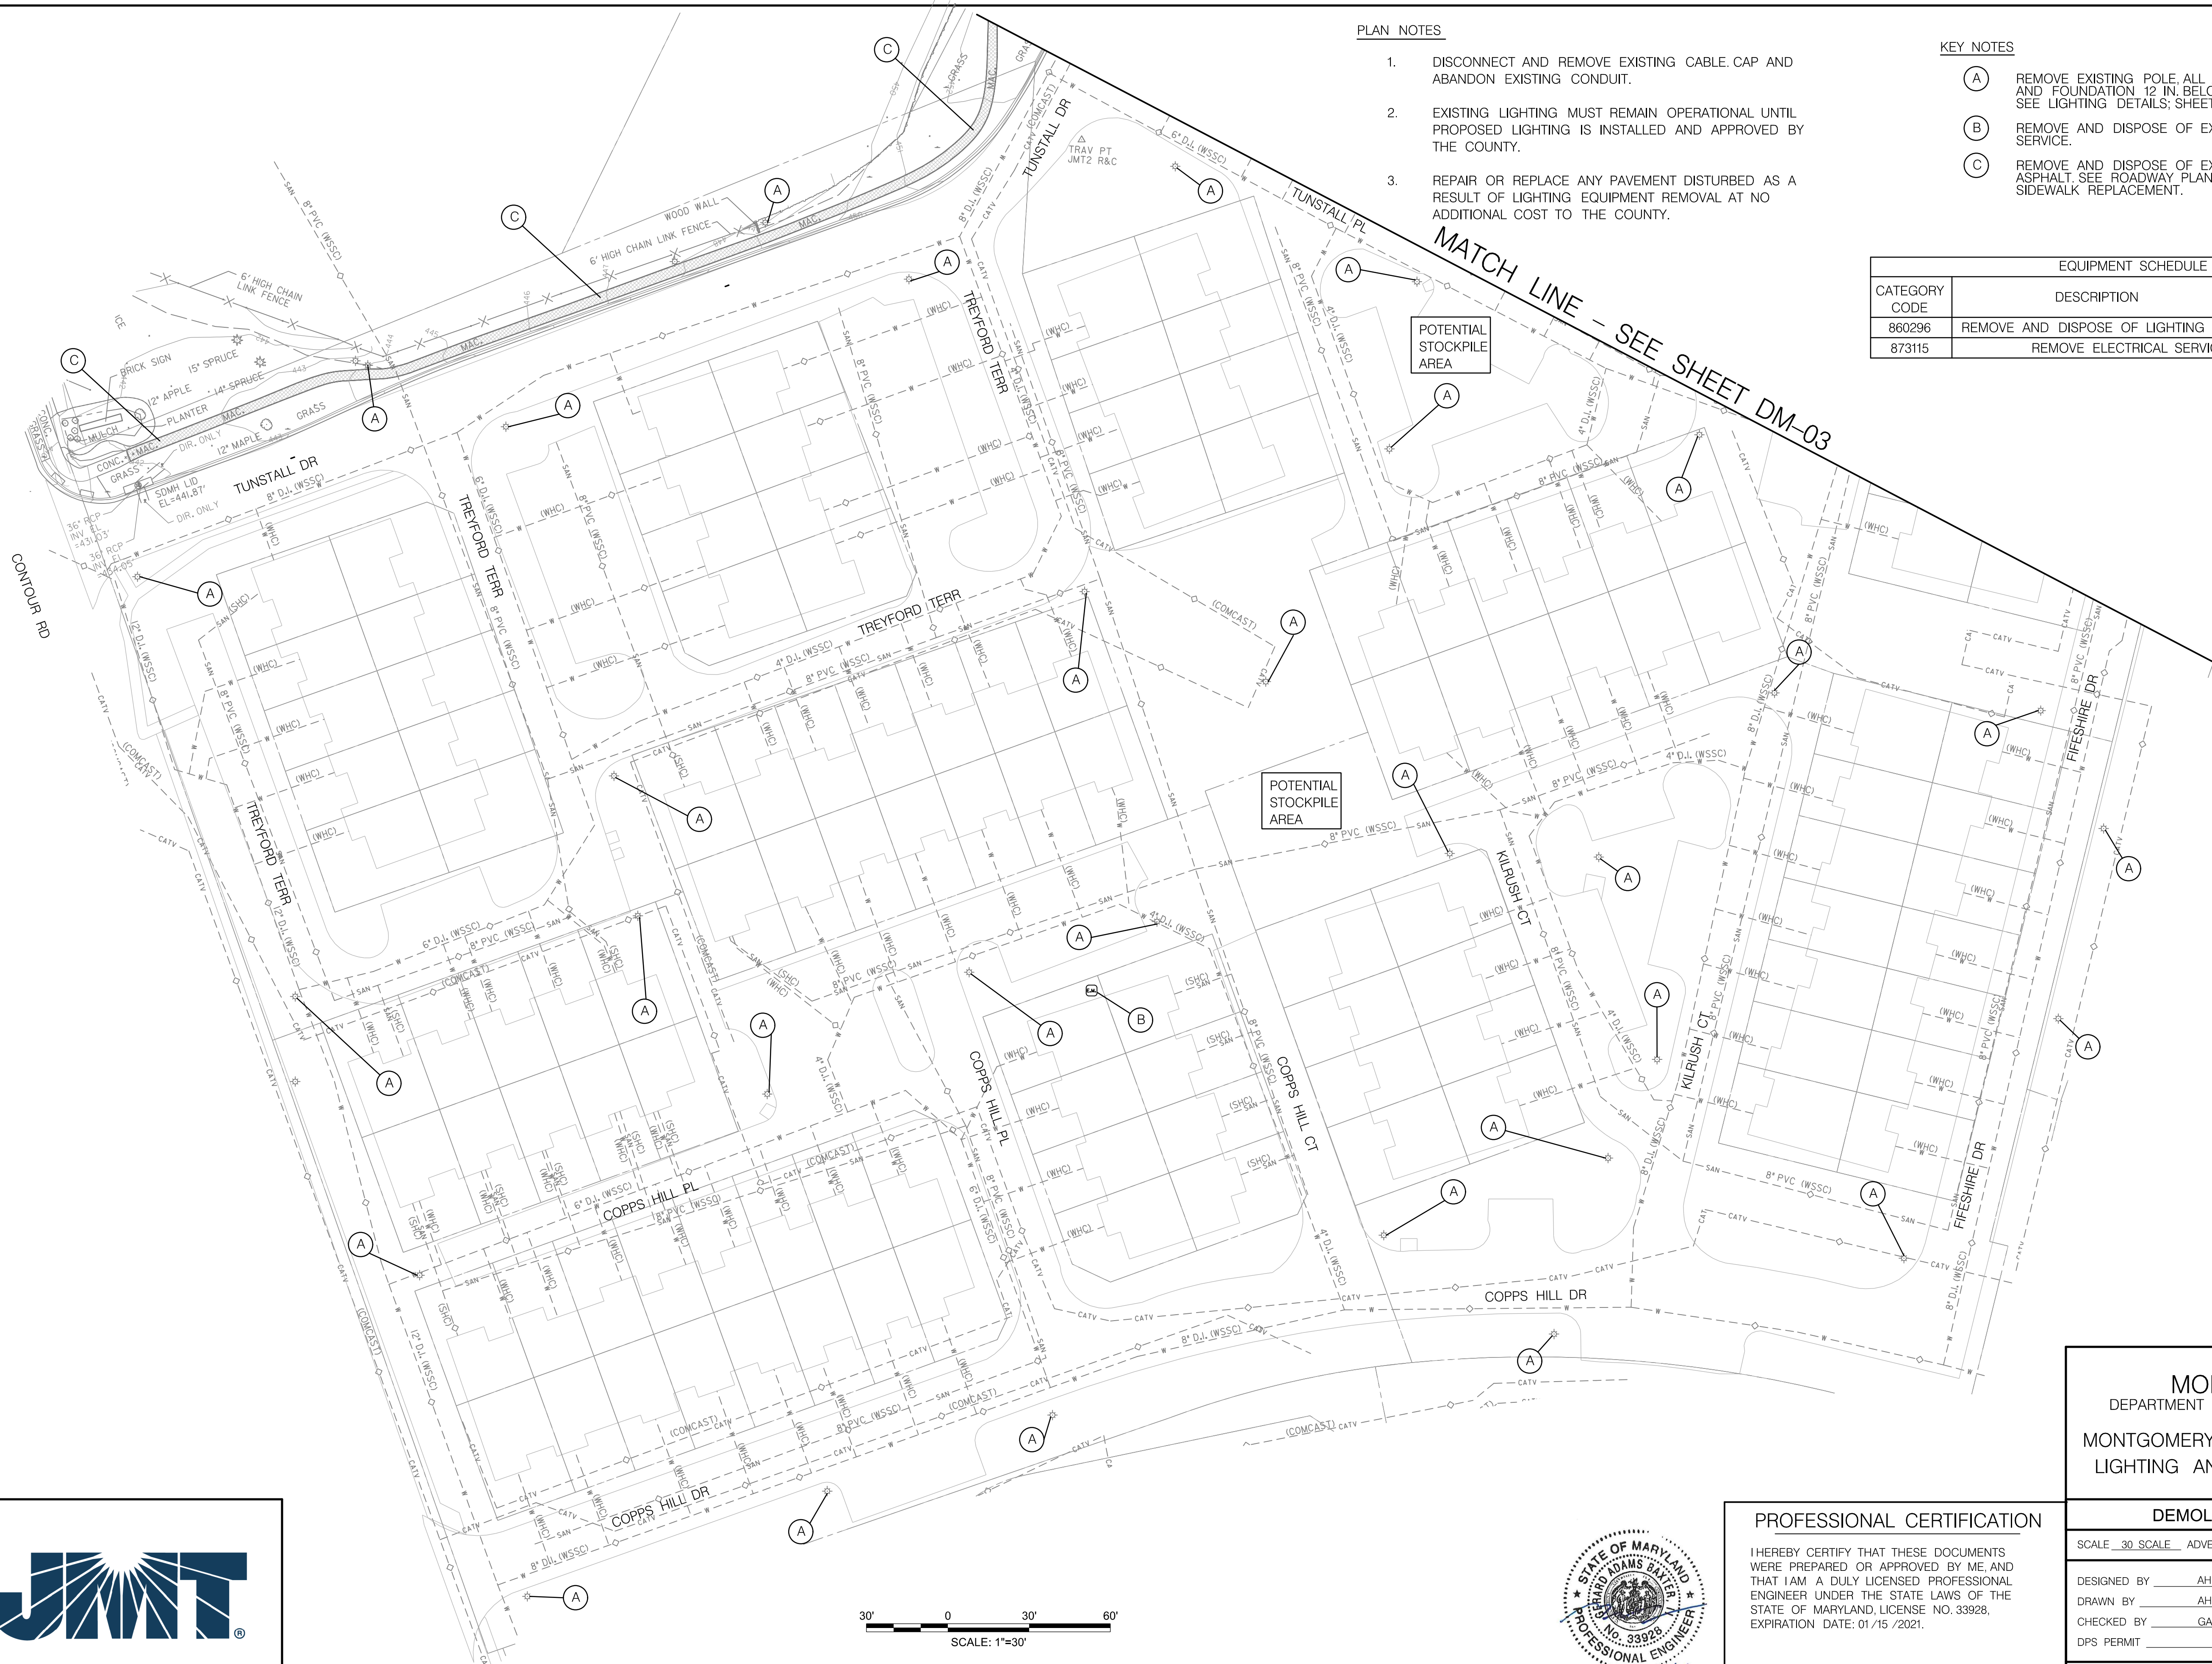

MONTGOMERY COUNTY
DEPARTMENT OF HOUSING AND COMMUNITY AFFAIRS
MONTGOMERY VILLAGE /SOUTH VILLAGE HOMES
LIGHTING AND SITE IMPROVEMENTS PROJECT

DEMOLITION PLAN - GROVER'S FORGE

SCALE	30	SCALE	ADVERTISED DATE	N/A	CONTRACT NO.	
DESIGNED BY	AHB	COUNTY	MONTGOMERY COUNTY			
DRAWN BY	AHB	LOGMILE				
CHECKED BY	GAB					
DPS PERMIT						
DRAWING NO.	DM-04	OF	09	SHEET NO.	16 OF 46	

PROFESSIONAL CERTIFICATION

I HEREBY CERTIFY THAT THESE DOCUMENTS WERE PREPARED OR APPROVED BY ME, AND THAT I AM A DULY LICENSED PROFESSIONAL ENGINEER UNDER THE STATE LAWS OF THE STATE OF MARYLAND, LICENSE NO. 33928, EXPIRATION DATE: 01/15/2021.

GERARD ADAMS BAXTER, II, PE



BY: abortkewicz




KEY NOTES

- (A) REMOVE EXISTING POLE, ALL ASSOCIATED EQUIPMENT, AND FOUNDATION 12 IN. BELOW GRADE AND BACKFILL. SEE LIGHTING DETAILS; SHEET DE-01 AND DE-02.

PLAN NOTES

- DISCONNECT AND REMOVE EXISTING CABLE, CAP AND ABANDON EXISTING CONDUIT.
- EXISTING LIGHTING MUST REMAIN OPERATIONAL UNTIL PROPOSED LIGHTING IS INSTALLED AND APPROVED BY THE COUNTY.
- REPAIR OR REPLACE ANY PAVEMENT DISTURBED AS A RESULT OF LIGHTING EQUIPMENT REMOVAL AT NO ADDITIONAL COST TO THE COUNTY.

EQUIPMENT SCHEDULE			
CATEGORY CODE	DESCRIPTION	UNIT	QUANTITY
860296	REMOVE AND DISPOSE OF LIGHTING STRUCTURE	EA	12

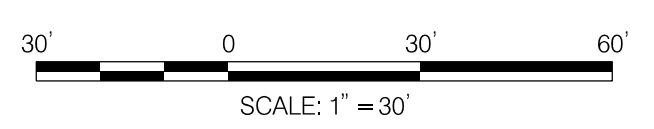

BY: abortkiewicz -

PLOTTED: Thursday, August 29, 2019 AT 11:39 AM
FILE: G:\2019\130707_003_Montgomery_Village_ICADD\pDM-Baseline.dgn



PROFESSIONAL CERTIFICATION


I HEREBY CERTIFY THAT THESE DOCUMENTS WERE PREPARED OR APPROVED BY ME, AND THAT I AM A DULY LICENSED PROFESSIONAL ENGINEER UNDER THE STATE LAWS OF THE STATE OF MARYLAND, LICENSE NO. 33928, EXPIRATION DATE: 01/15/2021.

GERARD ADAMS BAXTER, II, PE


MONTGOMERY COUNTY
DEPARTMENT OF HOUSING AND COMMUNITY AFFAIRS
MONTGOMERY VILLAGE /SOUTH VILLAGE HOMES
LIGHTING AND SITE IMPROVEMENTS PROJECT

DEMOLITION PLAN - THE HAMPTONS

SCALE: 30 SCALE	ADVERTISED DATE: N/A	CONTRACT NO.:
DESIGNED BY: AHB	COUNTY: MONTGOMERY COUNTY	
DRAWN BY: AHB	LOGMILE:	
CHECKED BY: GAB		
DPS PERMIT:		
DRAWING NO. DM-05	OF 09	SHEET NO. 17 OF 46

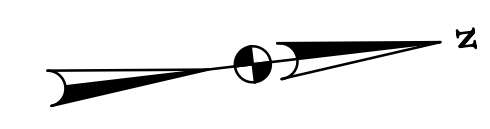

MATCH LINE - SEE SHEET DM-05

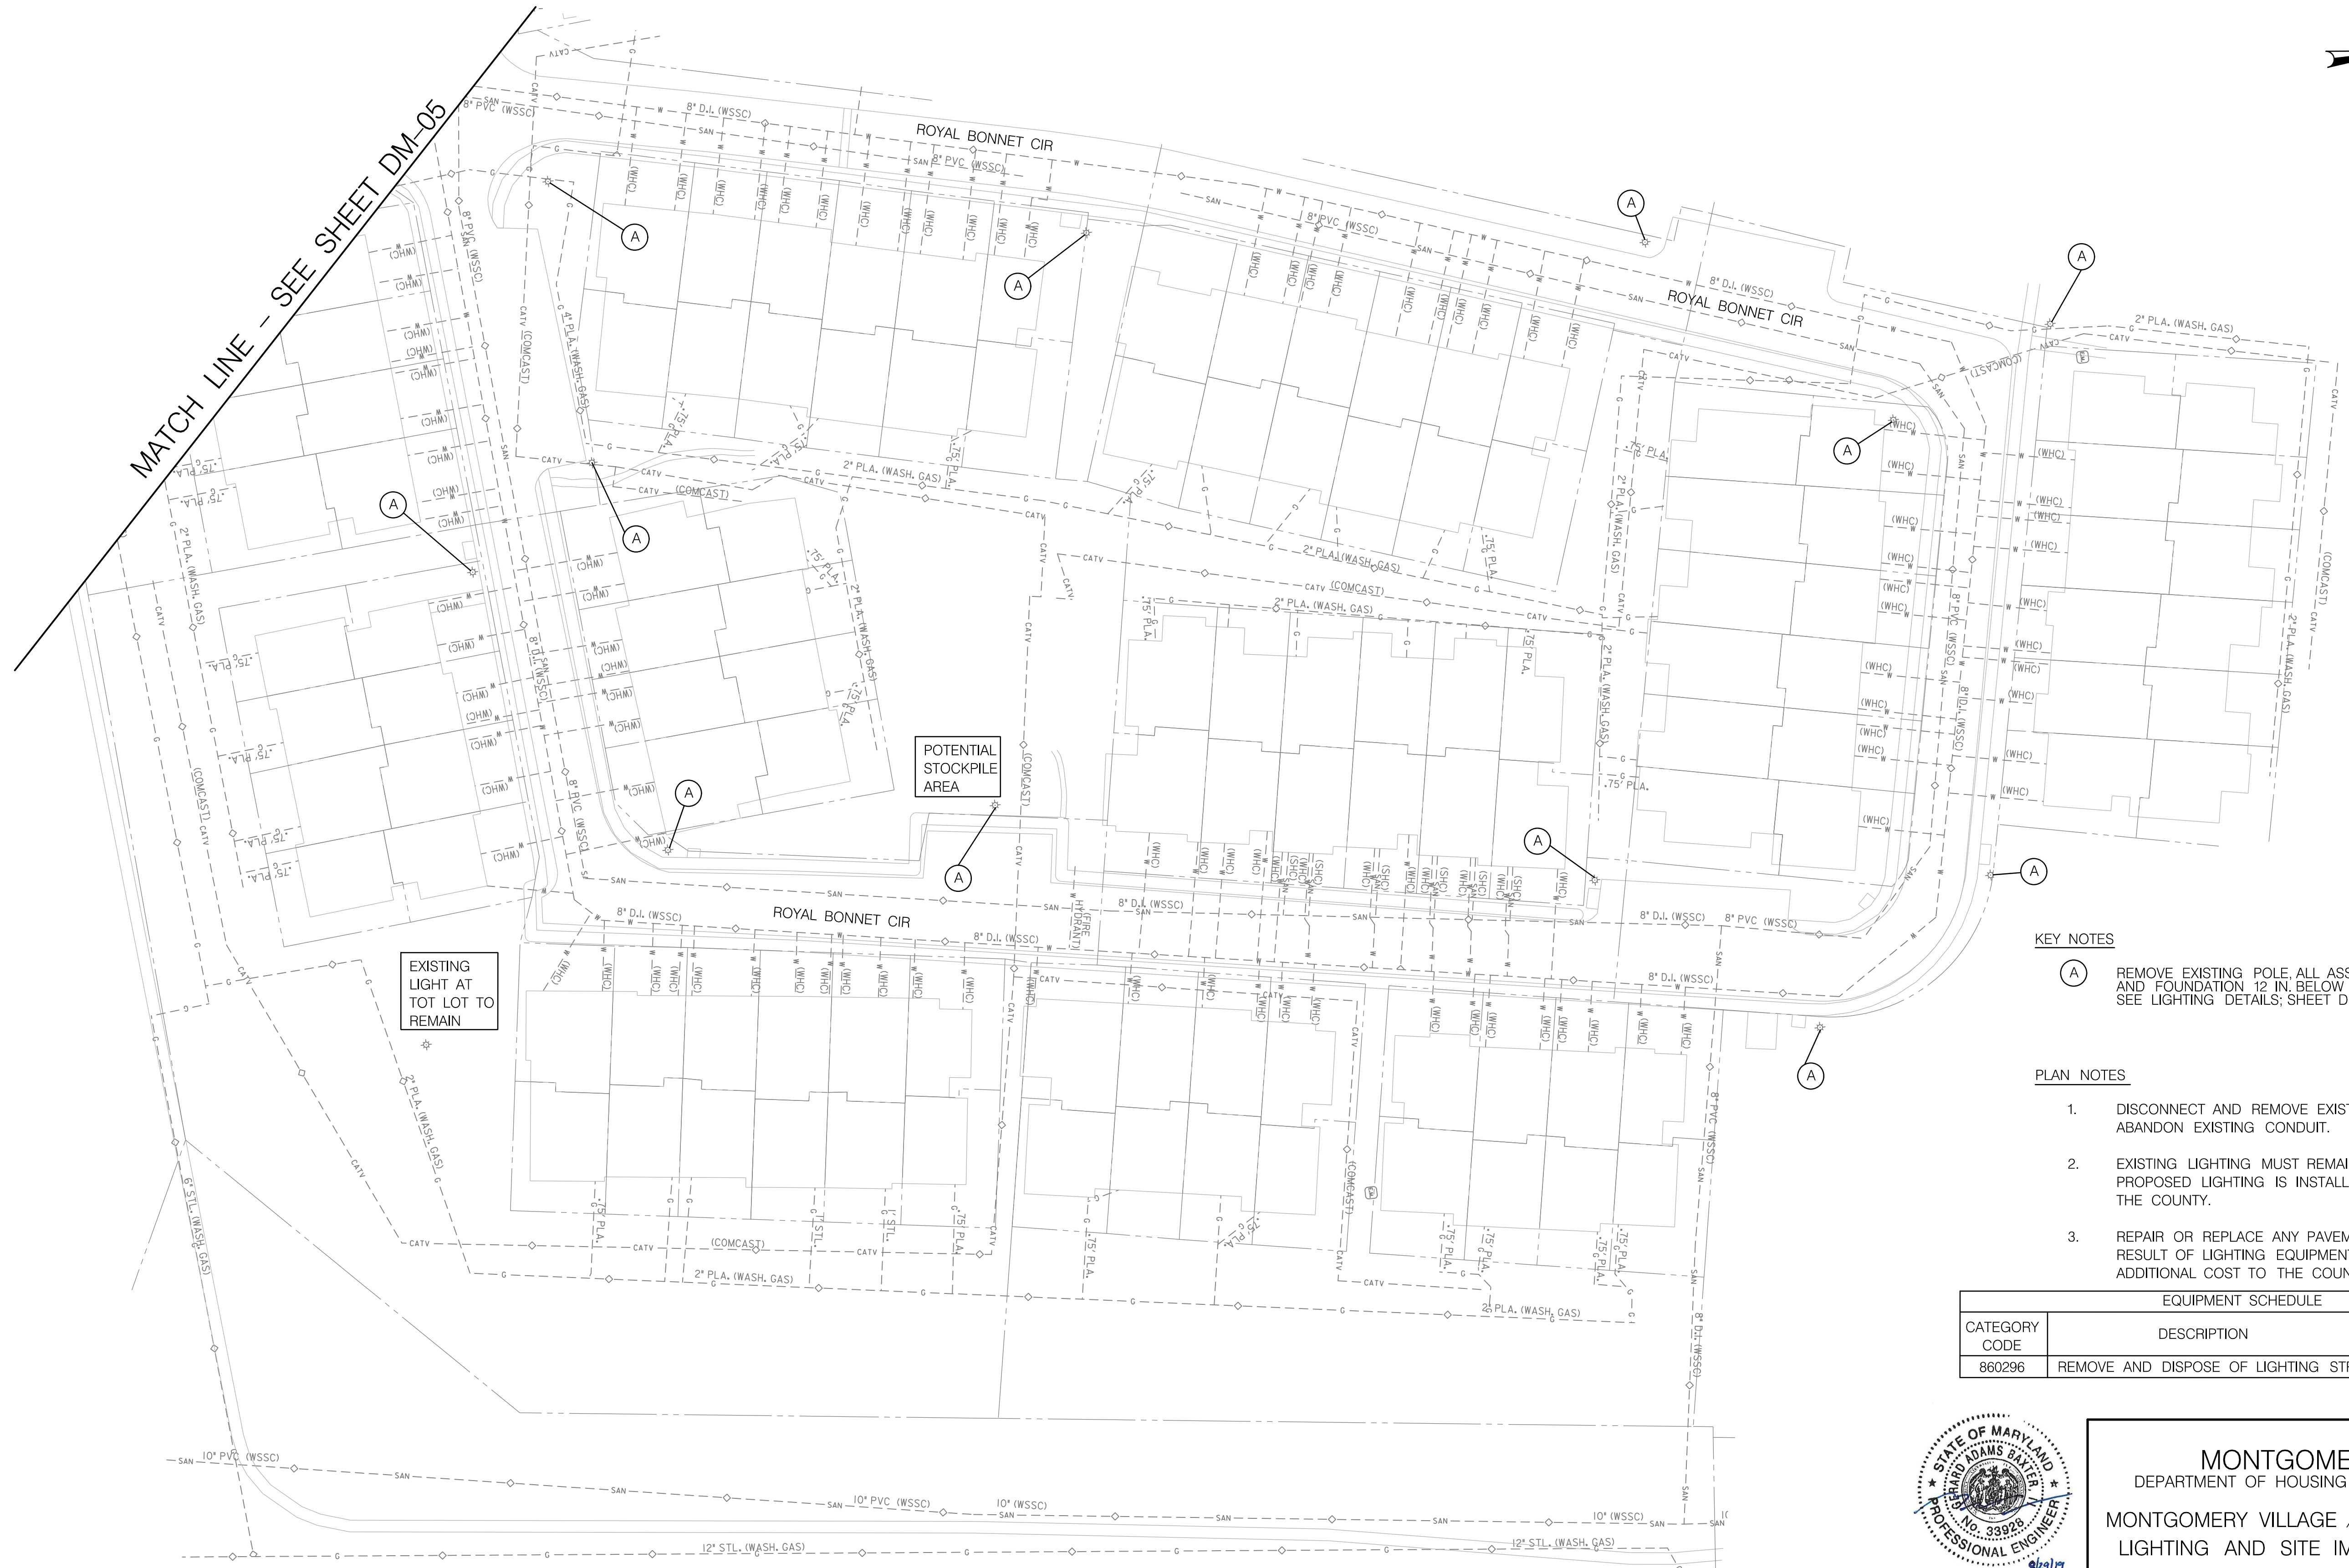

EXISTING LIGHT AT TOT LOT TO REMAIN

POTENTIAL STOCKPILE AREA

KEY NOTES

- (A) REMOVE EXISTING POLE, ALL ASSOCIATED EQUIPMENT, AND FOUNDATION 12 IN. BELOW GRADE AND BACKFILL. SEE LIGHTING DETAILS, SHEET DE-01 AND DE-02.

PLAN NOTES

- DISCONNECT AND REMOVE EXISTING CABLE, CAP AND ABANDON EXISTING CONDUIT.
- EXISTING LIGHTING MUST REMAIN OPERATIONAL UNTIL PROPOSED LIGHTING IS INSTALLED AND APPROVED BY THE COUNTY.
- REPAIR OR REPLACE ANY PAVEMENT DISTURBED AS A RESULT OF LIGHTING EQUIPMENT REMOVAL AT NO ADDITIONAL COST TO THE COUNTY.

EQUIPMENT SCHEDULE

CATEGORY CODE	DESCRIPTION	UNIT	QUANTITY
860296	REMOVE AND DISPOSE OF LIGHTING STRUCTURE	EA	12



MONTGOMERY COUNTY
DEPARTMENT OF HOUSING AND COMMUNITY AFFAIRS
MONTGOMERY VILLAGE /SOUTH VILLAGE HOMES
LIGHTING AND SITE IMPROVEMENTS PROJECT


PROFESSIONAL CERTIFICATION

I HEREBY CERTIFY THAT THESE DOCUMENTS WERE PREPARED OR APPROVED BY ME, AND THAT I AM A DULY LICENSED PROFESSIONAL ENGINEER UNDER THE STATE LAWS OF THE STATE OF MARYLAND, LICENSE NO. 33928, EXPIRATION DATE: 01/15/2021.



GERARD ADAMS BAXTER, II, PE

DEMOLITION PLAN - THE HAMPTONS

SCALE	30	SCALE	ADVERTISED DATE	N/A	CONTRACT NO.	
DESIGNED BY	AHB	COUNTY	MONTGOMERY COUNTY			
DRAWN BY	AHB	LOGMILE				
CHECKED BY	GAB					
DPS PERMIT						
DRAWING NO.	DM-06	OF	09	SHEET NO.	18 OF 46	

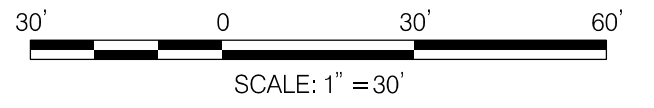

BY: abortkewicz -

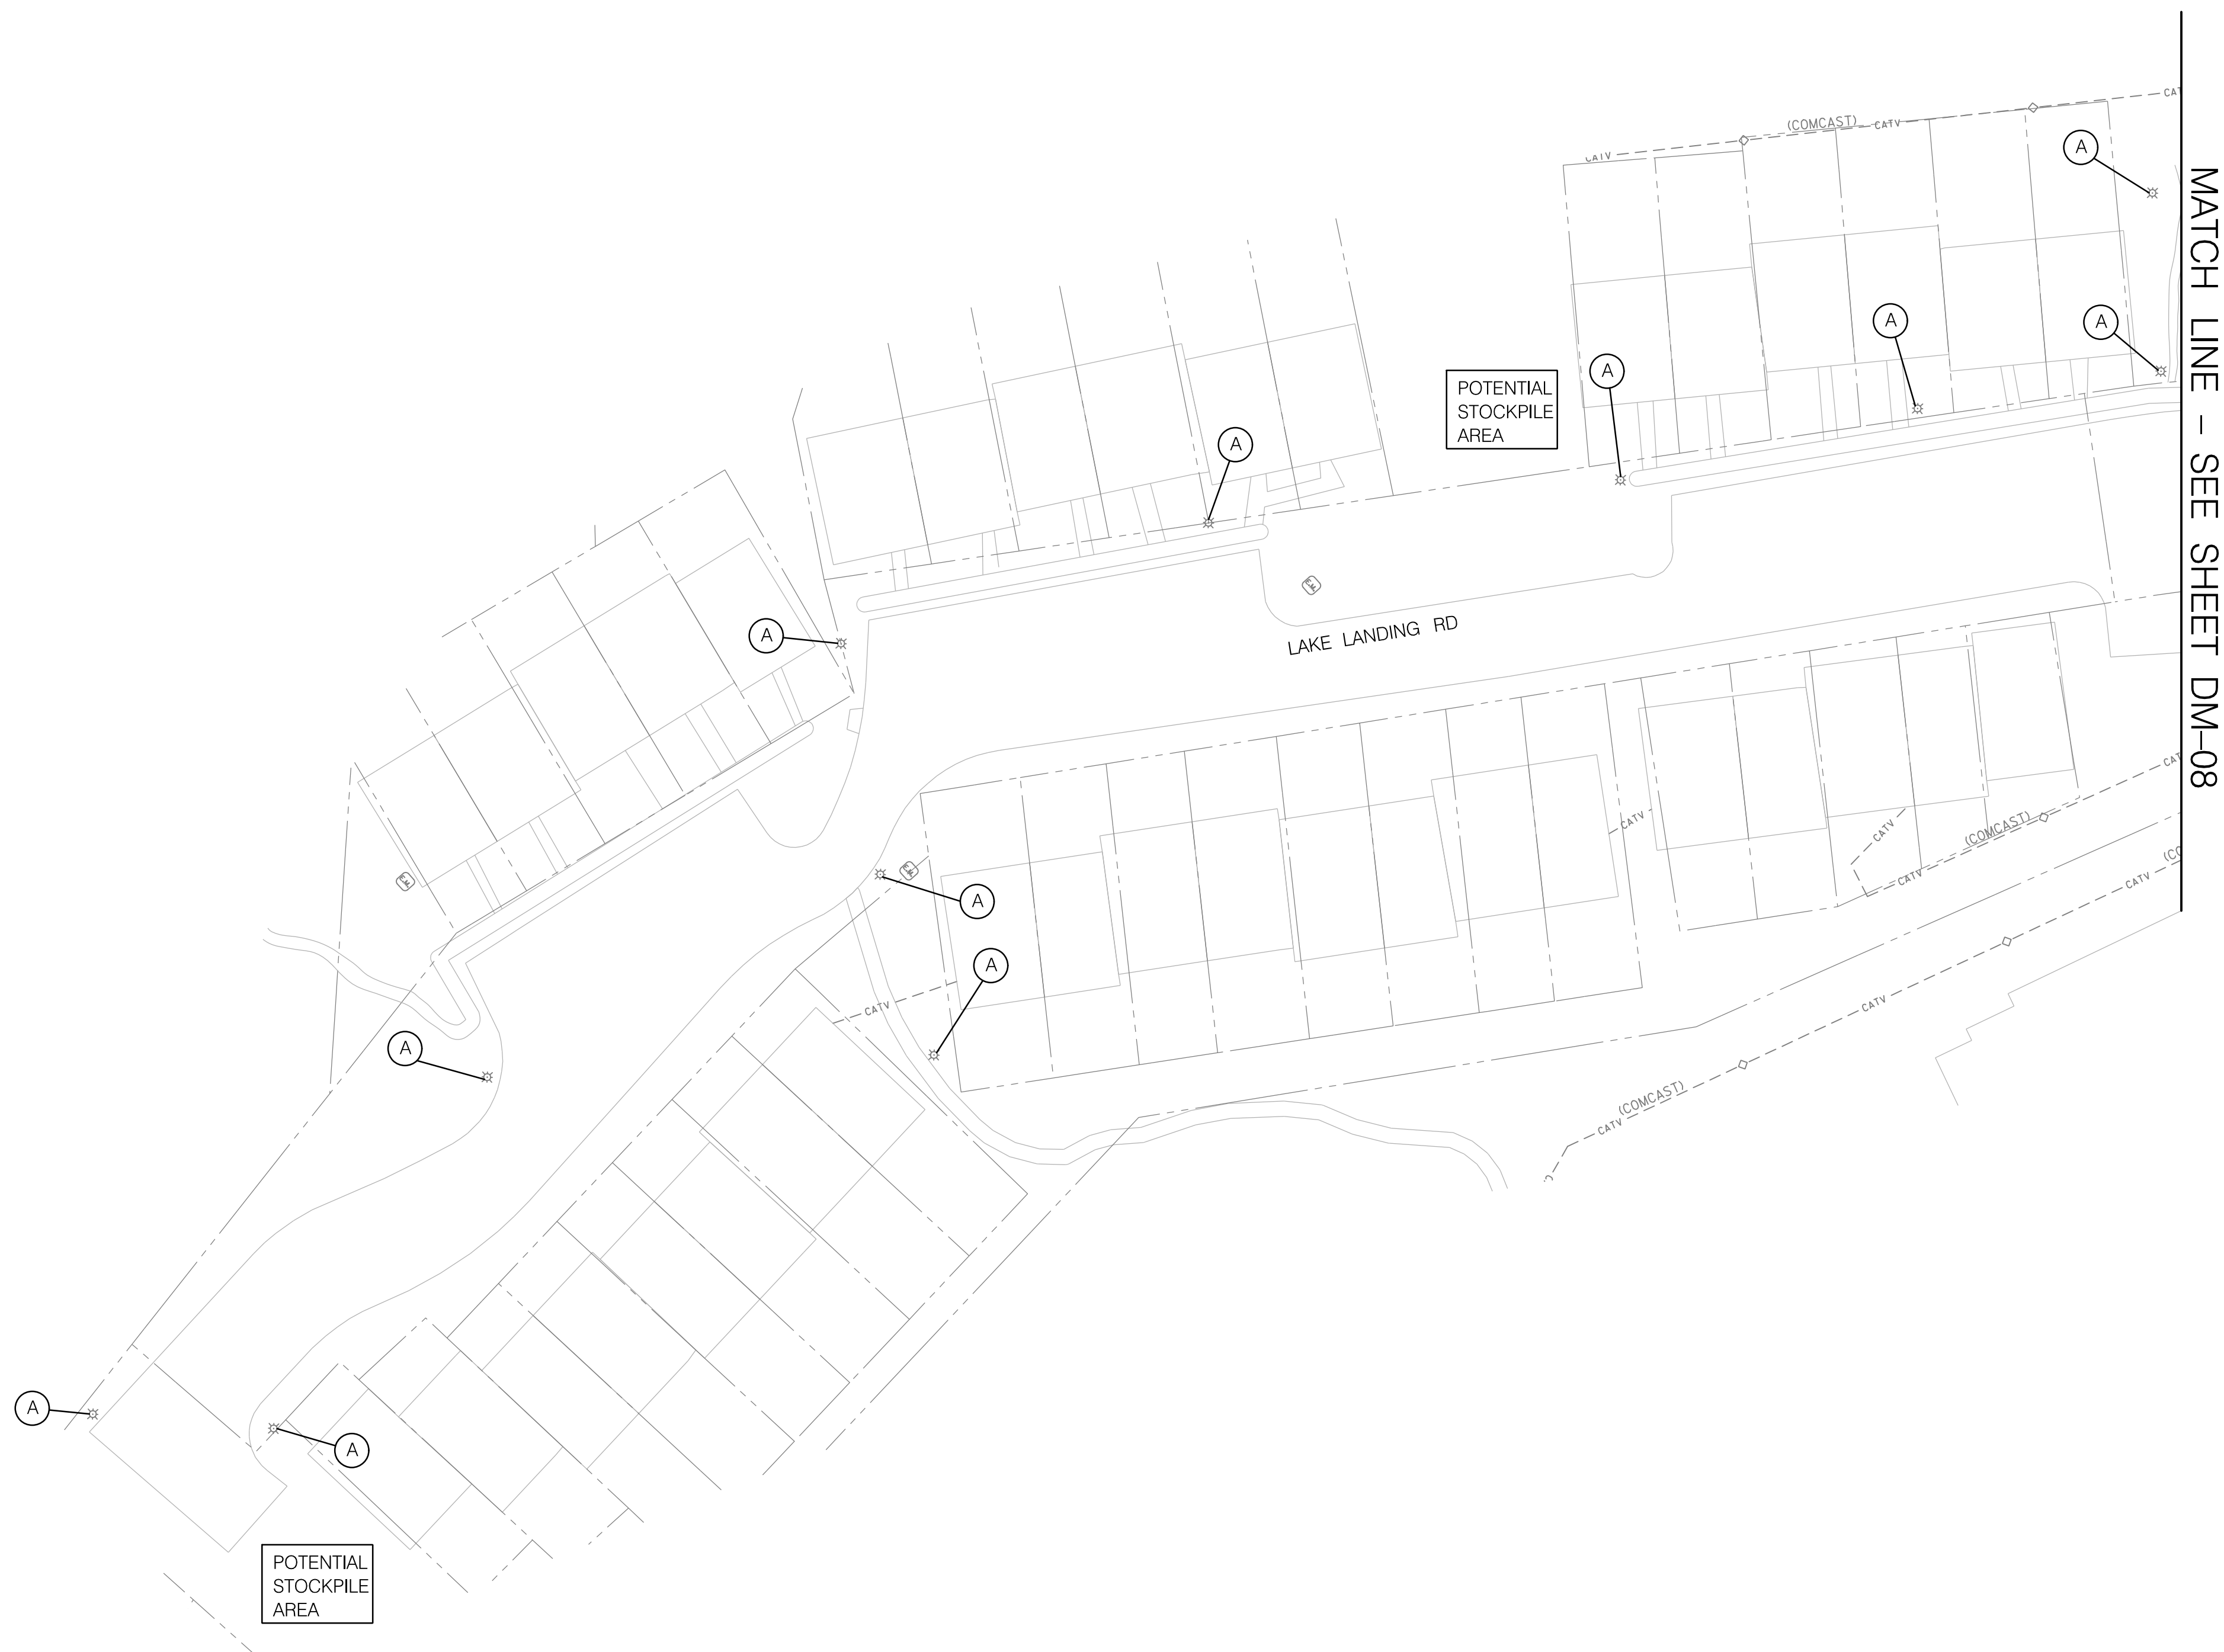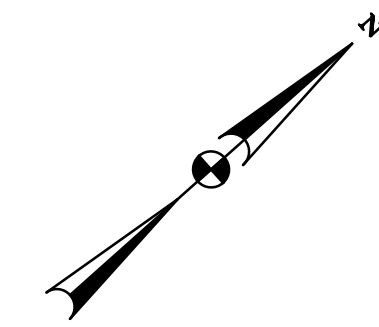




KEY NOTES

- (A) REMOVE EXISTING POLE, ALL ASSOCIATED EQUIPMENT, AND FOUNDATION 12 IN. BELOW GRADE AND BACKFILL. SEE LIGHTING DETAILS; SHEET DE-01 AND DE-02.


PLAN NOTES

1. DISCONNECT AND REMOVE EXISTING CABLE, CAP AND ABANDON EXISTING CONDUIT.
2. EXISTING LIGHTING MUST REMAIN OPERATIONAL UNTIL PROPOSED LIGHTING IS INSTALLED AND APPROVED BY THE COUNTY.
3. REPAIR OR REPLACE ANY PAVEMENT DISTURBED AS A RESULT OF LIGHTING EQUIPMENT REMOVAL AT NO ADDITIONAL COST TO THE COUNTY.

EQUIPMENT SCHEDULE			
CATEGORY CODE	DESCRIPTION	UNIT	QUANTITY
860296	REMOVE AND DISPOSE OF LIGHTING STRUCTURE	EA	11

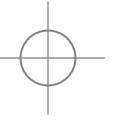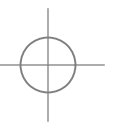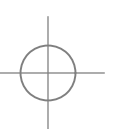

BY: abortkewicz

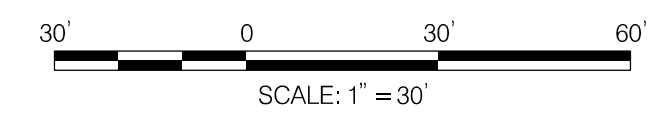

PROFESSIONAL CERTIFICATION


I HEREBY CERTIFY THAT THESE DOCUMENTS WERE PREPARED OR APPROVED BY ME, AND THAT I AM A DULY LICENSED PROFESSIONAL ENGINEER UNDER THE STATE LAWS OF THE STATE OF MARYLAND, LICENSE NO. 33928, EXPIRATION DATE: 01/15 /2021.

GERARD ADAMS BAXTER, II, PE

MONTGOMERY COUNTY
 DEPARTMENT OF HOUSING AND COMMUNITY AFFAIRS
 MONTGOMERY VILLAGE /SOUTH VILLAGE HOMES
 LIGHTING AND SITE IMPROVEMENTS PROJECT

DEMOLITION PLAN - WALKER'S CHOICE

SCALE: 30 SCALE	ADVERTISED DATE: N/A	CONTRACT NO.:
DESIGNED BY: AHB	COUNTY: MONTGOMERY COUNTY	
DRAWN BY: AHB	LOGMILE:	
CHECKED BY: GAB		
DPS PERMIT:		
DRAWING NO. DM-07	OF 09	SHEET NO. 19 OF 46

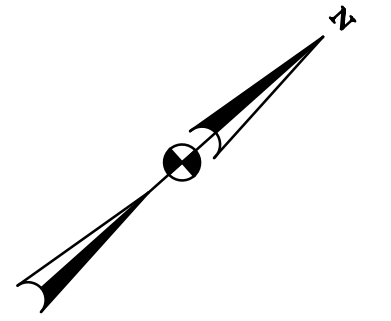

MATCH LINE - SEE SHEET DM-07




KEY NOTES

- (A) REMOVE EXISTING POLE, ALL ASSOCIATED EQUIPMENT, AND FOUNDATION 12 IN. BELOW GRADE AND BACKFILL. SEE LIGHTING DETAILS; SHEET DE-01 AND DE-02.

PLAN NOTES

1. DISCONNECT AND REMOVE EXISTING CABLE, CAP AND ABANDON EXISTING CONDUIT.
2. EXISTING LIGHTING MUST REMAIN OPERATIONAL UNTIL PROPOSED LIGHTING IS INSTALLED AND APPROVED BY THE COUNTY.
3. REPAIR OR REPLACE ANY PAVEMENT DISTURBED AS A RESULT OF LIGHTING EQUIPMENT REMOVAL AT NO ADDITIONAL COST TO THE COUNTY.

EQUIPMENT SCHEDULE			
CATEGORY CODE	DESCRIPTION	UNIT	QUANTITY
860296	REMOVE AND DISPOSE OF LIGHTING STRUCTURE	EA	13

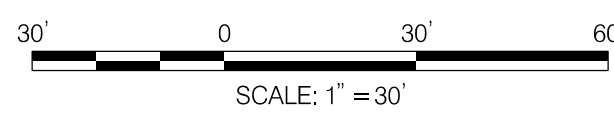

MATCH LINE - SEE SHEET DM-09



PROFESSIONAL CERTIFICATION

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GERARD ADAMS BAXTER, II, PE

MONTGOMERY COUNTY
DEPARTMENT OF HOUSING AND COMMUNITY AFFAIRS
MONTGOMERY VILLAGE /SOUTH VILLAGE HOMES
LIGHTING AND SITE IMPROVEMENTS PROJECT

DEMOLITION PLAN - WALKER'S CHOICE

SCALE: 30 SCALE	ADVERTISED DATE: N/A	CONTRACT NO.:
DESIGNED BY: AHB	COUNTY: MONTGOMERY COUNTY	
DRAWN BY: AHB	LOGMILE:	
CHECKED BY: GAB		
DPS PERMIT:		
DRAWING NO. DM-08	OF 09	SHEET NO. 20 OF 46



BY: abortkewicz



KEY NOTES

- (A) REMOVE EXISTING POLE, ALL ASSOCIATED EQUIPMENT, AND FOUNDATION 12 IN. BELOW GRADE AND BACKFILL. SEE LIGHTING DETAILS; SHEET DE-01 AND DE-02.

PLAN NOTES

1. DISCONNECT AND REMOVE EXISTING CABLE, CAP AND ABANDON EXISTING CONDUIT.
2. EXISTING LIGHTING MUST REMAIN OPERATIONAL UNTIL PROPOSED LIGHTING IS INSTALLED AND APPROVED BY THE COUNTY.
3. REPAIR OR REPLACE ANY PAVEMENT DISTURBED AS A RESULT OF LIGHTING EQUIPMENT REMOVAL AT NO ADDITIONAL COST TO THE COUNTY.

EQUIPMENT SCHEDULE			
CATEGORY CODE	DESCRIPTION	UNIT	QUANTITY
860296	REMOVE AND DISPOSE OF LIGHTING STRUCTURE	EA	10

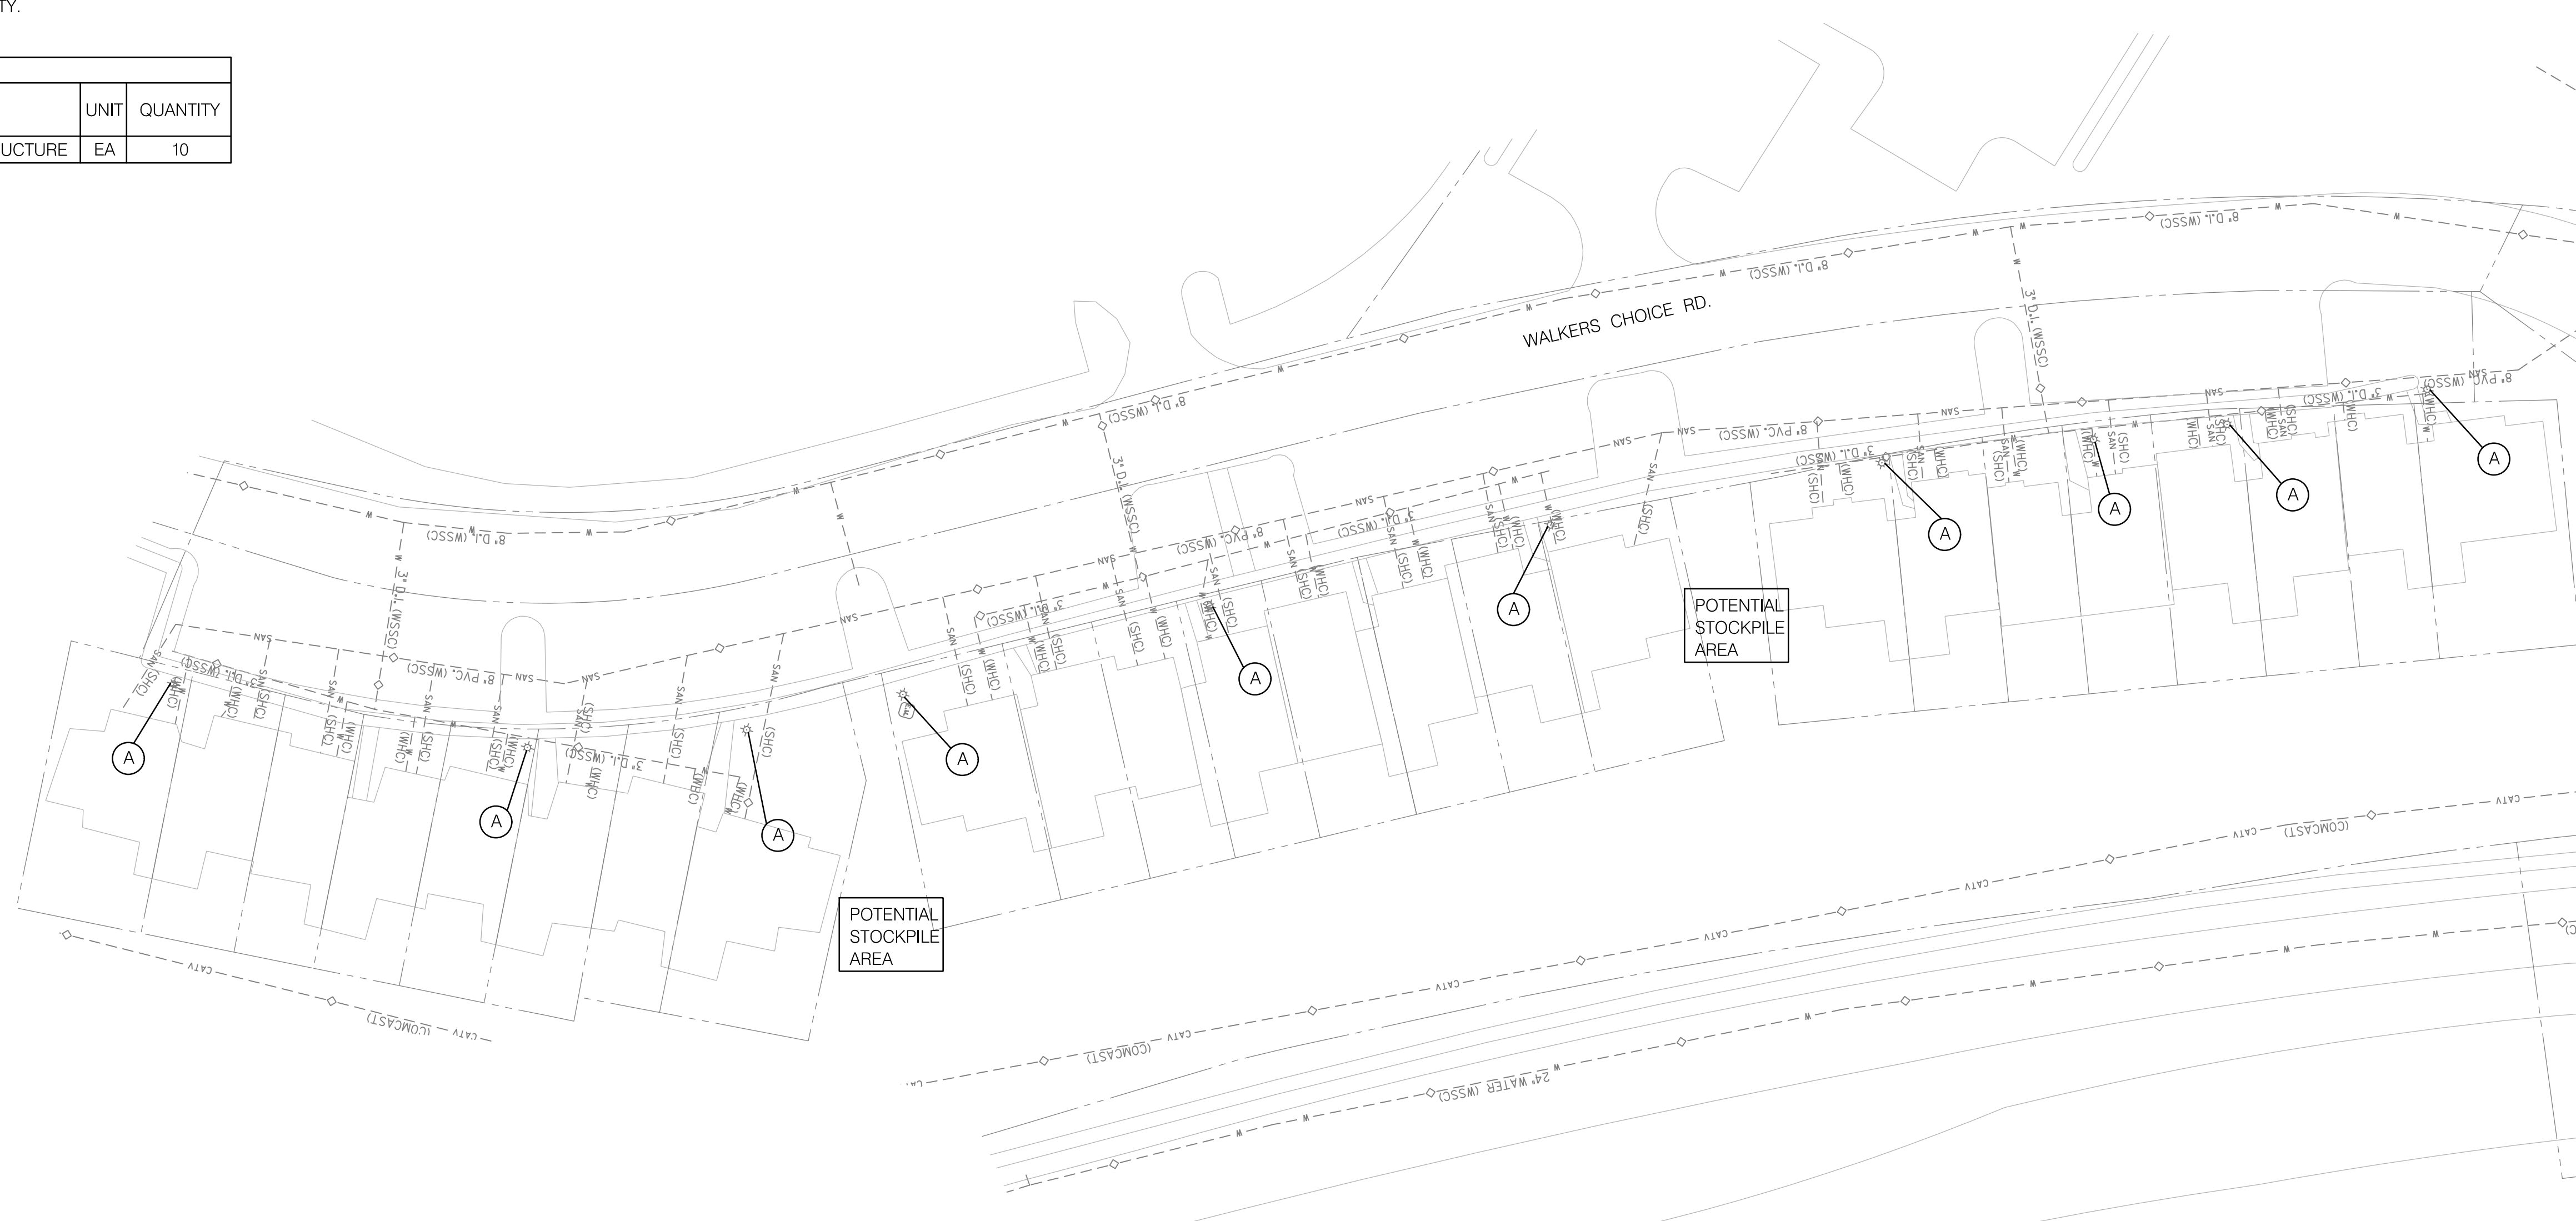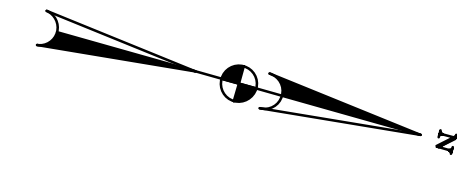


MATCH LINE - SEE SHEET DM-08



MONTGOMERY COUNTY
 DEPARTMENT OF HOUSING AND COMMUNITY AFFAIRS
 MONTGOMERY VILLAGE /SOUTH VILLAGE HOMES
 LIGHTING AND SITE IMPROVEMENTS PROJECT

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 GERARD ADAMS BAXTER, II, PE

DEMOLITION PLAN - WALKER'S CHOICE
 SCALE: 30 SCALE ADVERTISED DATE: N/A CONTRACT NO. _____
 DESIGNED BY: AHB COUNTY: MONTGOMERY COUNTY
 DRAWN BY: AHB LOGMILE: _____
 CHECKED BY: GAB
 DPS PERMIT: _____
 DRAWING NO. **DM-09** OF **09** SHEET NO. 21 OF 46

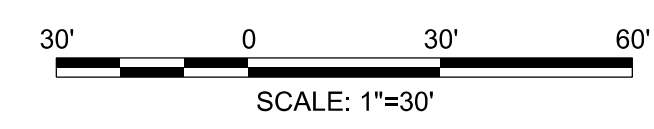

BY: abortkewicz -

- (A) 832001, DUCT CABLE - 2 CONDUCTOR, NO. 6 AWG 600V
- (B) 832016 CABLE - 1 CONDUCTOR NO. 6 AWG, TYPE USE
- (6G) 832020, BARE COPPER WIRE, NO. 6 AWG

KEY NOTES:
 [1] EXISTING ELECTRICAL SERVICE PANEL WITH PHOTOCELL FOR "A" AND "B" CIRCUITS. INSTALL NEW CIRCUIT BREAKERS.

CIRCUIT NUMBER	CONDUCTOR SIZE	EQUIPMENT SERVED	CONNECTED LOADS		NUMBER OF LOADS		REMARKS
			KW	AMPS	NO. OF POLES	TRIP SIZE	
1, 3	NO. 6 AWG	PEDESTRIAN LIGHTING: A-1 - A-12	0.468	2.16	2	20	(12) - 39 W LED LUMINAIRES
2, 4	NO. 6 AWG	PEDESTRIAN LIGHTING: B-1 - B-11	0.429	1.98	2	20	(11) - 39 W LED LUMINAIRES
5		SPARE					
6		SPARE					
7-12		EXISTING					
13		SPARE					
14, 16		EXISTING					
13		SPARE					

CONNECTOR KIT SCHEDULE				
STRUCTURE	TYPE I KIT	TYPE II KIT	TYPE III KIT	TYPE IV KIT
J-1	0	0	0	8
J-2	0	0	0	4
A-1	0	0	2	0
A-2	0	2	0	0
A-7	0	0	2	0
A-8	0	0	2	0
A-9	0	2	0	0
B-1	0	0	2	0
B-2	0	2	0	0
B-7	0	0	2	0
B-8	0	0	2	0
B-9	0	2	0	0

HOUSESIDE SHIELD TABLE	
EQUIPMENT	TYPE
A-2, A-8, B-8	GVDHSS180


EQUIPMENT SCHEDULE			
CATEGORY CODE	DESCRIPTION	UNIT	QUANTITY
801003	CONCRETE FOR LIGHT FOUNDATION	CY	13.0
832020	BARE COPPER WIRE, NO. 6 AWG	LF	2300
806025	LED ROADWAY LUMINAIRE	EA	10
800000	12 FOOT DECORATIVE POLE	EA	10
832001	DUCT CABLE - 2 CONDUCTOR, NO. 6 AWG 600V	LF	2000
832016	CABLE - CONDUCTOR, NO. 6 AWG 600V	LF	200
837001	GROUND ROD = 3/4 INCH DIAMETER 10 FOOT LENGTH	EA	10
834001	CONNECTOR KIT - TYPE I	EA	0
834002	CONNECTOR KIT - TYPE II	EA	8
834003	CONNECTOR KIT - TYPE III	EA	12
834004	CONNECTOR KIT - TYPE IV	EA	12
811001	JUNCTION BOX	EA	2
805125	2 INCH SCHEDULE 80 RIGID PVC CONDUIT	LF	100
807301	20 AMP DISCONNECT SWITCH, SINGLE PHASE	EA	2

- NOTES:
- MIX 3 CONCRETE COMPENSATION INCLUDES ALL CONCRETE, EXCAVATION, REINFORCEMENT STEEL, ANCHOR BOLTS, BACKFILL, MATERIAL, LABOR EQUIPMENT AND TOOLS TO COMPLETE THE WORK.
 - CABLE AND GROUND WIRE COMPENSATION INCLUDES ALL EXCAVATION, BACKFILL, MATERIAL, LABOR EQUIPMENT AND TOOLS TO COMPLETE THE WORK.
 - JUNCTION BOX INCLUDES ALL EXCAVATION, BACKFILL, MATERIAL, LABOR EQUIPMENT AND TOOLS TO COMPLETE THE WORK. JUNCTION BOX INSTALLATION TO BE FLUSH WITH EXISTING GRADE.
 - CABLE FROM CABINET TO JUNCTION BOX SHALL BE INSTALLED IN EXISTING CONDUIT. CONDUIT SHALL BE RE-ROUTED TO THE PROPOSED JUNCTION BOX. IF RE-ROUTING IS NOT FEASIBLE, CONTRACTOR TO PROVIDE NEW 2" SCHEDULE 80 PVC CONDUIT.
 - CABLE BENEATH ROADWAY TO BE INSTALLED IN 2" SCHEDULE 80 PVC CONDUIT.


LIGHTING NOTES:

- ALL ELECTRICAL WORK SHALL BE PERFORMED AND ALL MATERIAL PROVIDED SHALL BE IN ACCORDANCE WITH THE LATEST EDITION OF THE NATIONAL ELECTRIC CODE OF THE NATIONAL FIRE PROTECTION ASSOCIATION, TO ALL LOCAL LAWS, AND/OR TO ORDINANCES GOVERNING SUCH MATERIAL CODE. IF THERE IS A CONFLICT BETWEEN THE REQUIREMENTS SPECIFIED IN THE CONTRACT DOCUMENTS AND THE CODE, THE MORE STRINGENT REQUIREMENT WILL APPLY AS DETERMINED AND APPROVED BY THE ENGINEER. WHEN THESE REQUIREMENTS DO NOT GOVERN, AND WHERE NOT OTHERWISE SPECIFIED, ELECTRICAL MATERIALS SHALL CONFORM TO THE STANDARDIZATION RULES OF THE INSTITUTE OF ELECTRICAL ENGINEERS.
- BURIED ELECTRICAL DUCT CABLE, CABLE AND CONDUIT, AND OTHER UTILITIES EXIST THROUGHOUT THIS PROJECT. THE EXISTING UTILITIES LOCATION SHOWN ARE APPROXIMATE. THE CONTRACTOR SHALL BE RESPONSIBLE FOR THE LOCATING AND PREVENTING DAMAGE TO THEM, AND MAINTAINING THEM IN SERVICE. THE CONTRACTOR SHALL VERIFY THE EXACT LOCATIONS PRIOR TO COMMENCING WORK. THE CONTRACTOR SHALL REPAIR AND /OR REPLACE ANY UTILITIES DISRUPTED AS A RESULT OF CONSTRUCTION ACTIVITIES.
- THE CONTRACTOR SHALL VERIFY ALL DIMENSIONS AND CONDITIONS AT SITE PRIOR TO WORK.
- WORK INCLUDES FURNISHING LABOR, MATERIAL, EQUIPMENT AND SERVICE NECESSARY AND INCIDENTAL TO PROPER COMPLETION OF THE ELECTRICAL WORK. MINOR ITEMS, ACCESSORIES OR DEVICES NECESSARY FOR COMPLETION AND PROPER OPERATION SHALL BE PROVIDED WHETHER OR NOT THEY ARE SPECIFICALLY CALLED FOR BY THE SPECIFICATIONS OR DRAWINGS.
- THE CONTRACTOR SHALL VERIFY THE OPERATING VOLTAGE OF ALL CIRCUITS OF THE PROPOSED LIGHTING SYSTEM AND IDENTIFY OPEN CIRCUITS THAT ARE TO BE USED. IF NO OPEN CIRCUITS ARE AVAILABLE, CONTRACTOR TO REDIRECT WIRE TO ANOTHER OPEN CIRCUIT AS APPROVED BY THE ENGINEER.
- LIGHTS TO BE PLACED 2' BEHIND BACK OF SIDEWALK OR BACK OF CURB TO CENTER OF POLE UNLESS OTHERWISE NOTED.
- ALL CONNECTIONS BETWEEN GROUND RODS AND GROUND CABLES TO BE EXOTHERMIC WELD.
- CONDUCTORS SHALL NOT BE SPLICED EXCEPT IN STRUCTURES OR PULL JUNCTION BOXES.
- ALL TRENCHING MUST BE BACKFILLED AND STABILIZED ON THE SAME WORKING DAY ON WHICH IT WAS OPENED. ALL SOIL NOT USED FOR BACKFILL MUST BE REMOVED THE SAME WORKING DAY. IF EITHER OF THESE TASKS CANNOT BE COMPLETED ON THE SAME WORKING DAY, THE CONTRACTOR SHALL PLACE SAFETY DEVICES AROUND THE AFFECTED SITE.
- AS-BUILT LIGHTING DATA SHALL BE PROVIDED TO THE HOMEOWNERS ASSOCIATION AND MONTGOMERY COUNTY DEPARTMENT OF HOUSING AND COMMUNITY AFFAIRS (DHCA) AT THE COMPLETION OF THE BURN TEST. LIGHTING SYSTEMS WILL NOT BE ACCEPTED FOR MAINTENANCE UNTIL PLAN IS MARKED UP FOR WITH ANY CHANGES AND LIGHTING INVENTORY DATA HAS BEEN RECEIVED.
- LUMINAIRES SHALL BE WASHINGTON GLOBE HOLOPHANE AWDE2-P20-40K-AS-F-BK-3-F-B-BK OR APPROVED EQUAL AT 4000K COLOR TEMPERATURE.
- CONNECTOR KITS SHALL BE INSTALLED PER MD STD NO. 810.05 - ROADWAY LIGHTING 120240 VOLT SYSTEM 240 VOLT POLE CONNECTIONS; SHEET DE-01.
- JUNCTION BOX TO BE EITHER QUAZITE PG 24x24, TIER 15, STANDARD OPEN BOTTOM, COVER SHOULD STATE "LIGHTING", AND COLOR TO BE CEMENT GREY, OR APPROVED EQUAL AS APPROVED BY THE ENGINEER.
- ALL JUNCTION BOXES TO BE INSTALLED IN THE GRASS.
- CONTRACTOR SHALL TRIM TREES IN THE VICINITY OF THE PROPOSED LIGHTS.
- DUCT CABLE SHALL BE PLACED A MINIMUM OF 2' DEEP.
- ALL SIGNS ON EXISTING POLES THAT ARE REMOVED TO BE RELOCATED ON NEW POLES.
- CONTRACTOR TO CONTACT ELECTRICAL UTILITY PRIOR TO DISCONNECTING LIGHTS.
- CONTRACTOR TO RESET ANY SIGNS BLOCKED BY NEW LIGHTS.
- CONTRACTOR SHALL RESTORE ANY HOMEOWNER LANDSCAPING, MULCHING, ETC. IMPACTED AT NOT ADDITIONAL COST.

- LEGEND:
- PROPOSED LIGHT POLE AND LUMINAIRE
 - INDICATOR FOR DIRECTION OF LIGHT
 - GROUNDING ROD
 - CABLE RUN
 - EX. ELECTRIC METER
 - JUNCTION BOX

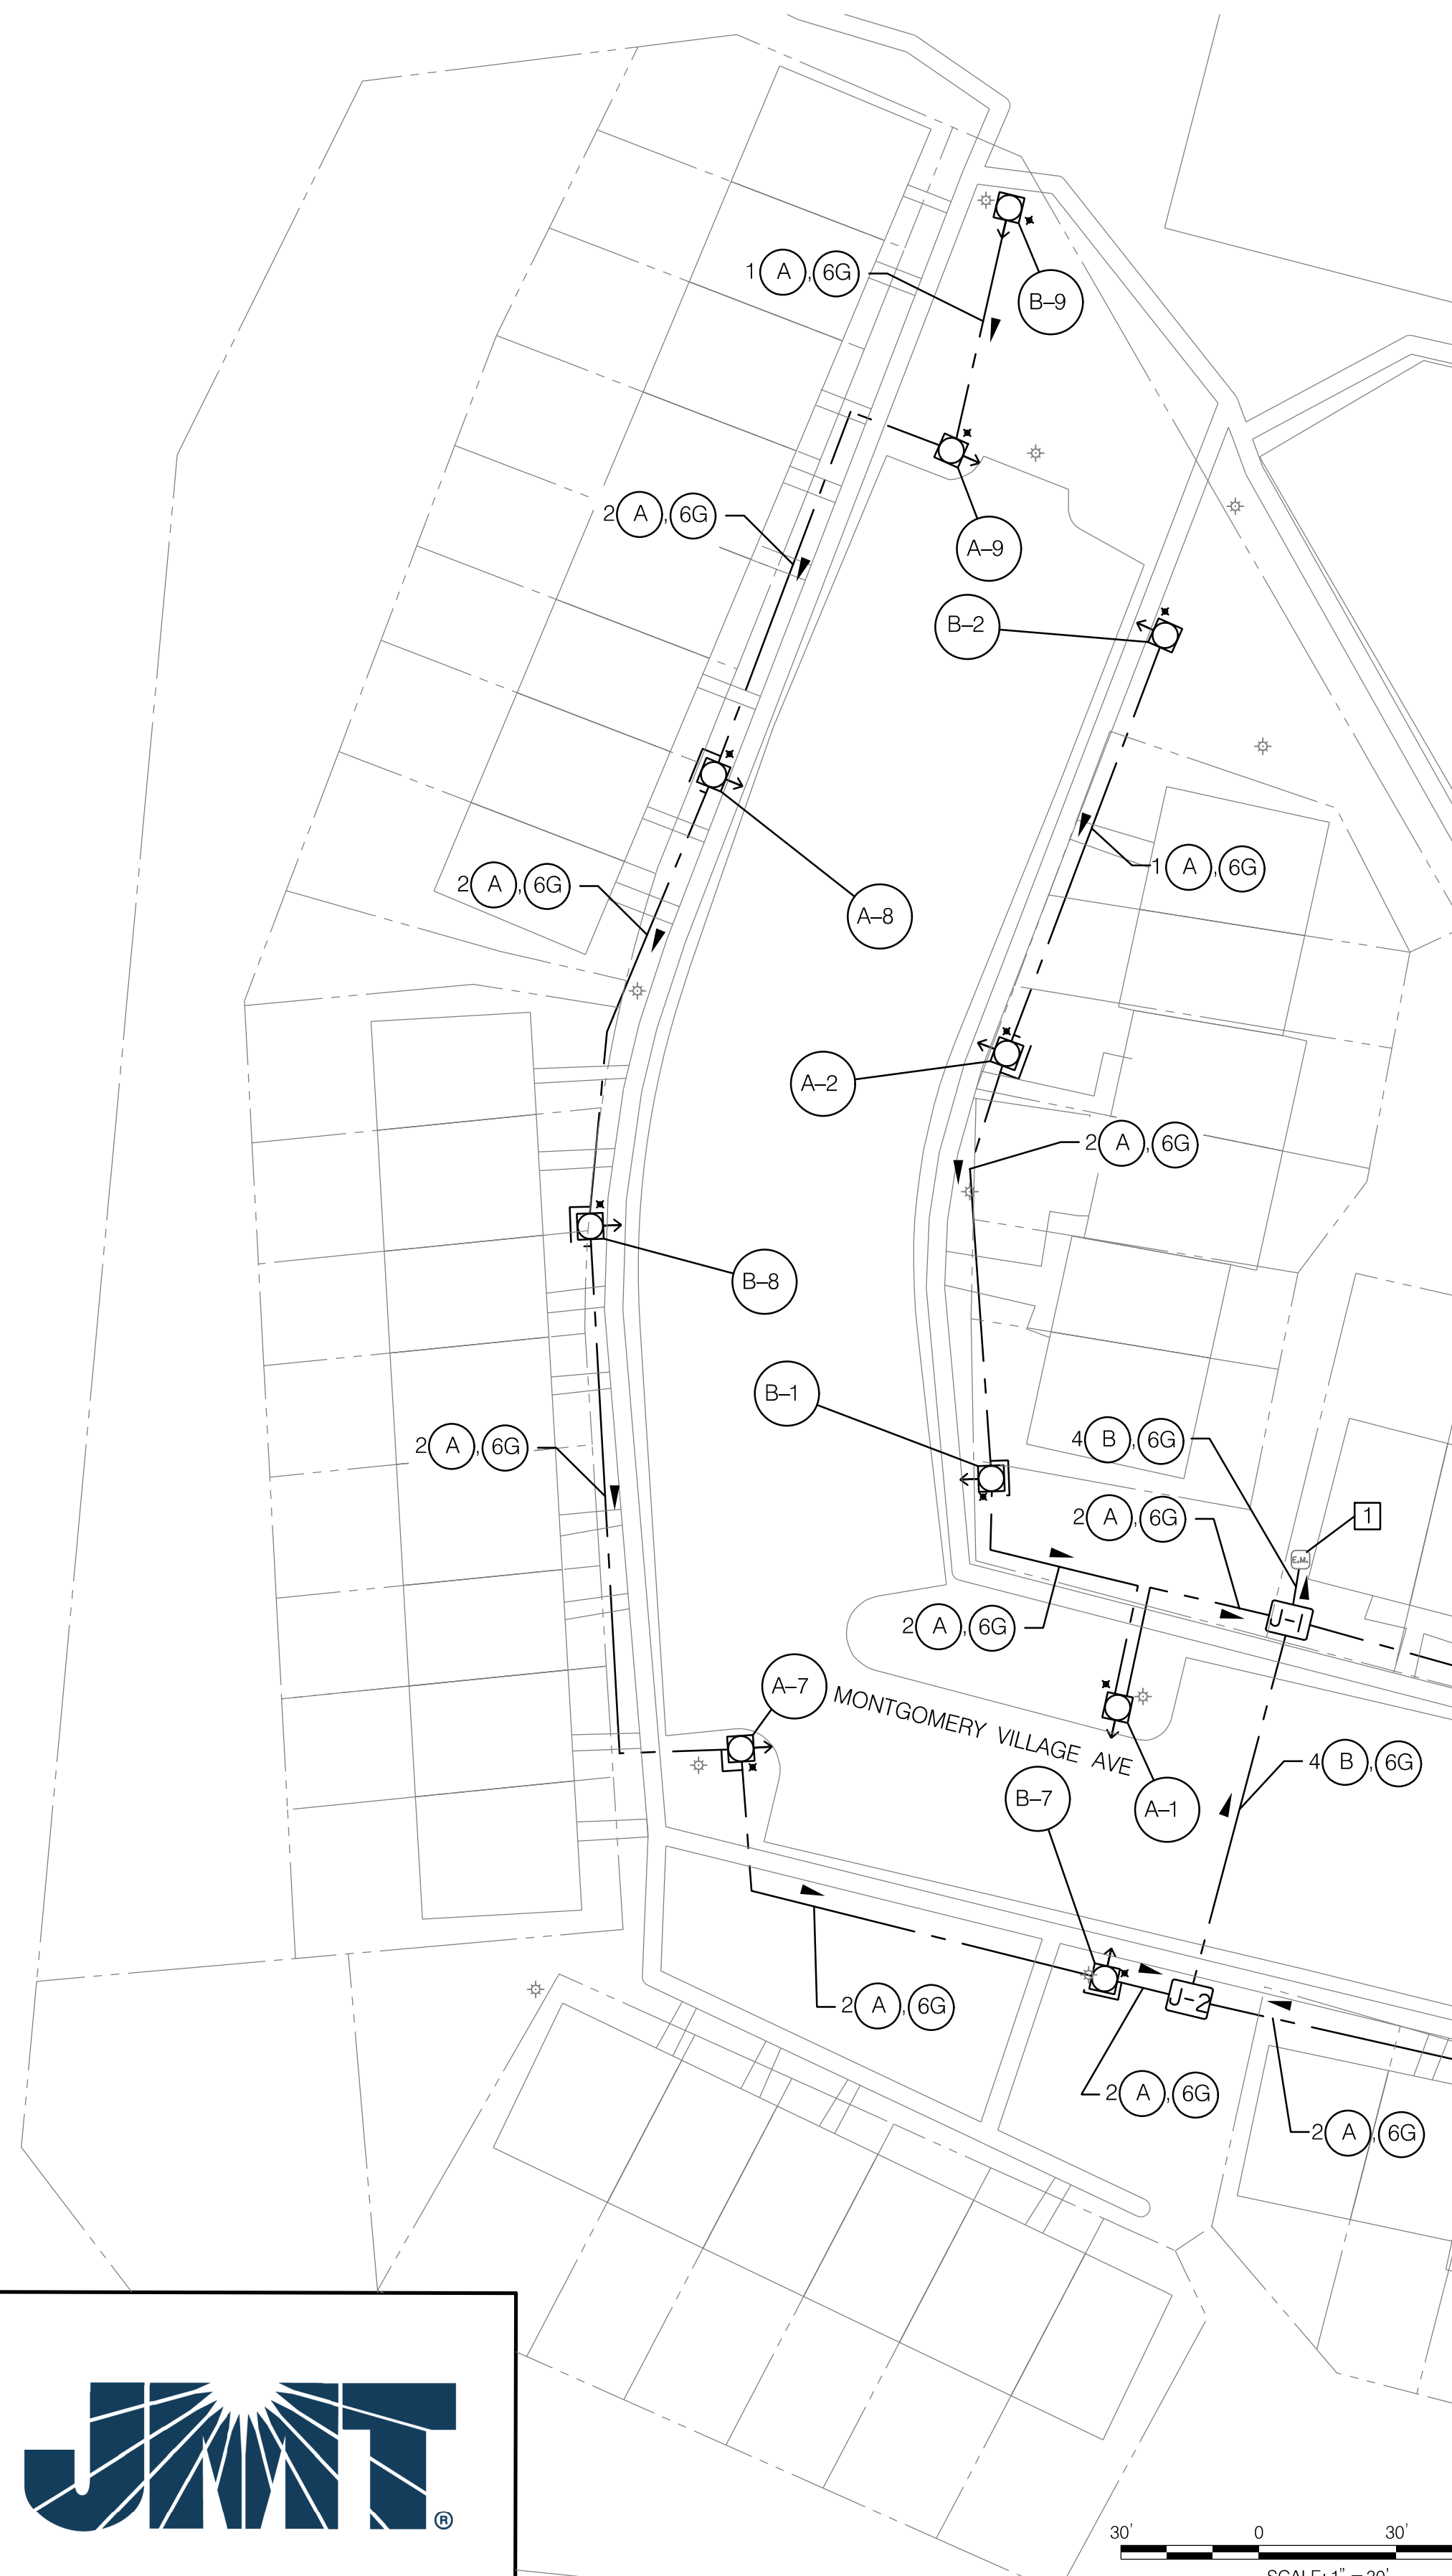

MATCH LINE - SEE SHEET LT-02

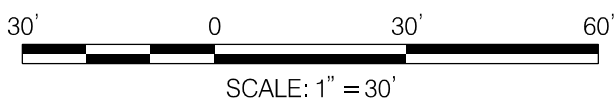

BY: aborkiewicz -



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 GERARD ADAMS BAXTER, II, PE




MONTGOMERY COUNTY
 DEPARTMENT OF HOUSING AND COMMUNITY AFFAIRS
MONTGOMERY VILLAGE /SOUTH VILLAGE HOMES
 LIGHTING AND SITE IMPROVEMENTS PROJECT

LIGHTING PLAN - CENTER STAGE

SCALE: 30 SCALE, ADVERTISED DATE: N/A, CONTRACT NO. _____

DESIGNED BY: AHB COUNTY: MONTGOMERY COUNTY
 DRAWN BY: AHB LOGMILE: _____
 CHECKED BY: GAB
 DPS PERMIT: _____

DRAWING NO. **LT-01** OF **10** SHEET NO. 22 OF 46

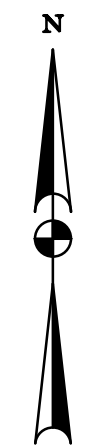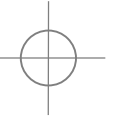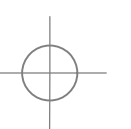

MATCH LINE - SEE SHEET LT-01



EQUIPMENT SCHEDULE			
CATEGORY CODE	DESCRIPTION	UNIT	QUANTITY
801003	CONCRETE FOR LIGHT FOUNDATION	CY	16.9
832020	BARE COPPER WIRE, NO. 6 AWG	LF	2500
806025	LED ROADWAY LUMINAIRE	EA	13
800000	12 FOOT DECORATIVE POLE	EA	13
832001	DUCT CABLE - 2 CONDUCTOR, NO. 6 AWG 600V	LF	2350
832016	CABLE - CONDUCTOR, NO. 6 AWG 600V	LF	80
837001	GROUND ROD = 3/4 INCH DIAMETER 10 FOOT LENGTH	EA	13
834001	CONNECTOR KIT - TYPE I	EA	2
834002	CONNECTOR KIT - TYPE II	EA	8
834003	CONNECTOR KIT - TYPE III	EA	18
834004	CONNECTOR KIT - TYPE IV	EA	0
811001	JUNCTION BOX	EA	1
805125	2 INCH SCHEDULE 80 RIGID PVC CONDUIT	LF	40
807301	20 AMP DISCONNECT SWITCH, SINGLE PHASE	EA	0

NOTES:

- MIX 3 CONCRETE COMPENSATION INCLUDES ALL CONCRETE, EXCAVATION, REINFORCEMENT STEEL, ANCHOR BOLTS, BACKFILL, MATERIAL, LABOR EQUIPMENT AND TOOLS TO COMPLETE THE WORK.
- CABLE AND GROUND WIRE COMPENSATION INCLUDES ALL EXCAVATION, BACKFILL, MATERIAL, LABOR EQUIPMENT AND TOOLS TO COMPLETE THE WORK.
- JUNCTION BOX INCLUDES ALL EXCAVATION, BACKFILL, MATERIAL, LABOR EQUIPMENT AND TOOLS TO COMPLETE THE WORK. JUNCTION BOX INSTALLATION TO BE FLUSH WITH EXISTING GRADE.
- CABLE FROM CABINET TO JUNCTION BOX SHALL BE INSTALLED IN EXISTING CONDUIT. CONDUIT SHALL BE RE-ROUTED TO THE PROPOSED JUNCTION BOX. IF RE-ROUTING IS NOT FEASIBLE, CONTRACTOR TO PROVIDE NEW 2" SCHEDULE 80 PVC CONDUIT.
- CABLE BENEATH ROADWAY TO BE INSTALLED IN 2" SCHEDULE 80 PVC CONDUIT.

HOUSESIDE SHIELD TABLE	
EQUIPMENT	TYPE
A-10 B-3, B-4, B-6	GVDHSS180

- (A) 832001, DUCT CABLE - 2 CONDUCTOR, NO. 6 AWG 600V
- (B) 832016 CABLE - 1 CONDUCTOR NO. 6 AWG, TYPE USE
- (6G) 832020, BARE COPPER WIRE, NO. 6 AWG

CONNECTOR KIT SCHEDULE				
STRUCTURE	TYPE I KIT	TYPE II KIT	TYPE III KIT	TYPE IV KIT
J-3	2	0	0	0
A-3	0	0	2	0
A-4	0	0	2	0
A-5	0	0	2	0
A-6	0	2	0	0
A-10	0	0	2	0
A-11	0	0	2	0
A-12	0	2	0	0
B-3	0	0	2	0
B-4	0	0	2	0
B-5	0	0	2	0
B-6	0	2	0	0
B-10	0	0	2	0
B-11	0	2	0	0

LEGEND:

- PROPOSED LIGHT POLE AND LUMINAIRE
- INDICATOR FOR DIRECTION OF LIGHT
- GROUNDING ROD
- CABLE RUN
- EX. ELECTRIC METER
- JUNCTION BOX



MONTGOMERY COUNTY
DEPARTMENT OF HOUSING AND COMMUNITY AFFAIRS
MONTGOMERY VILLAGE /SOUTH VILLAGE HOMES
LIGHTING AND SITE IMPROVEMENTS PROJECT

PROFESSIONAL CERTIFICATION

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GERARD ADAMS BAXTER, II, PE

LIGHTING PLAN - CENTER STAGE


SCALE: 30 SCALE, ADVERTISED DATE: N/A CONTRACT NO. _____

DESIGNED BY: AHB COUNTY: MONTGOMERY COUNTY
DRAWN BY: AHB LOGMILE: _____
CHECKED BY: GAB
DPS PERMIT: _____

DRAWING NO. **LT-02** OF **10** SHEET NO. 23 OF 46

GENERAL NOTES:

- SEE GENERAL NOTES; SHEET LT-01
- SEE LIGHTING CONTROL CABINET INFORMATION LT-01
- CONTRACTOR TO USE EXISTING LIGHTING CONDUIT FOR A-12

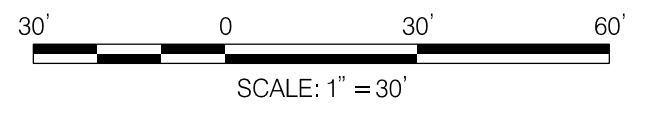

BY: aborkiewicz -

EQUIPMENT SCHEDULE			
CATEGORY CODE	DESCRIPTION	UNIT	QUANTITY
801003	CONCRETE FOR LIGHT FOUNDATION	CY	24.7
832020	BARE COPPER WIRE, NO. 6 AWG	LF	4600
806025	LED ROADWAY LUMINAIRE	EA	19
800000	12 FOOT DECORATIVE POLE	EA	19
832001	DUCT CABLE - 2 CONDUCTOR, NO. 6 AWG 600V	LF	4000
832016	CABLE - CONDUCTOR, NO. 6 AWG 600V	LF	540
837001	GROUND ROD = 3/4 INCH DIAMETER 10 FOOT LENGTH	EA	19
834001	CONNECTOR KIT - TYPE I	EA	28
834002	CONNECTOR KIT - TYPE II	EA	14
834003	CONNECTOR KIT - TYPE III	EA	24
834004	CONNECTOR KIT - TYPE IV	EA	16
811001	JUNCTION BOX	EA	12
838014	REMOTE LIGHTING CABINET 60 AMP	EA	1
805125	2 INCH SCHEDULE 80 RIGID PVC CONDUIT	LF	160
807301	20 AMP DISCONNECT SWITCH, SINGLE PHASE	EA	2

NOTES:

- MIX 3 CONCRETE COMPENSATION INCLUDES ALL CONCRETE, EXCAVATION, REINFORCEMENT STEEL, ANCHOR BOLTS, BACKFILL, MATERIAL, LABOR EQUIPMENT AND TOOLS TO COMPLETE THE WORK.
- CABLE AND GROUND WIRE COMPENSATION INCLUDES ALL EXCAVATION, BACKFILL, MATERIAL, LABOR EQUIPMENT AND TOOLS TO COMPLETE THE WORK.
- JUNCTION BOX INCLUDES ALL EXCAVATION, BACKFILL, MATERIAL, LABOR EQUIPMENT AND TOOLS TO COMPLETE THE WORK. JUNCTION BOX INSTALLATION TO BE FLUSH WITH EXISTING GRADE.
- CABLE FROM CABINET TO JUNCTION BOX SHALL BE INSTALLED IN EXISTING CONDUIT. CONDUIT SHALL BE RE-ROUTED TO THE PROPOSED JUNCTION BOX. IF RE-ROUTING IS NOT FEASIBLE, CONTRACTOR TO PROVIDE NEW 2" SCHEDULE 80 PVC CONDUIT.
- CABLE BENEATH ROADWAY TO BE INSTALLED IN 2" SCHEDULE 80 PVC CONDUIT.

KEY NOTES:

- NEW POST-MOUNTED ELECTRICAL SERVICE PANEL WITH PHOTOCELL FOR "C" AND "D" CIRCUITS AT 9402 WALBURG WAY. CONTRACTOR TO COORDINATE WITH PEPCO TO TURN OFF POWER AT THE METER TO INSTALL PANEL.

(A)	832001, DUCT CABLE - 2 CONDUCTOR, NO. 6 AWG 600V
(B)	832016 CABLE - 1 CONDUCTOR NO. 6 AWG, TYPE USE
(6G)	832020, BARE COPPER WIRE, NO. 6 AWG

GENERAL NOTES:

- SEE GENERAL NOTES ON SHEET LT-01
- SEE LIGHTING CONTROL CABINET INFORMATION LT-05
- SEE CONNECTOR KIT SCHEDULE ON SHEET LT-05.

LEGEND:

- PROPOSED LIGHT POLE AND LUMINAIRE
- INDICATOR FOR DIRECTION OF LIGHT
- GROUNDING ROD
- CABLE RUN
- EX. ELECTRIC METER
- JUNCTION BOX



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GERARD ADAMS BAXTER, II, PE


MONTGOMERY COUNTY
DEPARTMENT OF HOUSING AND COMMUNITY AFFAIRS
MONTGOMERY VILLAGE / SOUTH VILLAGE HOMES
LIGHTING AND SITE IMPROVEMENTS PROJECT

LIGHTING PLAN - GROVERS FORGE

SCALE: 30' SCALE, ADVERTISED DATE: N/A, CONTRACT NO. _____


DESIGNED BY: AHB COUNTY: MONTGOMERY COUNTY
DRAWN BY: AHB LOGMILE: _____
CHECKED BY: GAB
DPS PERMIT: _____

DRAWING NO. **LT-03** OF **10** SHEET NO. 24 OF 46

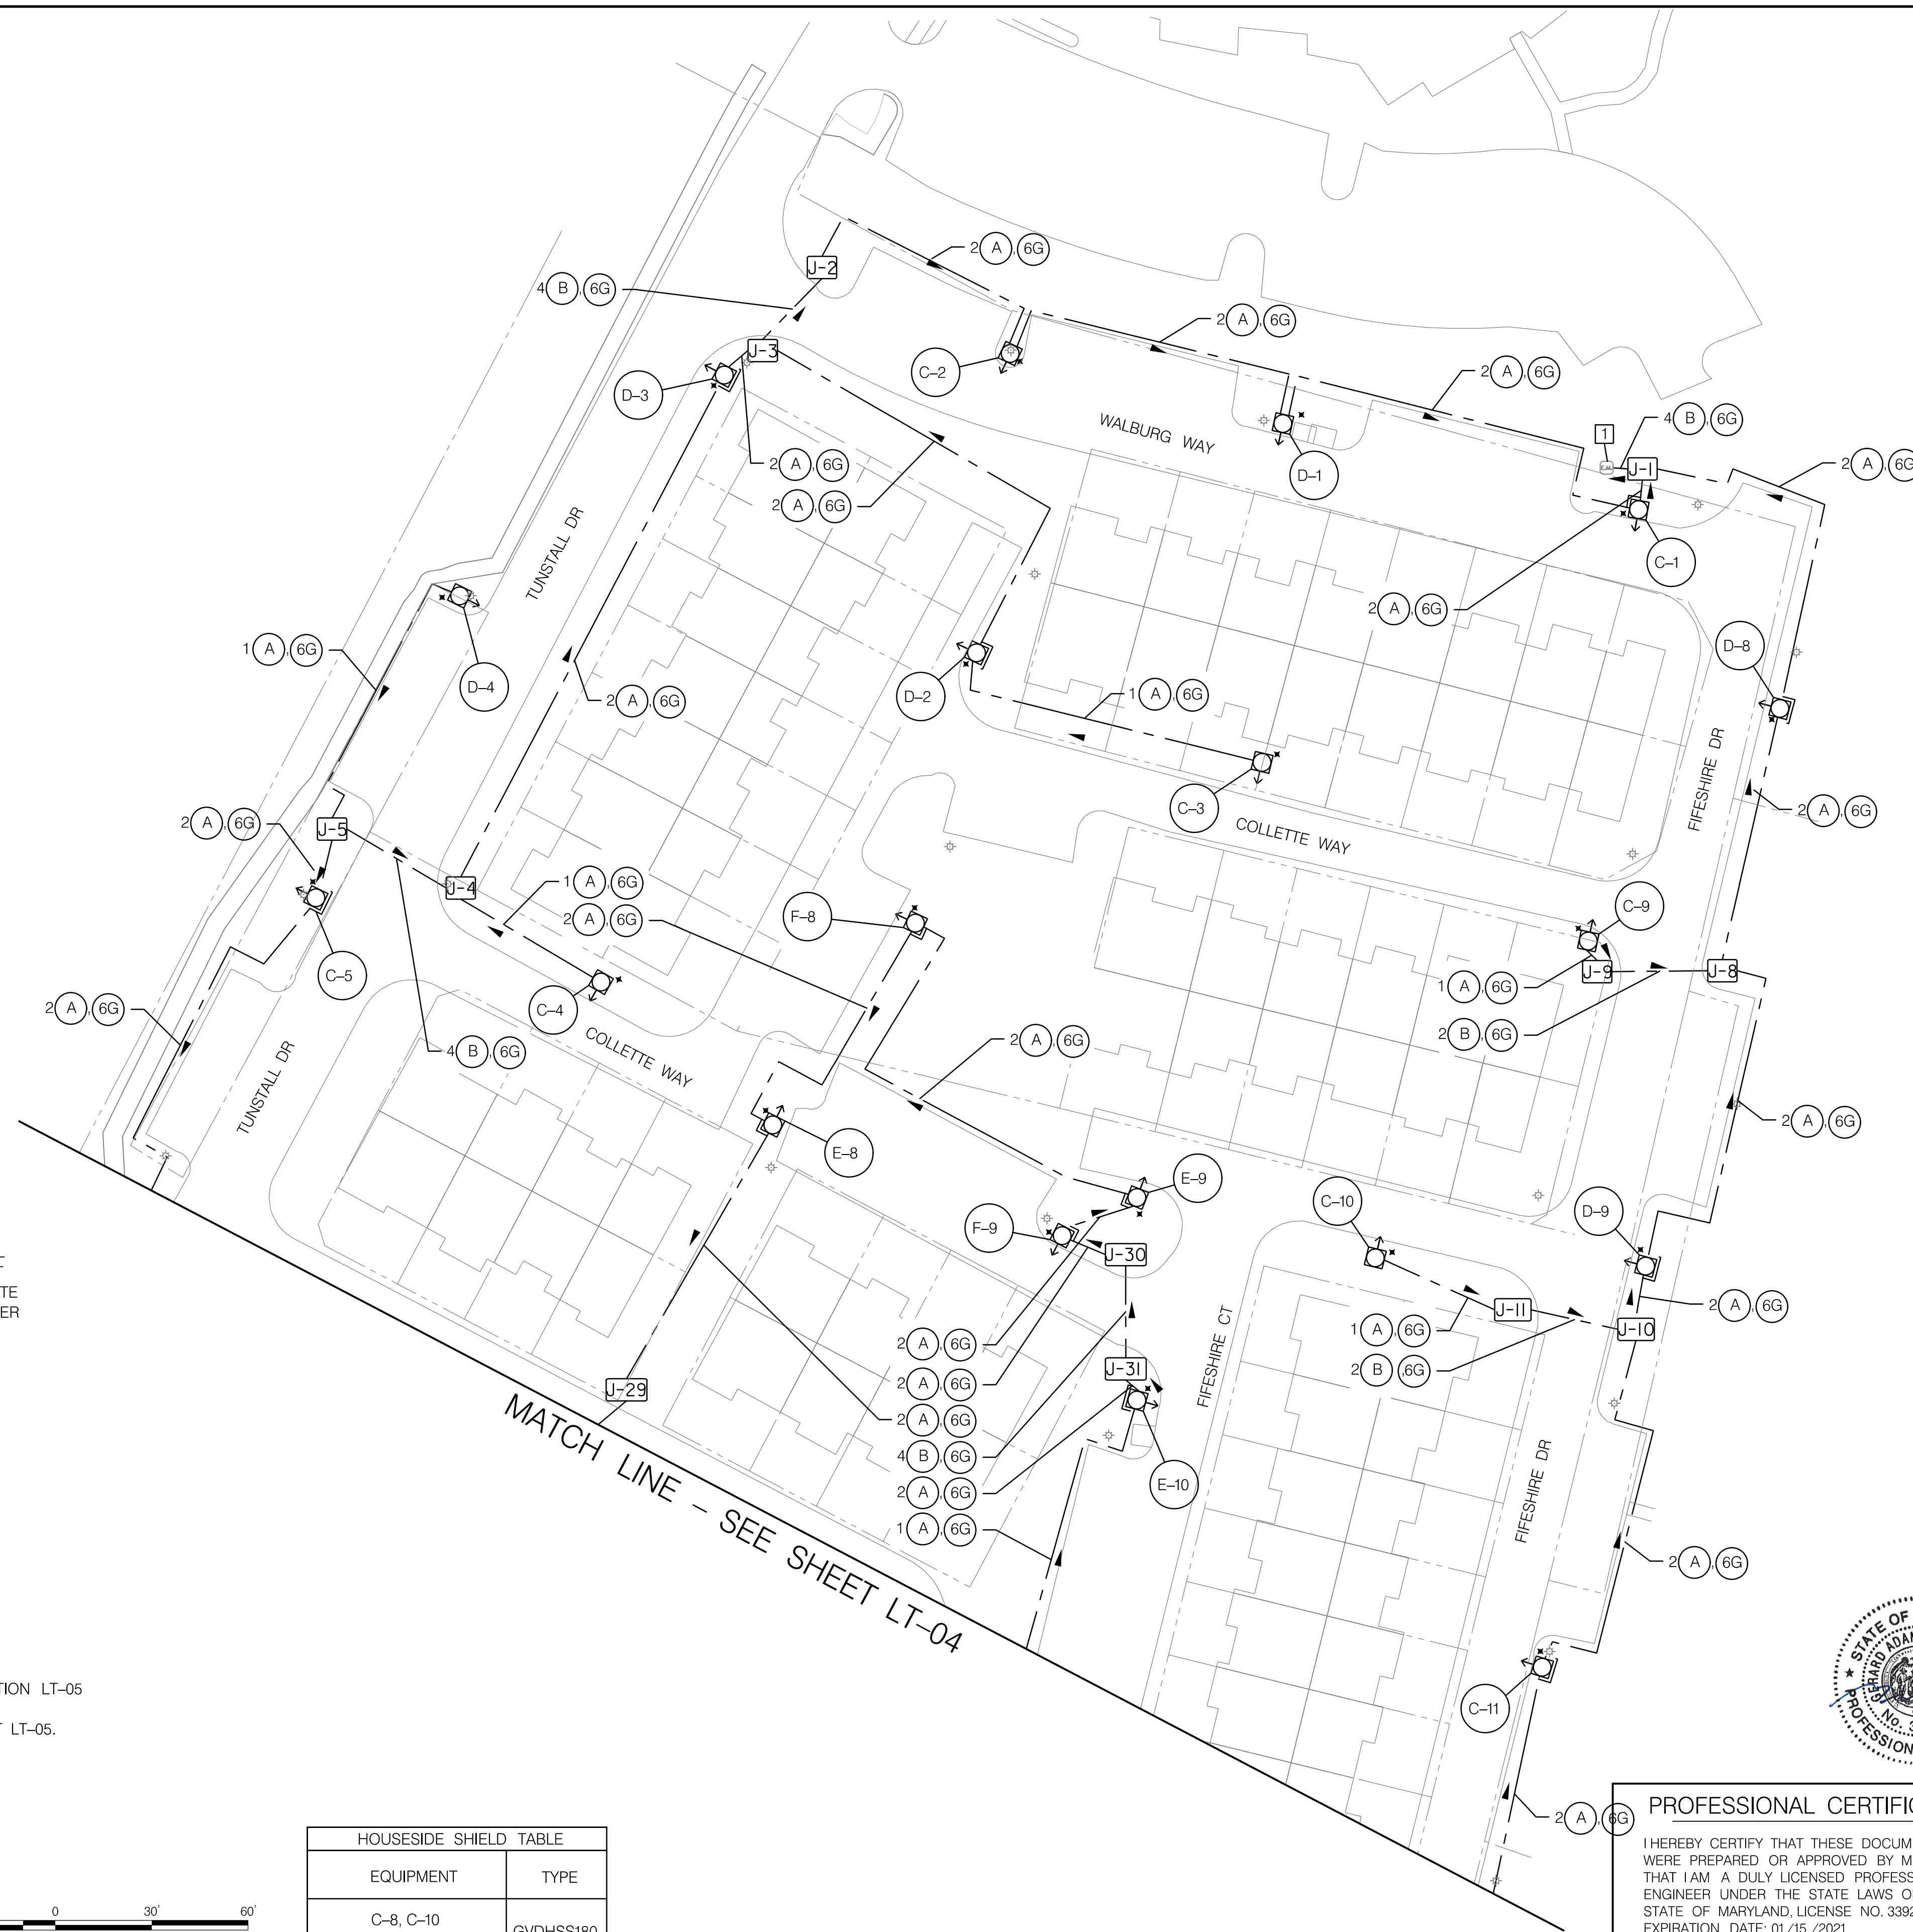

MATCH LINE - SEE SHEET LT-04

HOUSESIDE SHIELD TABLE	
EQUIPMENT	TYPE
C-8, C-10 D-10	GVDHSS180

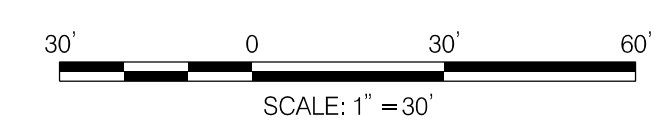

BY: abortkewicz -


EQUIPMENT SCHEDULE			
CATEGORY CODE	DESCRIPTION	UNIT	QUANTITY
801003	CONCRETE FOR LIGHT FOUNDATION	CY	59.8
832020	BARE COPPER WIRE, NO. 6 AWG	LF	7600
806025	LED ROADWAY LUMINAIRE	EA	46
800000	12 FOOT DECORATIVE POLE	EA	46
832001	DUCT CABLE - 2 CONDUCTOR, NO. 6 AWG 600V	LF	6200
832016	CABLE - CONDUCTOR, NO. 6 AWG 600V	LF	1750
837001	GROUND ROD = 3/4 INCH DIAMETER 10 FOOT LENGTH	EA	46
834001	CONNECTOR KIT - TYPE I	EA	48
834002	CONNECTOR KIT - TYPE II	EA	44
834003	CONNECTOR KIT - TYPE III	EA	48
834004	CONNECTOR KIT - TYPE IV	EA	38
811001	JUNCTION BOX	EA	24
838014	REMOTE LIGHTING CABINET 60 AMP	EA	1
805125	2 INCH SCHEDULE 80 RIGID PVC CONDUIT	LF	550
807301	20 AMP DISCONNECT SWITCH, SINGLE PHASE	EA	2



- NOTES:**
- MIX 3 CONCRETE COMPENSATION INCLUDES ALL CONCRETE, EXCAVATION, REINFORCEMENT STEEL, ANCHOR BOLTS, BACKFILL, MATERIAL, LABOR EQUIPMENT AND TOOLS TO COMPLETE THE WORK.
 - CABLE AND GROUND WIRE COMPENSATION INCLUDES ALL EXCAVATION, BACKFILL, MATERIAL, LABOR EQUIPMENT AND TOOLS TO COMPLETE THE WORK.
 - JUNCTION BOX INCLUDES ALL EXCAVATION, BACKFILL, MATERIAL, LABOR EQUIPMENT AND TOOLS TO COMPLETE THE WORK. JUNCTION BOX INSTALLATION TO BE FLUSH WITH EXISTING GRADE.
 - CABLE FROM CABINET TO JUNCTION BOX SHALL BE INSTALLED IN EXISTING CONDUIT. CONDUIT SHALL BE RE-ROUTED TO THE PROPOSED JUNCTION BOX. IF RE-ROUTING IS NOT FEASIBLE, CONTRACTOR TO PROVIDE NEW 2" SCHEDULE 80 PVC CONDUIT.
 - CABLE BENEATH ROADWAY TO BE INSTALLED IN 2" SCHEDULE 80 PVC CONDUIT.

- (A) 832001, DUCT CABLE - 2 CONDUCTOR, NO. 6 AWG 600V
- (B) 832016 CABLE - 1 CONDUCTOR NO. 6 AWG, TYPE USE
- (6G) 832020, BARE COPPER WIRE, NO. 6 AWG

- LEGEND:**
- PROPOSED LIGHT POLE AND LUMINAIRE
 - INDICATOR FOR DIRECTION OF LIGHT
 - GROUNDING ROD
 - CABLE RUN
 - EX. ELECTRIC METER
 - JUNCTION BOX

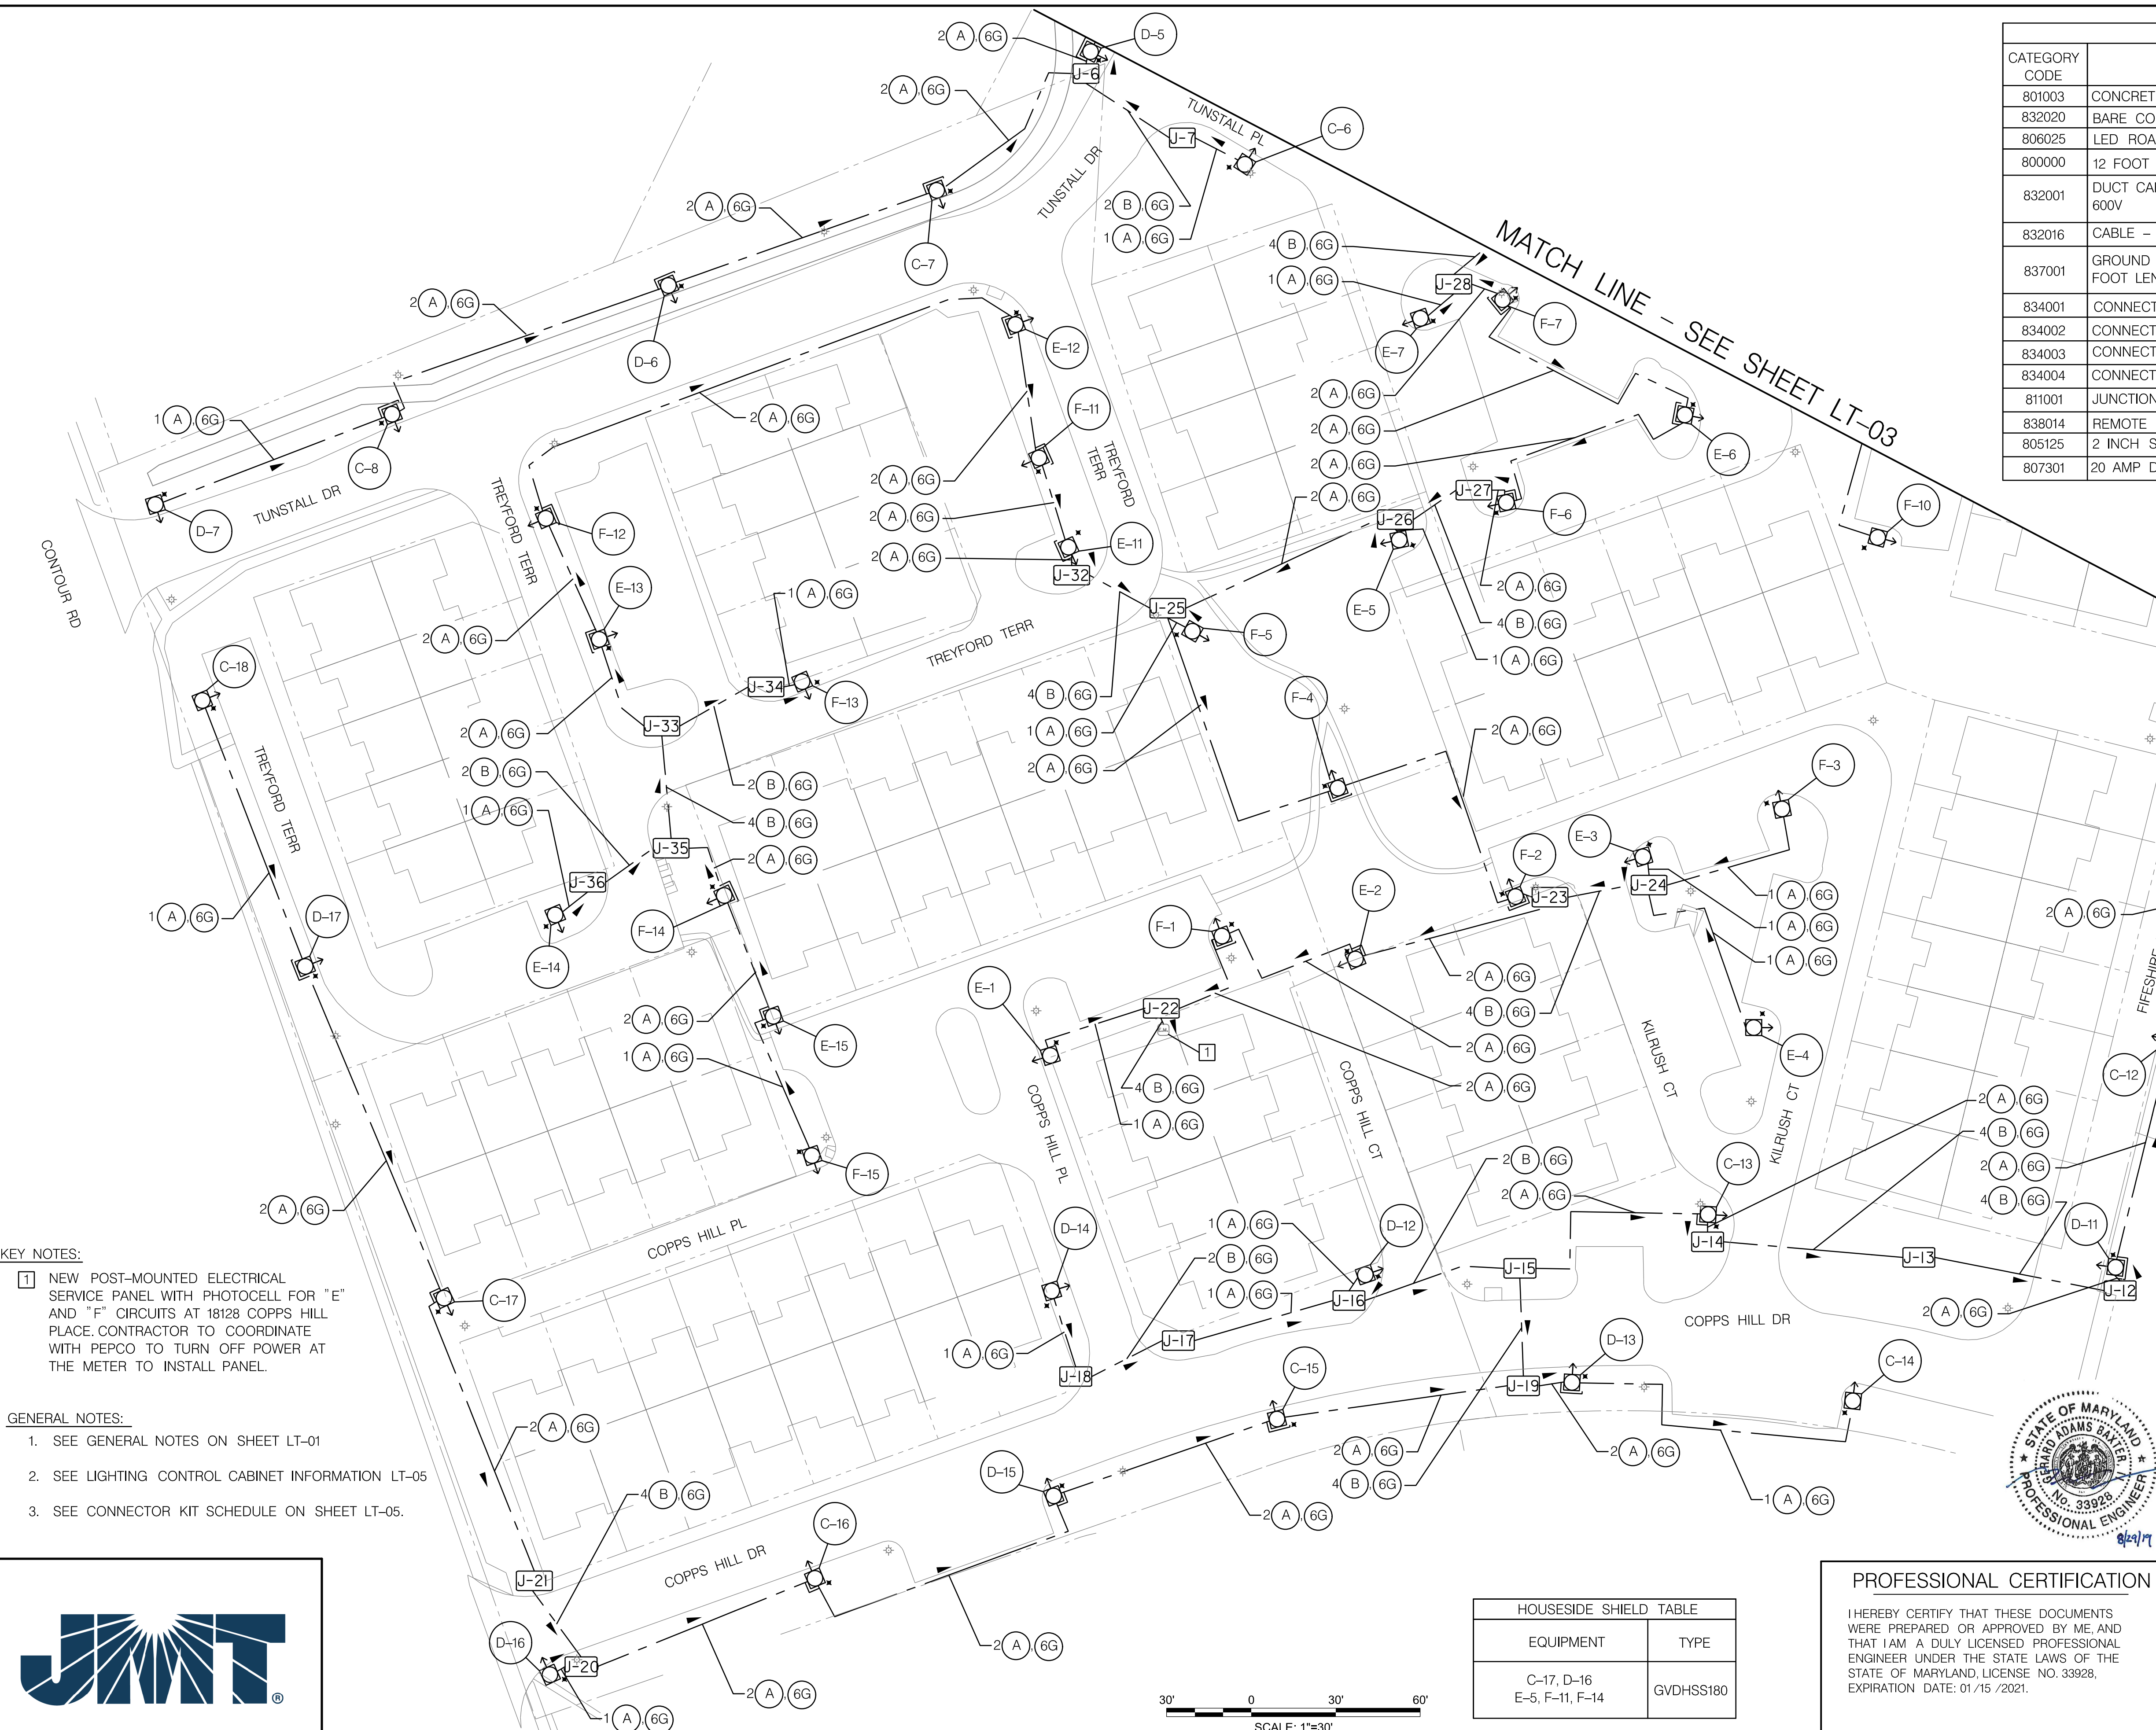

KEY NOTES:

1 NEW POST-MOUNTED ELECTRICAL SERVICE PANEL WITH PHOTOCELL FOR "E" AND "F" CIRCUITS AT 18128 COPPS HILL PLACE. CONTRACTOR TO COORDINATE WITH PEPCO TO TURN OFF POWER AT THE METER TO INSTALL PANEL.

GENERAL NOTES:


- SEE GENERAL NOTES ON SHEET LT-01
- SEE LIGHTING CONTROL CABINET INFORMATION LT-05
- SEE CONNECTOR KIT SCHEDULE ON SHEET LT-05.



BY: aborkiewicz -

PLOTTED: Thursday, August 29, 2019 AT 11:30 AM
 FILE: G:\2019\130707_003_Montgomery_Village_ICADD\PHD-Baseline.dgn

HOUSESIDE SHIELD TABLE	
EQUIPMENT	TYPE
C-17, D-16 E-5, F-11, F-14	GVDHSS180

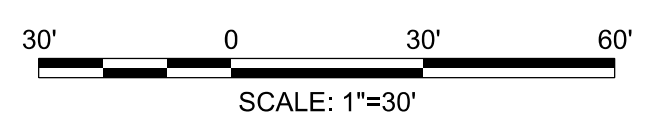

PROFESSIONAL CERTIFICATION

I HEREBY CERTIFY THAT THESE DOCUMENTS WERE PREPARED OR APPROVED BY ME, AND THAT I AM A DULY LICENSED PROFESSIONAL ENGINEER UNDER THE STATE LAWS OF THE STATE OF MARYLAND, LICENSE NO. 33928, EXPIRATION DATE: 01/15/2021.

GERARD ADAMS BAXTER, II, PE



MONTGOMERY COUNTY
 DEPARTMENT OF HOUSING AND COMMUNITY AFFAIRS
 MONTGOMERY VILLAGE /SOUTH VILLAGE HOMES
 LIGHTING AND SITE IMPROVEMENTS PROJECT

LIGHTING PLAN - GROVERS FORGE	
SCALE: 30' SCALE	ADVERTISED DATE: N/A CONTRACT NO. _____
DESIGNED BY: AHB	COUNTY: MONTGOMERY COUNTY
DRAWN BY: AHB	LOGMILE: _____
CHECKED BY: GAB	
DPS PERMIT: _____	
DRAWING NO. LT-04 OF 10	SHEET NO. 25 OF 46

PROPOSED 60 AMP METERED SERVICE PANEL SCHEDULE - 9402 WALBURG WAY							
CIRCUIT NUMBER	CONDUCTOR SIZE	EQUIPMENT SERVED	CONNECTED LOADS		NUMBER OF LOADS		REMARKS
			KW	AMPS	NO. OF POLES	TRIP SIZE	
1, 3	NO. 6 AWG	PEDESTRIAN LIGHTING: C-1 - C-18	0.702	3.24	2	20	(18) - 39 W LED LUMINAIRES
2, 4	NO. 6 AWG	PEDESTRIAN LIGHTING: D-1 - D-17	0.663	3.06	2	20	(17) - 39 W LED LUMINAIRES
5		SPARE			1	20	
6		SPARE			1	20	

PROPOSED 60 AMP METERED SERVICE PANEL SCHEDULE - 18128 COPPS HILL PLACE							
CIRCUIT NUMBER	CONDUCTOR SIZE	EQUIPMENT SERVED	CONNECTED LOADS		NUMBER OF LOADS		REMARKS
			KW	AMPS	NO. OF POLES	TRIP SIZE	
1, 3	NO. 6 AWG	PEDESTRIAN LIGHTING: E-1 - E-15	0.585	2.70	2	20	(15) - 39 W LED LUMINAIRES
2, 4	NO. 6 AWG	PEDESTRIAN LIGHTING: F-1 - F-15	0.585	2.70	2	20	(15) - 39 W LED LUMINAIRES
5		EXISTING			1	20	
6		EXISTING			1	20	

JUNCTION BOX CONNECTOR KIT SCHEDULE				
STRUCTURE	TYPE I KIT	TYPE II KIT	TYPE III KIT	TYPE IV KIT
J-1	0	0	0	4
J-2	4	0	0	0
J-3	0	0	0	4
J-4	2	0	0	2
J-5	2	0	0	2
J-6	2	0	0	2
J-7	2	0	0	0
J-8	2	0	0	2
J-9	2	0	0	0
J-10	2	0	0	2
J-11	2	0	0	0
J-12	4	0	0	0
J-13	4	0	0	0
J-14	4	0	0	0
J-15	0	0	0	4
J-16	4	0	0	0
J-17	2	0	0	0
J-18	2	0	0	0
J-19	0	0	0	4
J-20	2	0	0	2
J-21	4	0	0	0
J-22	2	0	0	2
J-23	0	0	0	4
J-24	2	0	0	2
J-25	0	0	0	6
J-26	0	0	0	4
J-27	0	0	0	2
J-28	2	0	0	2
J-29	4	0	0	0
J-30	4	0	0	0
J-31	4	0	0	0
J-32	4	0	0	0
J-33	2	0	0	2
J-34	2	0	0	0
J-35	2	0	0	2
J-36	2	0	0	0

STREET LIGHT CONNECTOR KIT SCHEDULE		
STRUCTURE	TYPE II KIT	TYPE III KIT
C-1	0	2
C-2	0	2
C-3	2	0
C-4	2	0
C-5	0	2
C-6	2	0
C-7	0	2
C-8	2	0
C-9	2	0
C-10	2	0
C-11	0	2
C-12	0	2
C-13	0	2
C-14	2	0
C-15	0	2
C-16	0	2
C-17	0	2
C-18	2	0
D-1	0	2
D-2	2	0
D-3	0	2
D-4	2	0
D-5	0	2
D-6	0	2
D-7	2	0
D-8	0	2
D-9	0	2
D-10	0	2
D-11	0	2
D-12	2	0
D-13	2	0
D-14	2	0
D-15	0	2
D-16	2	0
D-17	2	0

STREET LIGHT CONNECTOR KIT SCHEDULE		
STRUCTURE	TYPE II KIT	TYPE III KIT
E-1	2	0
E-2	0	2
E-3	2	0
E-4	2	0
E-5	2	0
E-6	0	2
E-7	2	0
E-8	0	2
E-9	0	2
E-10	2	0
E-11	0	2
E-12	0	2
E-13	0	2
E-14	2	0
E-15	2	0
F-1	0	2
F-2	0	2
F-3	2	0
F-4	0	2
F-5	2	0
F-6	0	2
F-7	0	2
F-8	0	2
F-9	0	2
F-10	2	0
F-11	0	2
F-12	0	2
F-13	2	0
F-14	0	2
F-15	2	0



PROFESSIONAL CERTIFICATION

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GERARD ADAMS BAXTER, II, PE

MONTGOMERY COUNTY
DEPARTMENT OF HOUSING AND COMMUNITY AFFAIRS
MONTGOMERY VILLAGE /SOUTH VILLAGE HOMES
LIGHTING AND SITE IMPROVEMENTS PROJECT

LIGHTING PLAN - GROVERS FORGE

SCALE: N.T.S. ADVERTISED DATE: N/A CONTRACT NO. _____

DESIGNED BY: AHB COUNTY: MONTGOMERY COUNTY
DRAWN BY: AHB LOGMILE: _____
CHECKED BY: GAB
DPS PERMIT: _____

DRAWING NO. **LT-05** OF **10** SHEET NO. 26 OF 46




BY: abortkewicz -

EXISTING METERED SERVICE PANEL SCHEDULE - 18046 ROYAL BONNET TERRACE							
CIRCUIT NUMBER	CONDUCTOR SIZE	EQUIPMENT SERVED	CONNECTED LOADS		NUMBER OF LOADS		REMARKS
			KW	AMPS	NO. OF POLES	TRIP SIZE	
1, 3	NO. 6 AWG	PEDESTRIAN LIGHTING: G-1 - G-9	0.351	1.62	2	20	(9) - 39 W LED LUMINAIRES
2, 4	NO. 6 AWG	PEDESTRIAN LIGHTING: H-1 - H-9	0.351	1.62	2	20	(9) - 39 W LED LUMINAIRES
5-16		EXISTING AND SPARES					

NOTE:
UNABLE TO VERIFY CIRCUIT NUMBERS. SPARES AVAILABLE PER ELECTRICAL REPORT.

CONNECTOR KIT SCHEDULE				
STRUCTURE	TYPE I KIT	TYPE II KIT	TYPE III KIT	TYPE IV KIT
J-1	2	0	0	2
J-2	2	0	0	2
J-3	2	0	0	2
J-4	2	0	0	0
J-5	2	0	0	2
J-6	2	0	0	0
J-7	2	0	0	2
J-8	2	0	0	0
J-9	2	0	0	2
J-10	2	0	0	0
G-1	0	2	0	0
G-2	0	0	2	0
G-3	0	2	0	0
G-4	0	0	2	0
G-5	0	2	0	0
G-6	0	0	2	0
G-7	0	0	2	0
G-8	0	0	2	0
G-9	0	2	0	0
H-1	0	2	0	0
H-2	0	0	2	0
H-3	0	0	2	0
H-4	0	0	2	0
H-5	0	0	2	0
H-6	0	0	2	0
H-7	0	2	0	0
H-8	0	0	2	0
H-9	0	2	0	0

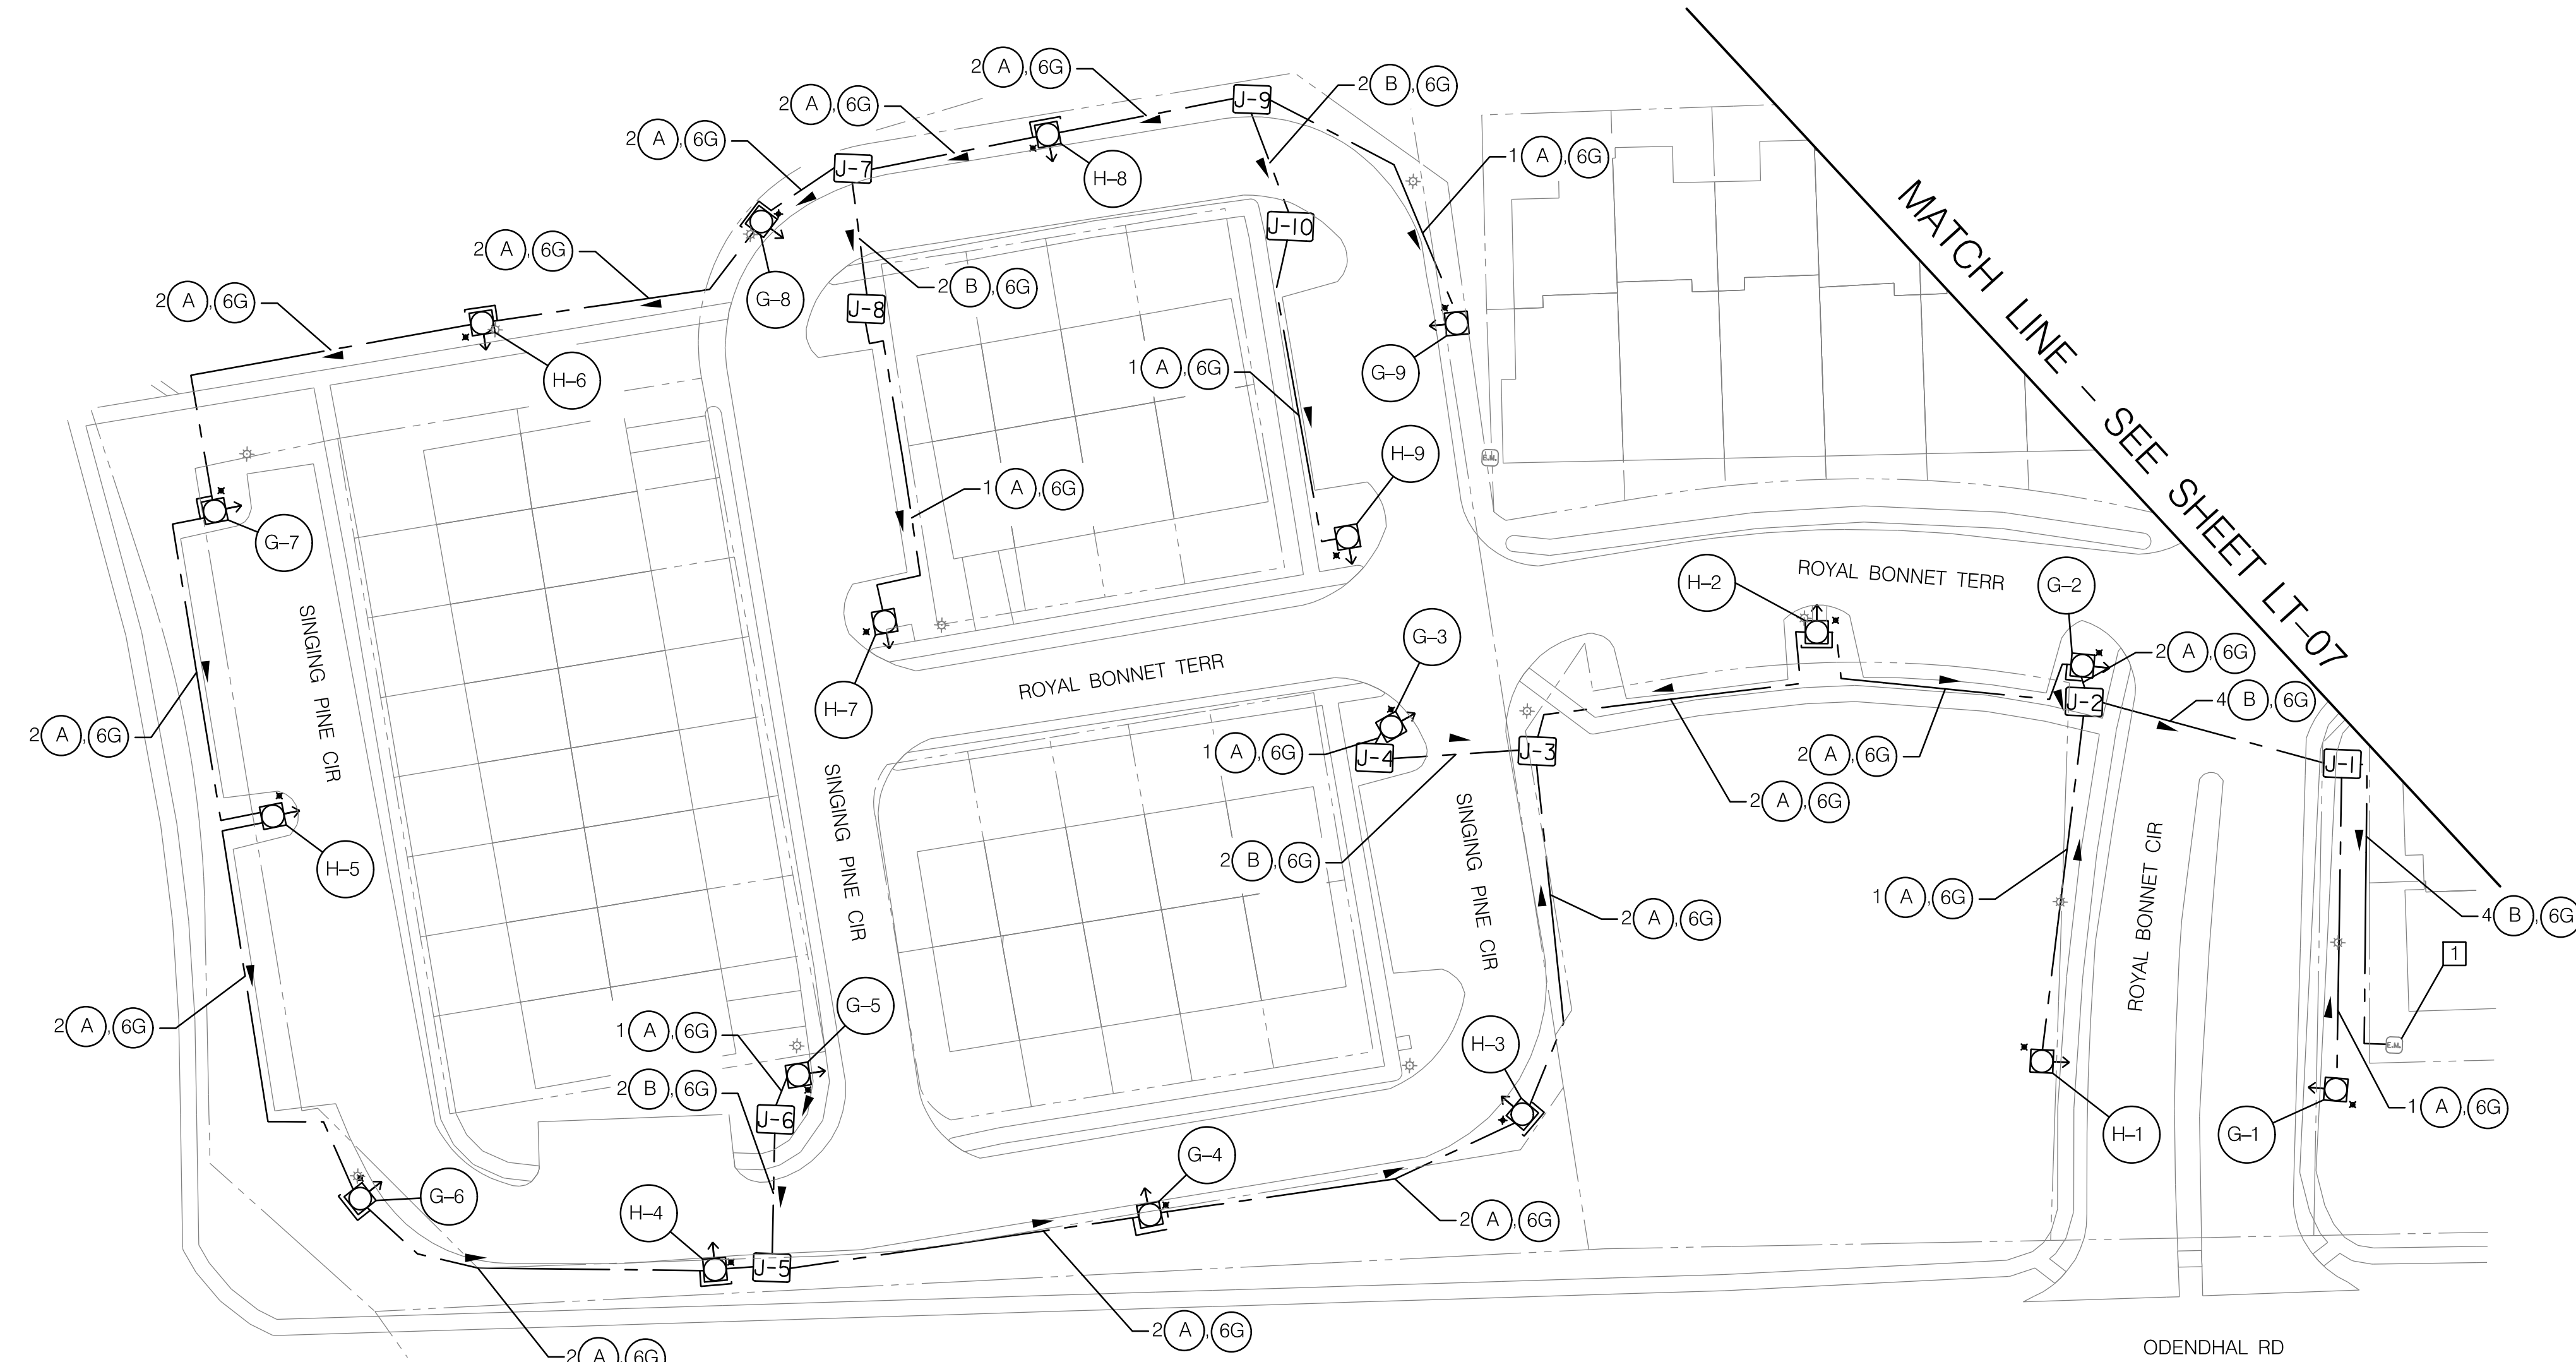

HOUSESIDE SHIELD TABLE	
EQUIPMENT	TYPE
G-9	GVDHSS180

KEY NOTES:
1 EXISTING ELECTRICAL SERVICE PANEL WITH PHOTOCELL FOR "G" AND "H" CIRCUITS. INSTALL NEW CIRCUIT BREAKERS.

(A)	832001, DUCT CABLE - 2 CONDUCTOR, NO. 6 AWG 600V
(B)	832016 CABLE - 1 CONDUCTOR NO. 6 AWG, TYPE USE
(6G)	832020, BARE COPPER WIRE, NO. 6 AWG



LEGEND:

	PROPOSED LIGHT POLE AND LUMINAIRE
	INDICATOR FOR DIRECTION OF LIGHT
	GROUNDING ROD
	CABLE RUN
	EX. ELECTRIC METER
	JUNCTION BOX

EQUIPMENT SCHEDULE			
CATEGORY CODE	DESCRIPTION	UNIT	QUANTITY
801003	CONCRETE FOR LIGHT FOUNDATION	CY	23.4
832020	BARE COPPER WIRE, NO. 6 AWG	LF	3350
806025	LED ROADWAY LUMINAIRE	EA	18
800000	12 FOOT DECORATIVE POLE	EA	18
832001	DUCT CABLE - 2 CONDUCTOR, NO. 6 AWG 600V	LF	2800
832016	CABLE - CONDUCTOR, NO. 6 AWG 600V	LF	820
837001	GROUND ROD = 3/4 INCH DIAMETER 10 FOOT LENGTH	EA	18
834001	CONNECTOR KIT - TYPE I	EA	20
834002	CONNECTOR KIT - TYPE II	EA	14
834003	CONNECTOR KIT - TYPE III	EA	22
834004	CONNECTOR KIT - TYPE IV	EA	12
811001	JUNCTION BOX	EA	10
805125	2 INCH SCHEDULE 80 RIGID PVC CONDUIT	LF	270
807301	20 AMP DISCONNECT SWITCH, SINGLE PHASE	EA	2

- NOTES:
- MIX 3 CONCRETE COMPENSATION INCLUDES ALL CONCRETE, EXCAVATION, REINFORCEMENT STEEL, ANCHOR BOLTS, BACKFILL, MATERIAL, LABOR EQUIPMENT AND TOOLS TO COMPLETE THE WORK.
 - CABLE AND GROUND WIRE COMPENSATION INCLUDES ALL EXCAVATION, BACKFILL, MATERIAL, LABOR EQUIPMENT AND TOOLS TO COMPLETE THE WORK.
 - JUNCTION BOX INCLUDES ALL EXCAVATION, BACKFILL, MATERIAL, LABOR EQUIPMENT AND TOOLS TO COMPLETE THE WORK. JUNCTION BOX INSTALLATION TO BE FLUSH WITH EXISTING GRADE.
 - CABLE FROM CABINET TO JUNCTION BOX SHALL BE INSTALLED IN EXISTING CONDUIT. CONDUIT SHALL BE RE-ROUTED TO THE PROPOSED JUNCTION BOX. IF RE-ROUTING IS NOT FEASIBLE, CONTRACTOR TO PROVIDE NEW 2" SCHEDULE 80 PVC CONDUIT.
 - CABLE BENEATH ROADWAY TO BE INSTALLED IN 2" SCHEDULE 80 PVC CONDUIT.

GENERAL NOTES:
1. SEE GENERAL NOTES ON SHEET LT-01

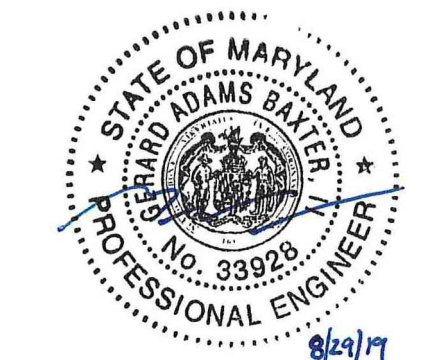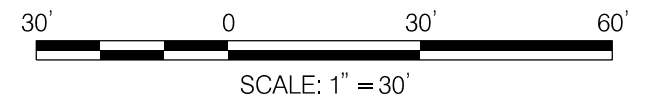

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GERARD ADAMS BAXTER, II, PE


MONTGOMERY COUNTY
DEPARTMENT OF HOUSING AND COMMUNITY AFFAIRS
MONTGOMERY VILLAGE /SOUTH VILLAGE HOMES
LIGHTING AND SITE IMPROVEMENTS PROJECT

LIGHTING PLAN - THE HAMPTONS


SCALE: 30 SCALE, ADVERTISED DATE: N/A CONTRACT NO. _____

DESIGNED BY: AHB COUNTY: MONTGOMERY COUNTY
DRAWN BY: AHB LOGMILE: _____
CHECKED BY: GAB
DPS PERMIT: _____

DRAWING NO. **LT-06** OF **10** SHEET NO. 27 OF 46

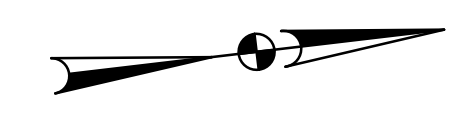

MATCH LINE - SEE SHEET LT-06

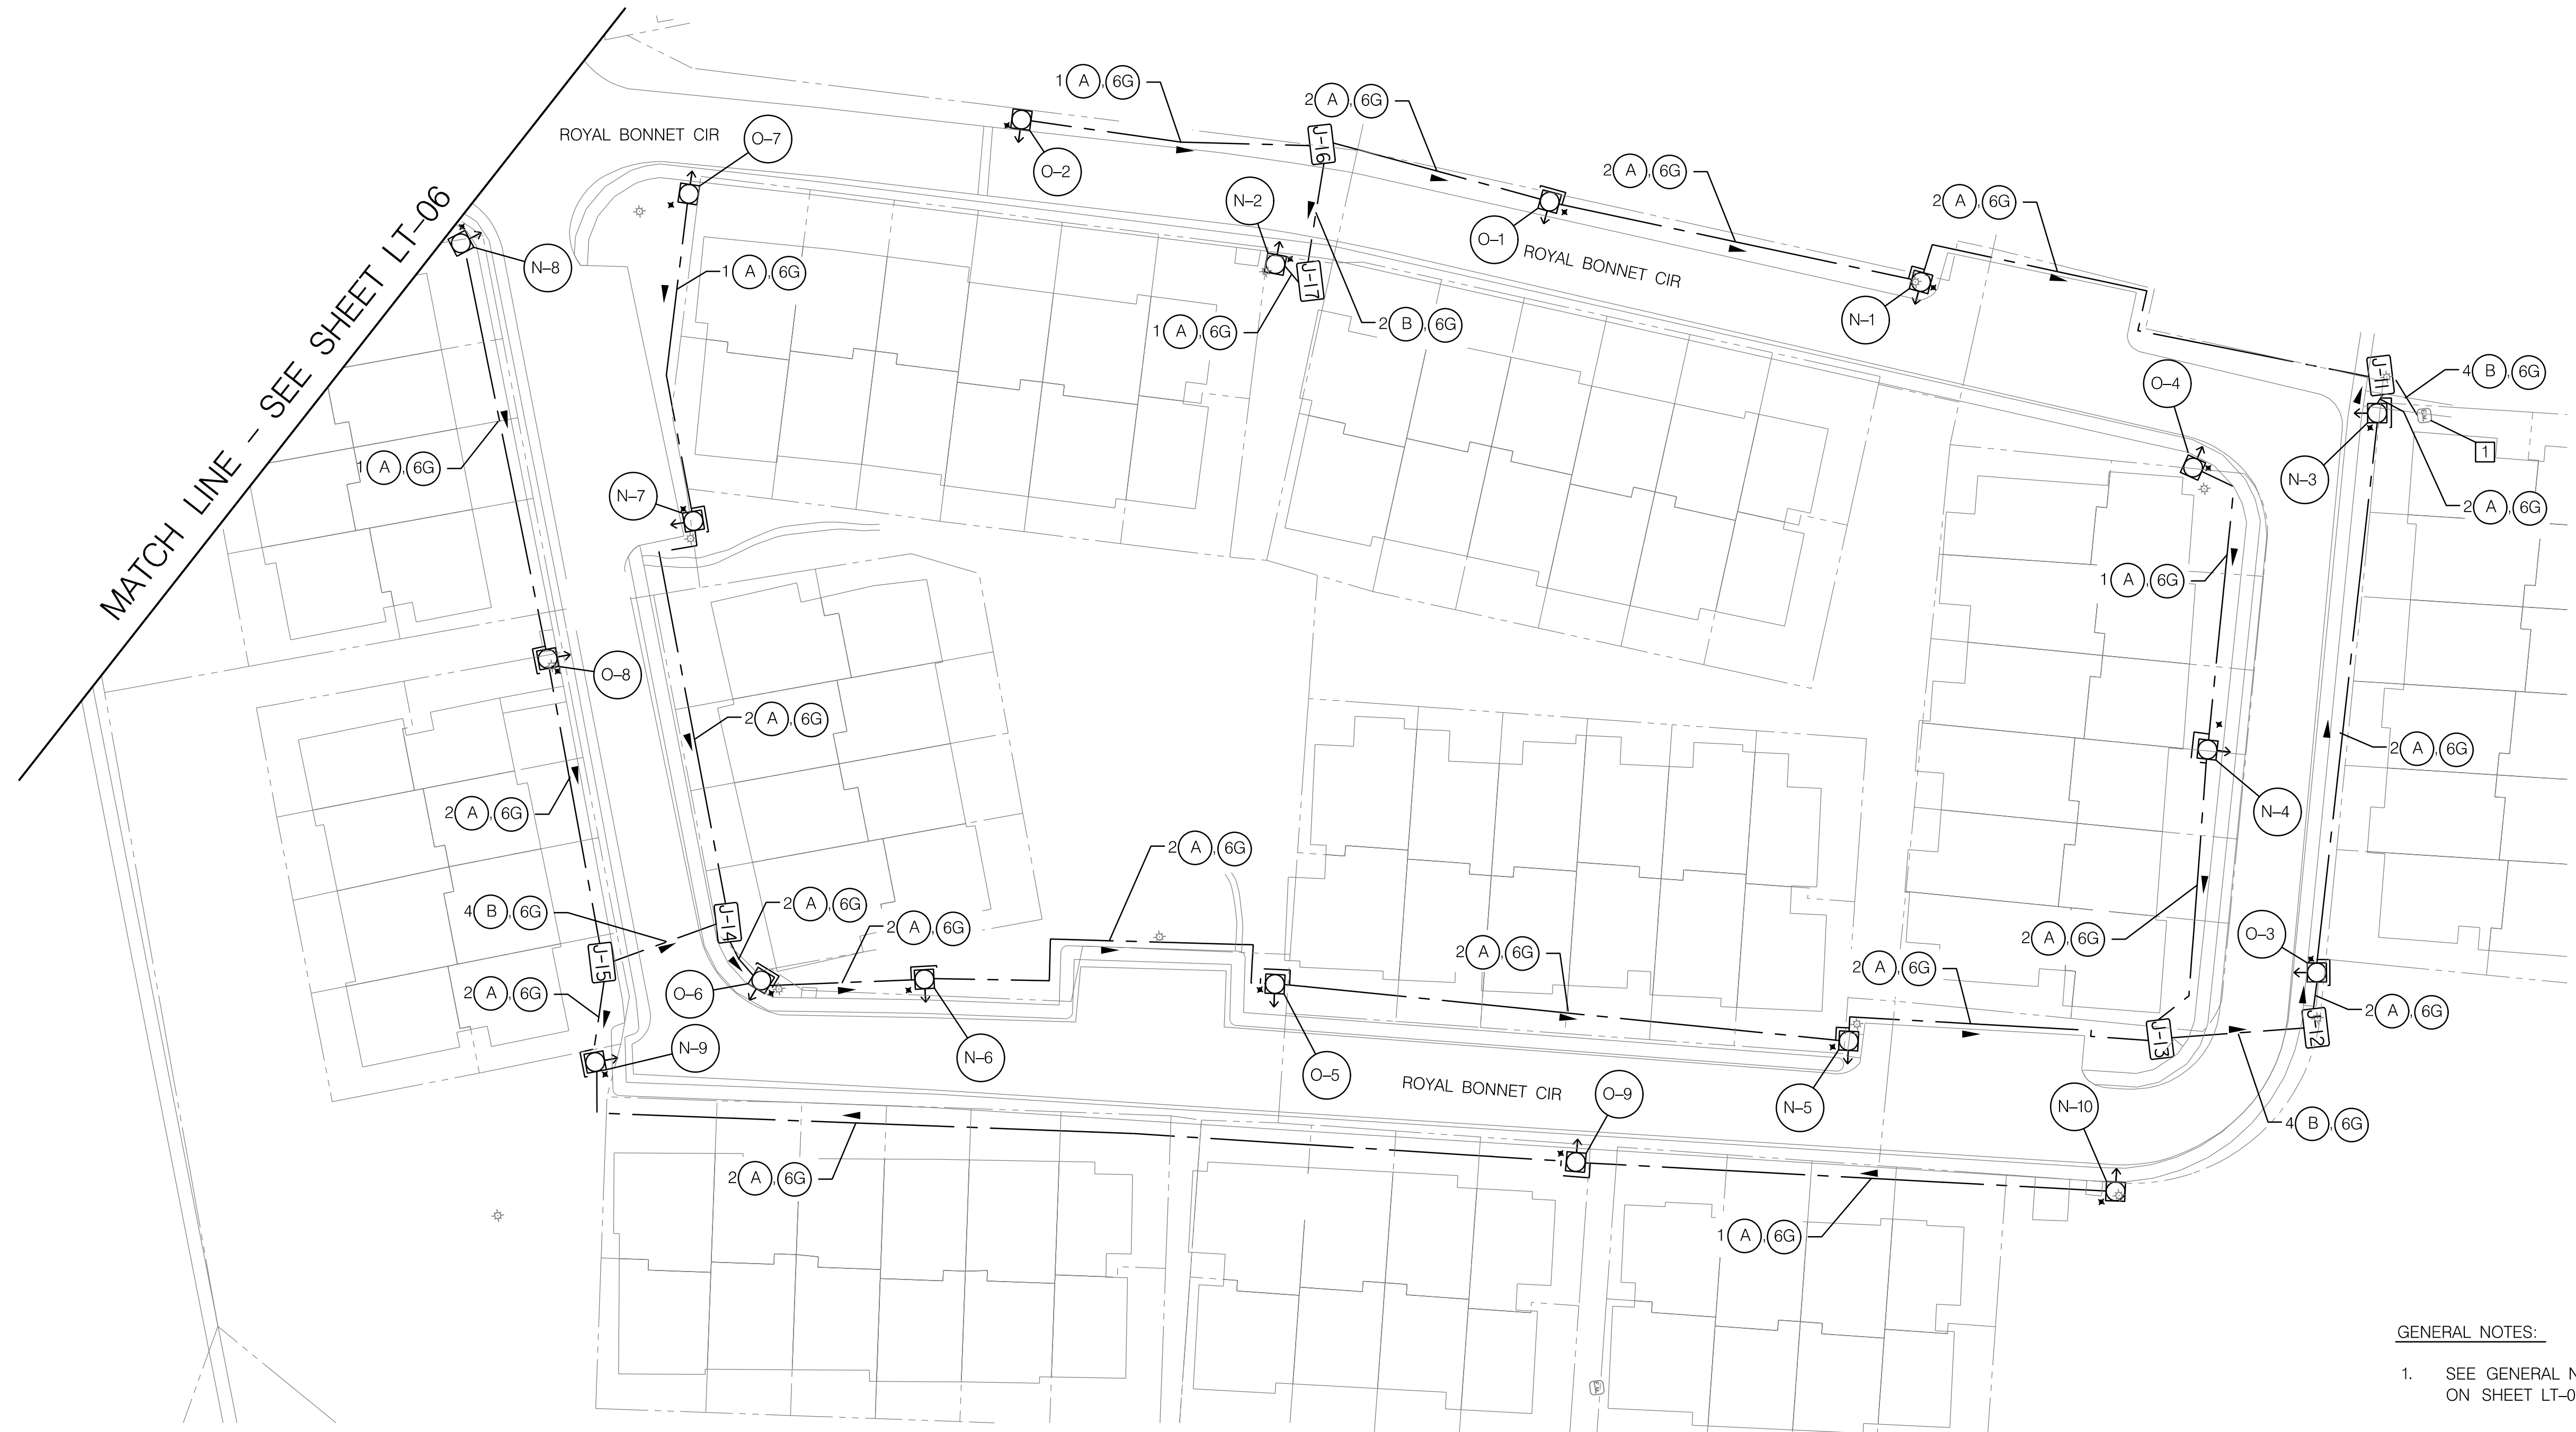

HOUSESIDE SHIELD TABLE	
EQUIPMENT	TYPE
N-4	GVDHSS180

CONNECTOR KIT SCHEDULE				
STRUCTURE	TYPE I KIT	TYPE II KIT	TYPE III KIT	TYPE IV KIT
J-11	0	0	0	4
J-12	4	0	0	0
J-13	0	0	0	4
J-14	0	0	0	4
J-15	0	0	0	4
J-16	4	0	0	0
J-17	2	0	0	0
N-1	0	0	2	0
N-2	0	2	0	0
N-3	0	0	2	0
N-4	0	2	0	0
N-5	0	0	2	0
N-6	0	0	2	0
N-7	0	2	0	0
N-8	0	2	0	0
N-9	0	0	2	0
N-10	0	2	0	0
O-1	0	0	2	0
O-2	0	2	0	0
O-3	0	0	2	0
O-4	0	2	0	0
O-5	0	0	2	0
O-6	0	0	2	0
O-7	0	2	0	0
O-8	0	2	0	0
O-9	0	2	0	0

KEY NOTES:

- 1. EXISTING ELECTRICAL SERVICE PANEL WITH PHOTOCELL FOR "N" AND "O" CIRCUITS. INSTALL NEW CIRCUIT BREAKERS.

(A)	832001, DUCT CABLE - 2 CONDUCTOR, NO. 6 AWG 600V
(B)	832016 CABLE - 1 CONDUCTOR NO. 6 AWG, TYPE USE
(6G)	832020, BARE COPPER WIRE, NO. 6 AWG

GENERAL NOTES:


- 1. SEE GENERAL NOTES ON SHEET LT-01

EXISTING METERED SERVICE PANEL SCHEDULE - 18121 ROYAL BONNET CIRCLE							
CIRCUIT NUMBER	CONDUCTOR SIZE	EQUIPMENT SERVED	CONNECTED LOADS		NUMBER OF LOADS		REMARKS
			KW	AMPS	NO. OF POLES	TRIP SIZE	
1, 3	NO. 6 AWG	PEDESTRIAN LIGHTING: N-1 - N-10	0.390	1.80	2	20	(10) - 39 W LED LUMINAIRES
2, 4	NO. 6 AWG	PEDESTRIAN LIGHTING: O-1 - O-9	0.351	1.62	2	20	(9) - 39 W LED LUMINAIRES
5-16		EXISTING AND SPARES					

NOTES:

- MIX 3 CONCRETE COMPENSATION INCLUDES ALL CONCRETE, EXCAVATION, REINFORCEMENT STEEL, ANCHOR BOLTS, BACKFILL, MATERIAL, LABOR EQUIPMENT AND TOOLS TO COMPLETE THE WORK.
- CABLE AND GROUND WIRE COMPENSATION INCLUDES ALL EXCAVATION, BACKFILL, MATERIAL, LABOR EQUIPMENT AND TOOLS TO COMPLETE THE WORK.
- JUNCTION BOX INCLUDES ALL EXCAVATION, BACKFILL, MATERIAL, LABOR EQUIPMENT AND TOOLS TO COMPLETE THE WORK. JUNCTION BOX INSTALLATION TO BE FLUSH WITH EXISTING GRADE.
- CABLE FROM CABINET TO JUNCTION BOX SHALL BE INSTALLED IN EXISTING CONDUIT. CONDUIT SHALL BE RE-ROUTED TO THE PROPOSED JUNCTION BOX. IF RE-ROUTING IS NOT FEASIBLE, CONTRACTOR TO PROVIDE NEW 2" SCHEDULE 80 PVC CONDUIT.
- CABLE BENEATH ROADWAY TO BE INSTALLED IN 2" SCHEDULE 80 PVC CONDUIT.

NOTE:
UNABLE TO VERIFY CIRCUIT NUMBERS. SPARES AVAILABLE PER ELECTRICAL REPORT.

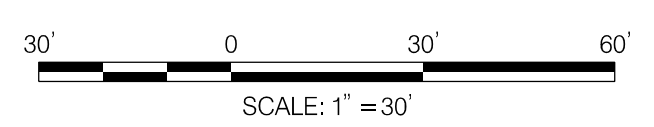

EQUIPMENT SCHEDULE			
CATEGORY CODE	DESCRIPTION	UNIT	QUANTITY
801003	CONCRETE FOR LIGHT FOUNDATION	CY	24.7
832020	BARE COPPER WIRE, NO. 6 AWG	LF	3750
806025	LED ROADWAY LUMINAIRE	EA	19
800000	12 FOOT DECORATIVE POLE	EA	19
832001	DUCT CABLE - 2 CONDUCTOR, NO. 6 AWG 600V	LF	3400
832016	CABLE - CONDUCTOR, NO. 6 AWG 600V	LF	440
837001	GROUND ROD = 3/4 INCH DIAMETER 10 FOOT LENGTH	EA	19
834001	CONNECTOR KIT - TYPE I	EA	10
834002	CONNECTOR KIT - TYPE II	EA	20
834003	CONNECTOR KIT - TYPE III	EA	18
834004	CONNECTOR KIT - TYPE IV	EA	16
811001	JUNCTION BOX	EA	7
805125	2 INCH SCHEDULE 80 RIGID PVC CONDUIT	LF	110
807301	20 AMP DISCONNECT SWITCH, SINGLE PHASE	EA	2



PROFESSIONAL CERTIFICATION

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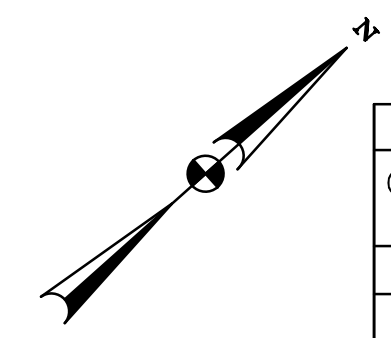
GERARD ADAMS BAXTER, II, PE

MONTGOMERY COUNTY
DEPARTMENT OF HOUSING AND COMMUNITY AFFAIRS
MONTGOMERY VILLAGE / SOUTH VILLAGE HOMES
LIGHTING AND SITE IMPROVEMENTS PROJECT

LIGHTING PLAN - THE HAMPTONS
SCALE: 30 SCALE, ADVERTISED DATE: N/A, CONTRACT NO. _____
DESIGNED BY: AHB COUNTY: MONTGOMERY COUNTY
DRAWN BY: AHB LOGMILE: _____
CHECKED BY: GAB
DPS PERMIT: _____
DRAWING NO. **LT-07** OF **10** SHEET NO. 28 OF 46

BY: abortkewicz





EQUIPMENT SCHEDULE			
CATEGORY CODE	DESCRIPTION	UNIT	QUANTITY
801003	CONCRETE FOR LIGHT FOUNDATION	CY	14.3
832020	BARE COPPER WIRE, NO. 6 AWG	LF	1050
806025	LED ROADWAY LUMINAIRE	EA	11
800000	12 FOOT DECORATIVE POLE	EA	11
832001	DUCT CABLE - 2 CONDUCTOR, NO. 6 AWG 600V	LF	900
832016	CABLE - CONDUCTOR, NO. 6 AWG 600V	LF	80
837001	GROUND ROD = 3/4 INCH DIAMETER 10 FOOT LENGTH	EA	11
834001	CONNECTOR KIT - TYPE I	EA	0
834002	CONNECTOR KIT - TYPE II	EA	8
834003	CONNECTOR KIT - TYPE III	EA	14
834004	CONNECTOR KIT - TYPE IV	EA	6
811001	JUNCTION BOX	EA	2
805125	2 INCH SCHEDULE 80 RIGID PVC CONDUIT	LF	40
807301	20 AMP DISCONNECT SWITCH, SINGLE PHASE	EA	1

- NOTES:**
- MIX 3 CONCRETE COMPENSATION INCLUDES ALL CONCRETE, EXCAVATION, REINFORCEMENT STEEL, ANCHOR BOLTS, BACKFILL, MATERIAL, LABOR EQUIPMENT AND TOOLS TO COMPLETE THE WORK.
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 - CABLE BENEATH ROADWAY TO BE INSTALLED IN 2" SCHEDULE 80 PVC CONDUIT.

- KEY NOTES:**
- [1] EXISTING ELECTRICAL SERVICE PANEL WITH PHOTOCELL FOR "K" CIRCUIT. INSTALL NEW CIRCUIT BREAKER.


HOUSESIDE SHIELD TABLE	
EQUIPMENT	TYPE
K-7, K-9	GVDHSS180

- LEGEND:**
- (A) 832001, DUCT CABLE - 2 CONDUCTOR, NO. 6 AWG 600V
 - (B) 832016 CABLE - 1 CONDUCTOR NO. 6 AWG, TYPE USE
 - (6G) 832020, BARE COPPER WIRE, NO. 6 AWG


- LEGEND:**
- ☐ PROPOSED LIGHT POLE AND LUMINAIRE
 - ↖ INDICATOR FOR DIRECTION OF LIGHT
 - ✱ GROUNDING ROD
 - CABLE RUN
 - ⊖ EX. ELECTRIC METER
 - [J-1] JUNCTION BOX

CONNECTOR KIT SCHEDULE				
STRUCTURE	TYPE I KIT	TYPE II KIT	TYPE III KIT	TYPE IV KIT
J-1	0	0	0	4
J-2	0	0	0	2
K-1	0	2	0	0
K-2	0	2	0	0
K-3	0	2	0	0
K-4	0	0	2	0
K-5	0	0	2	0
K-6	0	0	2	0
K-7	0	0	2	0
K-8	0	0	2	0
K-9	0	0	2	0
K-10	0	0	2	0
K-11	0	2	0	0

EXISTING METERED SERVICE PANEL SCHEDULE - 9966 LAKE LANDING ROAD							
CIRCUIT NUMBER	CONDUCTOR SIZE	EQUIPMENT SERVED	CONNECTED LOADS		NUMBER OF LOADS		REMARKS
			KW	AMPS	NO. OF POLES	TRIP SIZE	
1, 2	NO. 6 AWG	PEDESTRIAN LIGHTING: K-1 - K-12	0.468	2.16	2	70	(12) - 39 W LED LUMINAIRES

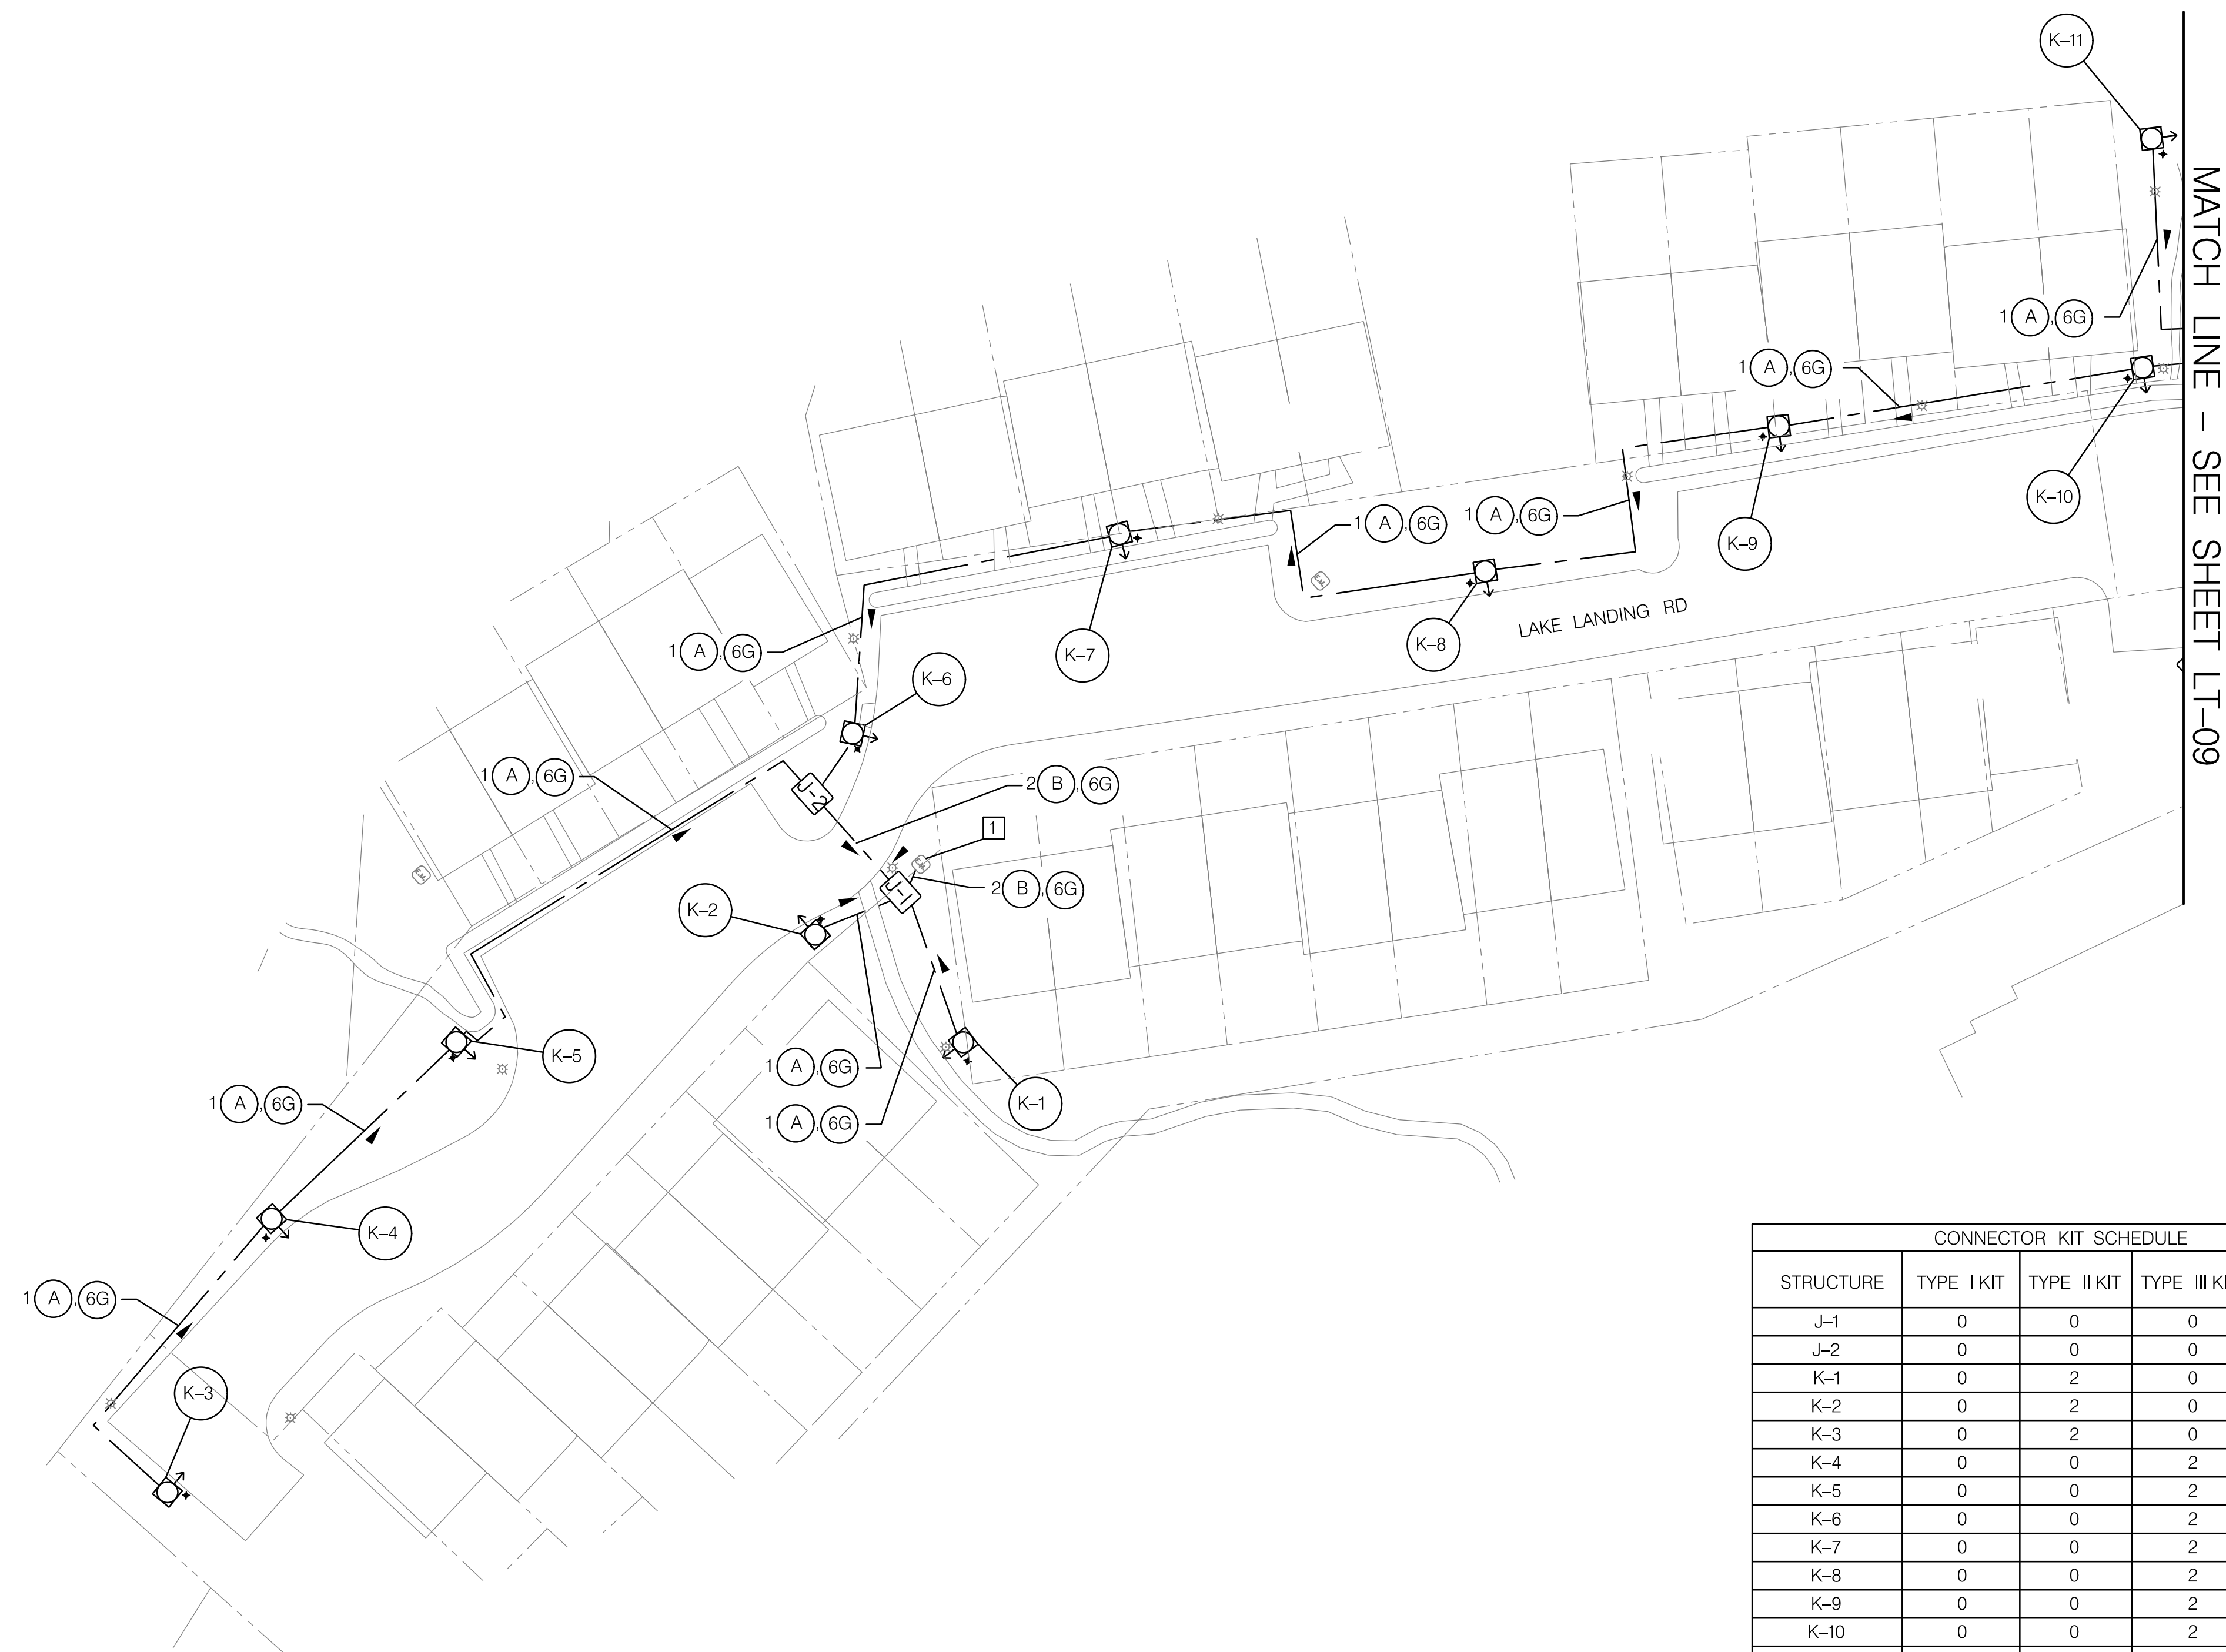

- GENERAL NOTES:**
- SEE GENERAL NOTES ON SHEET LT-01.
 - SEE LIGHTING CONTROL CABINET INFORMATION THIS SHEET AND LT-10.
 - CIRCUIT "K" AND "L" CONTINUES ON TO SHEET LT-09 AND LT-10.

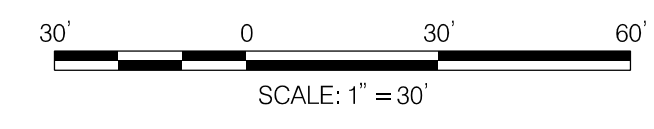


BY: abortkewicz -

PLOTTED: Thursday, August 29, 2019 AT 11:31 AM
 FILE: G:\2019\130707_003_Montgomery_Village_ICADD\PHD-Baseline.dgn

PROFESSIONAL CERTIFICATION

I HEREBY CERTIFY THAT THESE DOCUMENTS WERE PREPARED OR APPROVED BY ME, AND THAT I AM A DULY LICENSED PROFESSIONAL ENGINEER UNDER THE STATE LAWS OF THE STATE OF MARYLAND, LICENSE NO. 33928, EXPIRATION DATE: 01/15/2021.

GERARD ADAMS BAXTER, II, PE

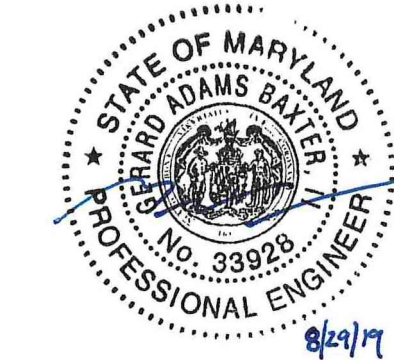

MONTGOMERY COUNTY
 DEPARTMENT OF HOUSING AND COMMUNITY AFFAIRS
 MONTGOMERY VILLAGE /SOUTH VILLAGE HOMES
 LIGHTING AND SITE IMPROVEMENTS PROJECT

LIGHTING PLAN - WALKER'S CHOICE	
SCALE: 30 SCALE	ADVERTISED DATE: N/A CONTRACT NO. _____
DESIGNED BY: AHB	COUNTY: MONTGOMERY COUNTY
DRAWN BY: AHB	LOGMILE: _____
CHECKED BY: GAB	
DPS PERMIT: _____	
DRAWING NO. LT-08 OF 10	SHEET NO. 29 OF 46

EXISTING METERED SERVICE PANEL SCHEDULE - 9921 LAKE LANDING ROAD							
CIRCUIT NUMBER	CONDUCTOR SIZE	EQUIPMENT SERVED	CONNECTED LOADS		NUMBER OF LOADS		REMARKS
			KW	AMPS	NO. OF POLES	TRIP SIZE	
1, 2	NO. 6 AWG	PEDESTRIAN LIGHTING: L-1 - L-10	0.390	1.80	2	20	(10) - 39 W LED LUMINAIRES

- (A) 832001, DUCT CABLE - 2 CONDUCTOR, NO. 6 AWG 600V
- (B) 832016 CABLE - 1 CONDUCTOR NO. 6 AWG, TYPE USE
- (6G) 832020, BARE COPPER WIRE, NO. 6 AWG

HOUSESIDE SHIELD TABLE	
EQUIPMENT	TYPE
L-1, L-4	GVDHSS180

EQUIPMENT SCHEDULE			
CATEGORY CODE	DESCRIPTION	UNIT	QUANTITY
801003	CONCRETE FOR LIGHT FOUNDATION	CY	15.6
832020	BARE COPPER WIRE, NO. 6 AWG	LF	1150
806025	LED ROADWAY LUMINAIRE	EA	12
800000	12 FOOT DECORATIVE POLE	EA	12
832001	DUCT CABLE - 2 CONDUCTOR, NO. 6 AWG 600V	LF	850
832016	CABLE - CONDUCTOR, NO. 6 AWG 600V	LF	290
837001	GROUND ROD = 3/4 INCH DIAMETER 10 FOOT LENGTH	EA	12
834001	CONNECTOR KIT - TYPE I	EA	4
834002	CONNECTOR KIT - TYPE II	EA	8
834003	CONNECTOR KIT - TYPE III	EA	16
834004	CONNECTOR KIT - TYPE IV	EA	4
811001	JUNCTION BOX	EA	4
805125	2 INCH SCHEDULE 80 RIGID PVC CONDUIT	LF	135
807301	20 AMP DISCONNECT SWITCH, SINGLE PHASE	EA	1

MATCH LINE - SEE SHEET LT-08

KEY NOTES:

- 1 EXISTING ELECTRICAL SERVICE PANEL WITH PHOTOCELL FOR "L" CIRCUIT. INSTALL NEW CIRCUIT BREAKER.

CONNECTOR KIT SCHEDULE				
STRUCTURE	TYPE I KIT	TYPE II KIT	TYPE III KIT	TYPE IV KIT
J-3	0	0	0	2
J-4	2	0	0	0
J-5	0	0	0	2
J-6	2	0	0	0
K-12	0	2	0	0
L-1	0	2	0	0
L-2	0	0	2	0
L-3	0	0	2	0
L-4	0	0	2	0
L-5	0	0	2	0
L-6	0	0	2	0
L-7	0	0	2	0
L-8	0	0	2	0
L-9	0	0	2	0
L-10	0	2	0	0
M-9	0	2	0	0

GENERAL NOTES:

- 1. SEE GENERAL NOTES ON SHEET LT-01
- 2. RCUIT "K" AND "M" CONTINUES ON TO SHEET LT-08 AND LT-10.
- 3. CONTRACTOR TO USE EXSTING LIGHTING CONDUIT FOR L-9 AND L-10.

NOTES:

- MIX 3 CONCRETE COMPENSATION INCLUDES ALL CONCRETE, EXCAVATION, REINFORCEMENT STEEL, ANCHOR BOLTS, BACKFILL, MATERIAL, LABOR EQUIPMENT AND TOOLS TO COMPLETE THE WORK.
- CABLE AND GROUND WIRE COMPENSATION INCLUDES ALL EXCAVATION, BACKFILL, MATERIAL, LABOR EQUIPMENT AND TOOLS TO COMPLETE THE WORK.
- JUNCTION BOX INCLUDES ALL EXCAVATION, BACKFILL, MATERIAL, LABOR EQUIPMENT AND TOOLS TO COMPLETE THE WORK. JUNCTION BOX INSTALLATION TO BE FLUSH WITH EXISTING GRADE.
- CABLE FROM CABINET TO JUNCTION BOX SHALL BE INSTALLED IN EXISTING CONDUIT. CONDUIT SHALL BE RE-ROUTED TO THE PROPOSED JUNCTION BOX. IF RE-ROUTING IS NOT FEASIBLE, CONTRACTOR TO PROVIDE NEW 2" SCHEDULE 80 PVC CONDUIT.
- CABLE BENEATH ROADWAY TO BE INSTALLED IN 2" SCHEDULE 80 PVC CONDUIT.

LEGEND:

- PROPOSED LIGHT POLE AND LUMINAIRE
- INDICATOR FOR DIRECTION OF LIGHT
- GROUNDING ROD
- CABLE RUN
- EX. ELECTRIC METER
- JUNCTION BOX



PROFESSIONAL CERTIFICATION

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GERARD ADAMS BAXTER, II, PE


MONTGOMERY COUNTY
DEPARTMENT OF HOUSING AND COMMUNITY AFFAIRS
MONTGOMERY VILLAGE /SOUTH VILLAGE HOMES
LIGHTING AND SITE IMPROVEMENTS PROJECT

LIGHTING PLAN - WALKER'S CHOICE

SCALE: 30 SCALE, ADVERTISED DATE: N/A CONTRACT NO. _____

DESIGNED BY: AHB COUNTY: MONTGOMERY COUNTY
DRAWN BY: AHB LOGMILE: _____
CHECKED BY: GAB
DPS PERMIT: _____

DRAWING NO. **LT-09** OF **10** SHEET NO. 30 OF 46

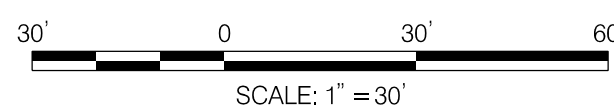

MATCH LINE - SEE SHEET LT-10

BY: aborkiewicz -

EQUIPMENT SCHEDULE			
CATEGORY CODE	DESCRIPTION	UNIT	QUANTITY
801003	CONCRETE FOR LIGHT FOUNDATION	CY	10.4
832020	BARE COPPER WIRE, NO. 6 AWG	LF	900
806025	LED ROADWAY LUMINAIRE	EA	8
800000	12 FOOT DECORATIVE POLE	EA	8
832001	DUCT CABLE - 2 CONDUCTOR, NO. 6 AWG 600V	LF	750
832016	CABLE - CONDUCTOR, NO. 6 AWG 600V	LF	30
837001	GROUND ROD = 3/4 INCH DIAMETER 10 FOOT LENGTH	EA	8
834001	CONNECTOR KIT - TYPE I	EA	0
834002	CONNECTOR KIT - TYPE II	EA	2
834003	CONNECTOR KIT - TYPE III	EA	14
834004	CONNECTOR KIT - TYPE IV	EA	2
811001	JUNCTION BOX	EA	1
805125	2 INCH SCHEDULE 80 RIGID PVC CONDUIT	LF	30
807301	20 AMP DISCONNECT SWITCH, SINGLE PHASE	EA	1


GENERAL NOTES:

- SEE GENERAL NOTES ON SHEET LT-01
- SEE LIGHTING CONTROL CABINET INFORMATION THIS SHEET AND LT-08
- CIRCUIT "K" AND "L" CONTINUES ON TO SHEET LT-08 AND LT-09.

HOUSESIDE SHIELD TABLE	
EQUIPMENT	TYPE
M-1, M-2, M-4, M-5, M-6, M-7	GVDHSS180

CONNECTOR KIT SCHEDULE				
STRUCTURE	TYPE I KIT	TYPE II KIT	TYPE III KIT	TYPE IV KIT
J-7	0	0	0	2
M-1	0	0	2	0
M-2	0	2	0	0
M-3	0	0	2	0
M-4	0	0	2	0
M-5	0	0	2	0
M-6	0	0	2	0
M-7	0	0	2	0
M-8	0	0	2	0

(A)	832001, DUCT CABLE - 2 CONDUCTOR, NO. 6 AWG 600V
(B)	832016 CABLE - 1 CONDUCTOR NO. 6 AWG, TYPE USE
(6G)	832020, BARE COPPER WIRE, NO. 6 AWG

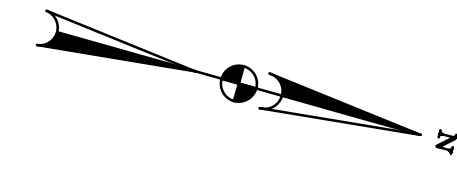

NOTES:

- MIX 3 CONCRETE COMPENSATION INCLUDES ALL CONCRETE, EXCAVATION, REINFORCEMENT STEEL, ANCHOR BOLTS, BACKFILL, MATERIAL, LABOR EQUIPMENT AND TOOLS TO COMPLETE THE WORK.
- CABLE AND GROUND WIRE COMPENSATION INCLUDES ALL EXCAVATION, BACKFILL, MATERIAL, LABOR EQUIPMENT AND TOOLS TO COMPLETE THE WORK.
- JUNCTION BOX INCLUDES ALL EXCAVATION, BACKFILL, MATERIAL, LABOR EQUIPMENT AND TOOLS TO COMPLETE THE WORK. JUNCTION BOX INSTALLATION TO BE FLUSH WITH EXISTING GRADE.
- CABLE FROM CABINET TO JUNCTION BOX SHALL BE INSTALLED IN EXISTING CONDUIT. CONDUIT SHALL BE RE-ROUTED TO THE PROPOSED JUNCTION BOX IF RE-ROUTING IS NOT FEASIBLE, CONTRACTOR TO PROVIDE NEW 2" SCHEDULE 80 PVC CONDUIT.
- CABLE BENEATH ROADWAY TO BE INSTALLED IN 2" SCHEDULE 80 PVC CONDUIT.

KEY NOTES:

- 1 EXISTING ELECTRICAL SERVICE PANEL WITH PHOTOCELL FOR "M" CIRCUIT. INSTALL NEW CIRCUIT BREAKER.

LEGEND:

- PROPOSED LIGHT POLE AND LUMINAIRE
- INDICATOR FOR DIRECTION OF LIGHT
- GROUNDING ROD
- CABLE RUN
- EX. ELECTRIC METER
- JUNCTION BOX



EXISTING METERED SERVICE PANEL SCHEDULE - 18741 WALKERS CHOICE ROAD							
CIRCUIT NUMBER	CONDUCTOR SIZE	EQUIPMENT SERVED	CONNECTED LOADS		NUMBER OF LOADS		REMARKS
			KW	AMPS	NO. OF POLES	TRIP SIZE	
1, 2	NO. 6 AWG	PEDESTRIAN LIGHTING: M-1 - M-9	0.351	1.62	2	70	(9) - 39 W LED LUMINAIRES



PROFESSIONAL CERTIFICATION

I HEREBY CERTIFY THAT THESE DOCUMENTS WERE PREPARED OR APPROVED BY ME, AND THAT I AM A DULY LICENSED PROFESSIONAL ENGINEER UNDER THE STATE LAWS OF THE STATE OF MARYLAND, LICENSE NO. 33923, EXPIRATION DATE: 01/15 /2021.

GERARD ADAMS BAXTER, II, PE

MONTGOMERY COUNTY
DEPARTMENT OF HOUSING AND COMMUNITY AFFAIRS
MONTGOMERY VILLAGE /SOUTH VILLAGE HOMES
LIGHTING AND SITE IMPROVEMENTS PROJECT

LIGHTING PLAN - WALKER'S CHOICE


SCALE: 30 SCALE, ADVERTISED DATE: N/A, CONTRACT NO. _____

DESIGNED BY: AHB COUNTY: MONTGOMERY COUNTY
DRAWN BY: AHB LOGMILE: _____
CHECKED BY: GAB
DPS PERMIT: _____

DRAWING NO. **LT-10** OF **10** SHEET NO. 31 OF 46

BY: aborkiewicz -



NOMINAL MOUNTING HEIGHT FT.	BRACKET ARM LENGTH FT.	ANCHOR BOLT DIMENSIONS (") P" x X" IN. x IN.	FOUNDATION DIMENSIONS		FOUNDATION REINFORCEMENT		CONCRETE REQUIRED C.Y.
			DIAMETER D FT.	HEIGHT H FT.	VERTICAL REINF. BARS SIZE	HORIZONTAL REINF. SIZE	
UP TO 15	0	**	2	4	6 NO. 6		0.5
16-30	0-15	1 x 3/6	2 1/2	7	8 NO. 7		1.3
	20-25	1 x 3/6	2 1/2	11 1/2	8 NO. 7		2.1
35-40	4-20	1 x 3/6	2 1/2	11 1/2	8 NO. 7		2.1
	25-35	1 1/4 x 4/2	3	15	10 NO. 7		4.0
45-50	0-10	1 x 3/6	2 1/2	11 1/2	8 NO. 7		2.1
	15-30	1 1/4 x 4/2	3	15	10 NO. 7		4.0

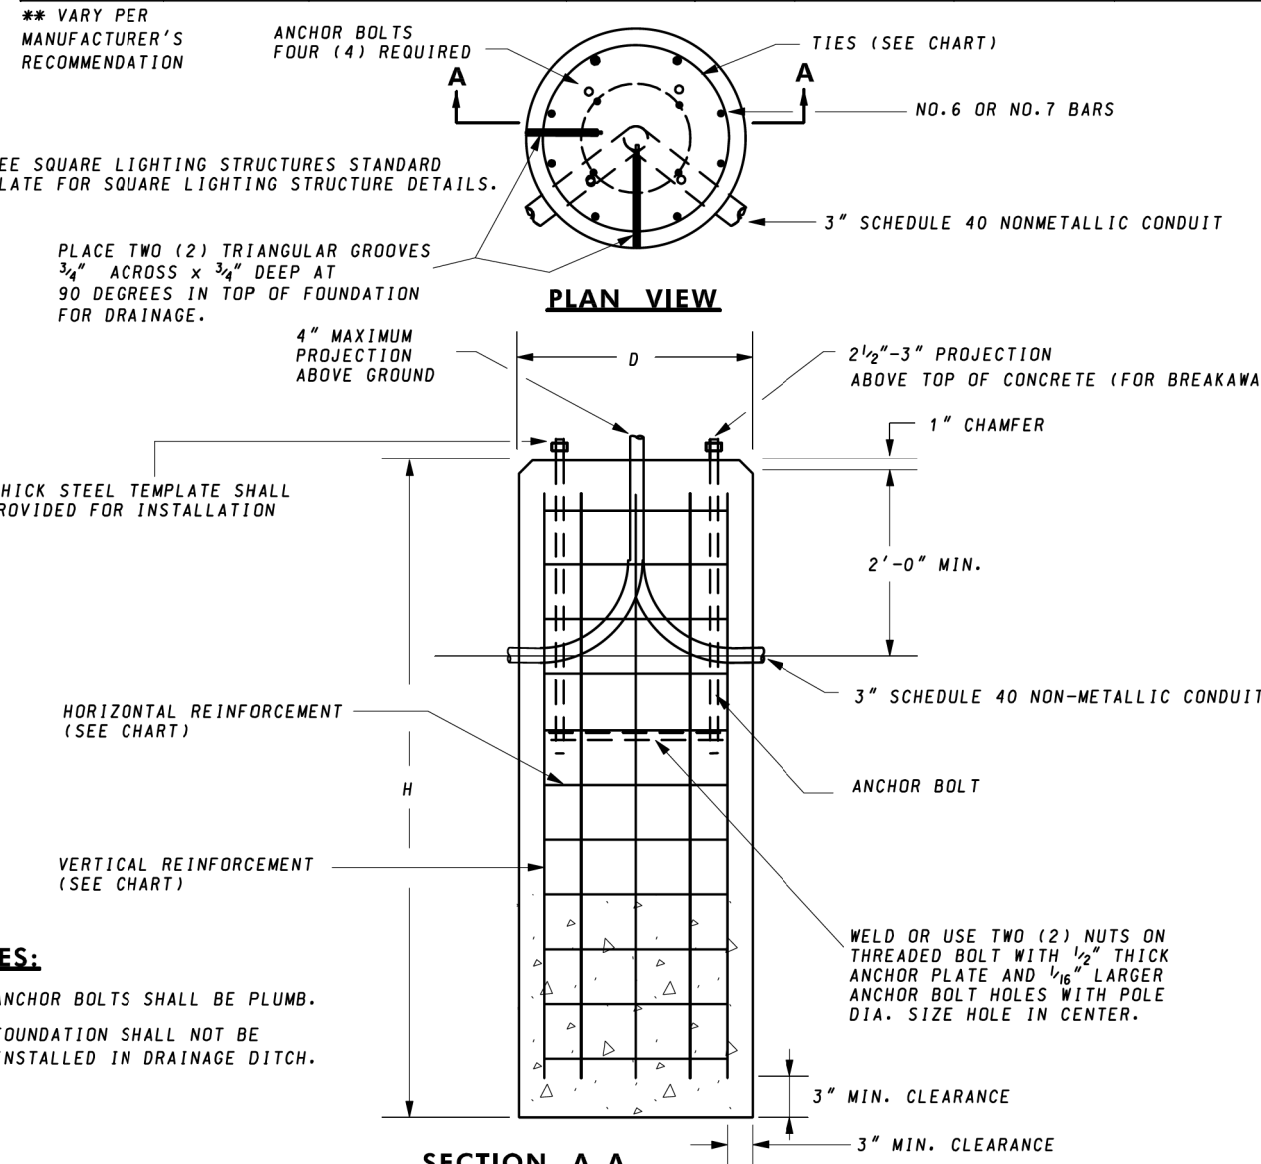


SPECIFICATION	CATEGORY CODE ITEMS	Maryland Department of Transportation STATE HIGHWAY ADMINISTRATION STANDARDS FOR HIGHWAYS AND INCIDENTAL STRUCTURES	
801		LIGHTING STRUCTURE FOUNDATION	
APPROVED	DIRECTOR - OFFICE OF TRAFFIC AND SAFETY	STANDARD NO. MD 801.02	

- STANDARD LIGHTING STRUCTURE FOUNDATION DETAIL
- NOTES FOR 801.02:
- FOUNDATION TO EXTEND 4" ABOVE FINISHED GRADE.
 - FOUNDATION CONCRETE TO BE MIX 3,3000 PSI.
 - GROUND ROD TO BE 3/4" DIA. X 10' LONG COPPER CLAD STEEL ROD.
 - GROUND ROD TO BE EXOTHERMICALLY WELDED TO GROUND WIRE 1' BELOW TOP OF FOUNDATION.
 - GROUND WIRE TO ENTER TOP OF FOUNDATION AND EXIT THE SIDE OF THE FOUNDATION 1' BELOW TOP OF FOUNDATION.

SPECIFICATION	CATEGORY CODE ITEMS	Maryland Department of Transportation STATE HIGHWAY ADMINISTRATION STANDARDS FOR HIGHWAYS AND INCIDENTAL STRUCTURES	
810		240 VOLTS LUMINAIRE OPERATION	
APPROVED	DIRECTOR - OFFICE OF TRAFFIC AND SAFETY	STANDARD NO. MD 810.05	

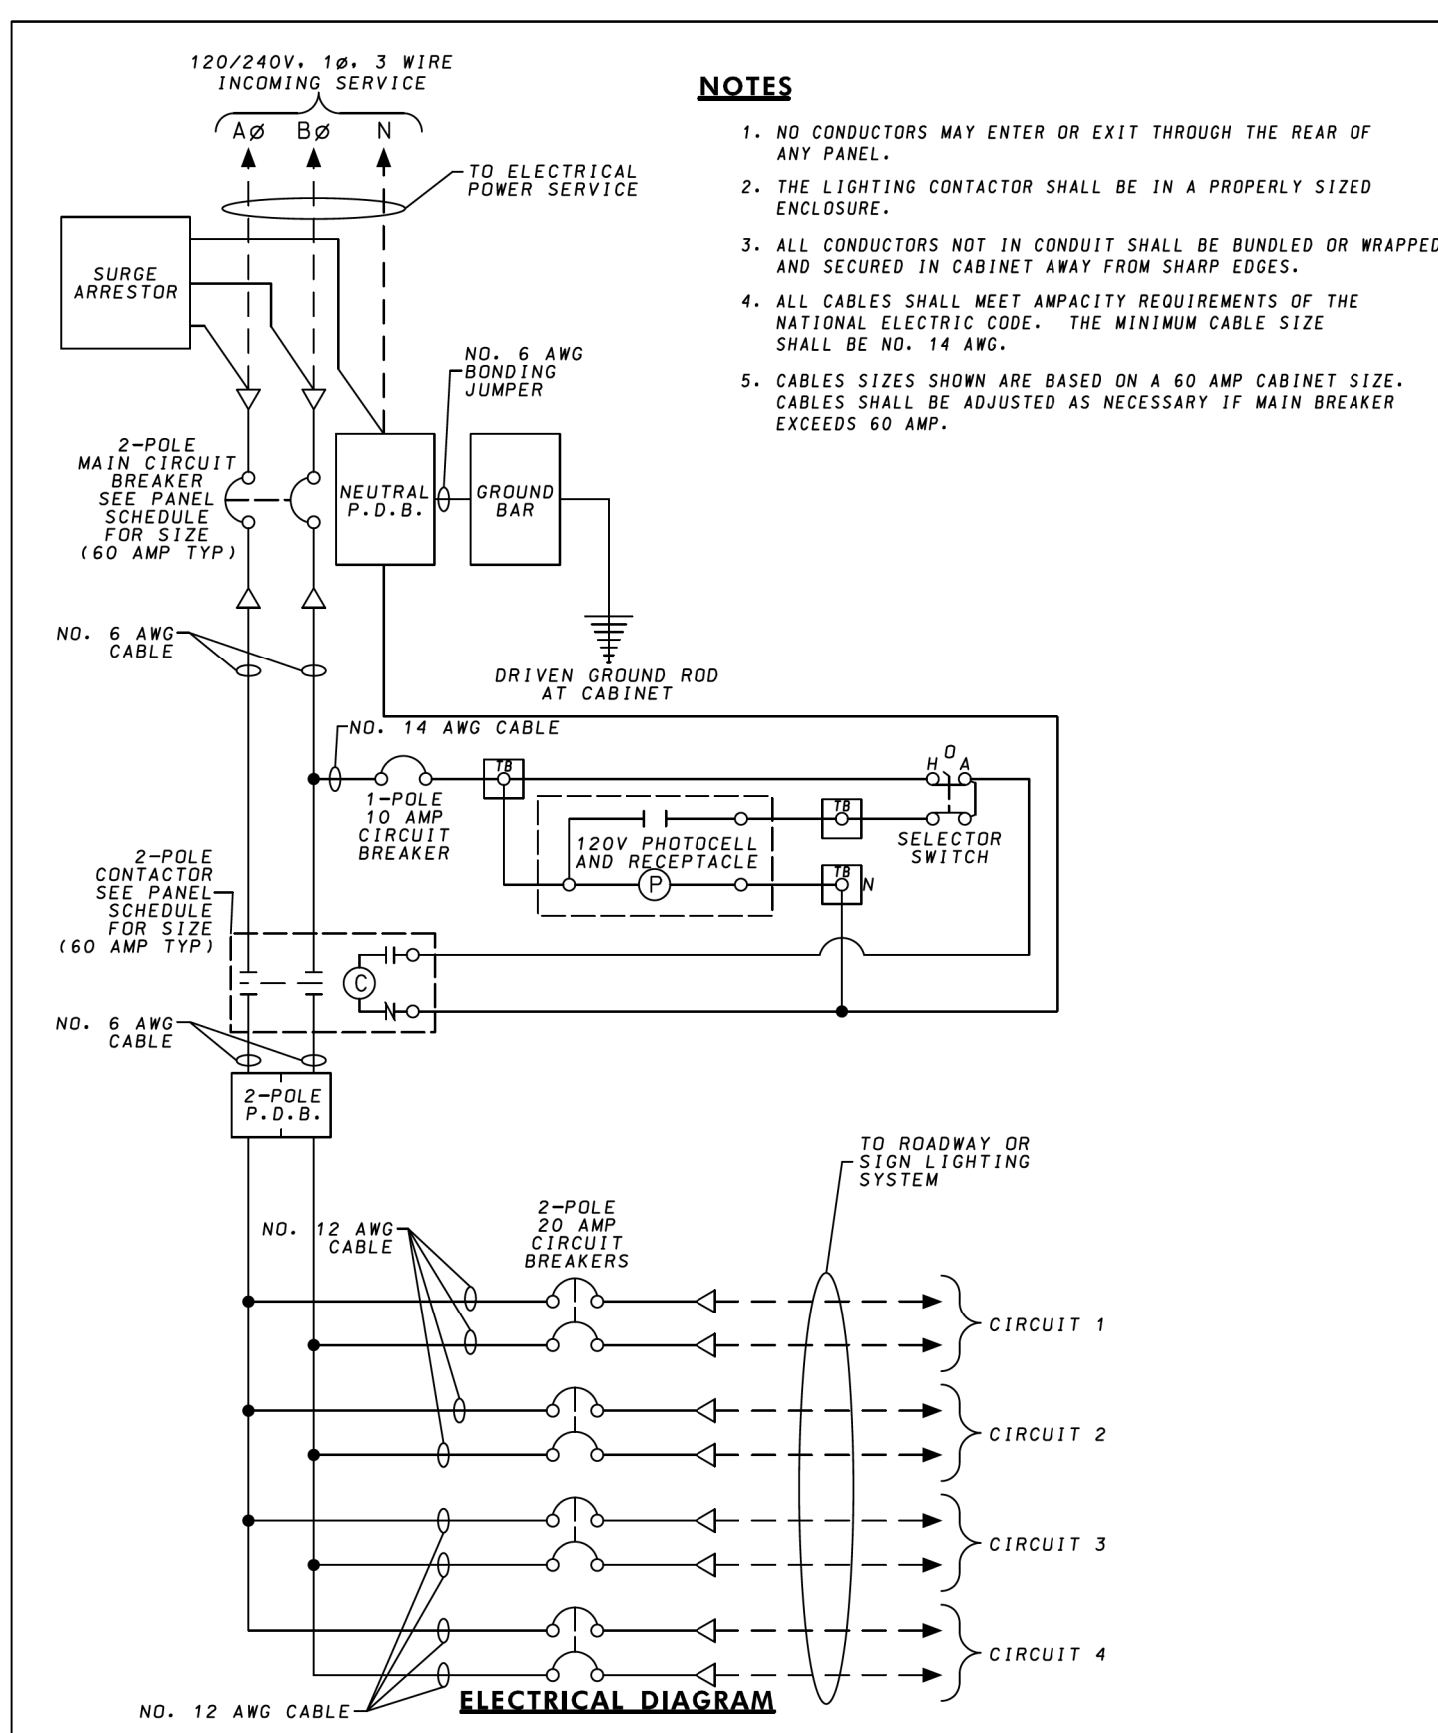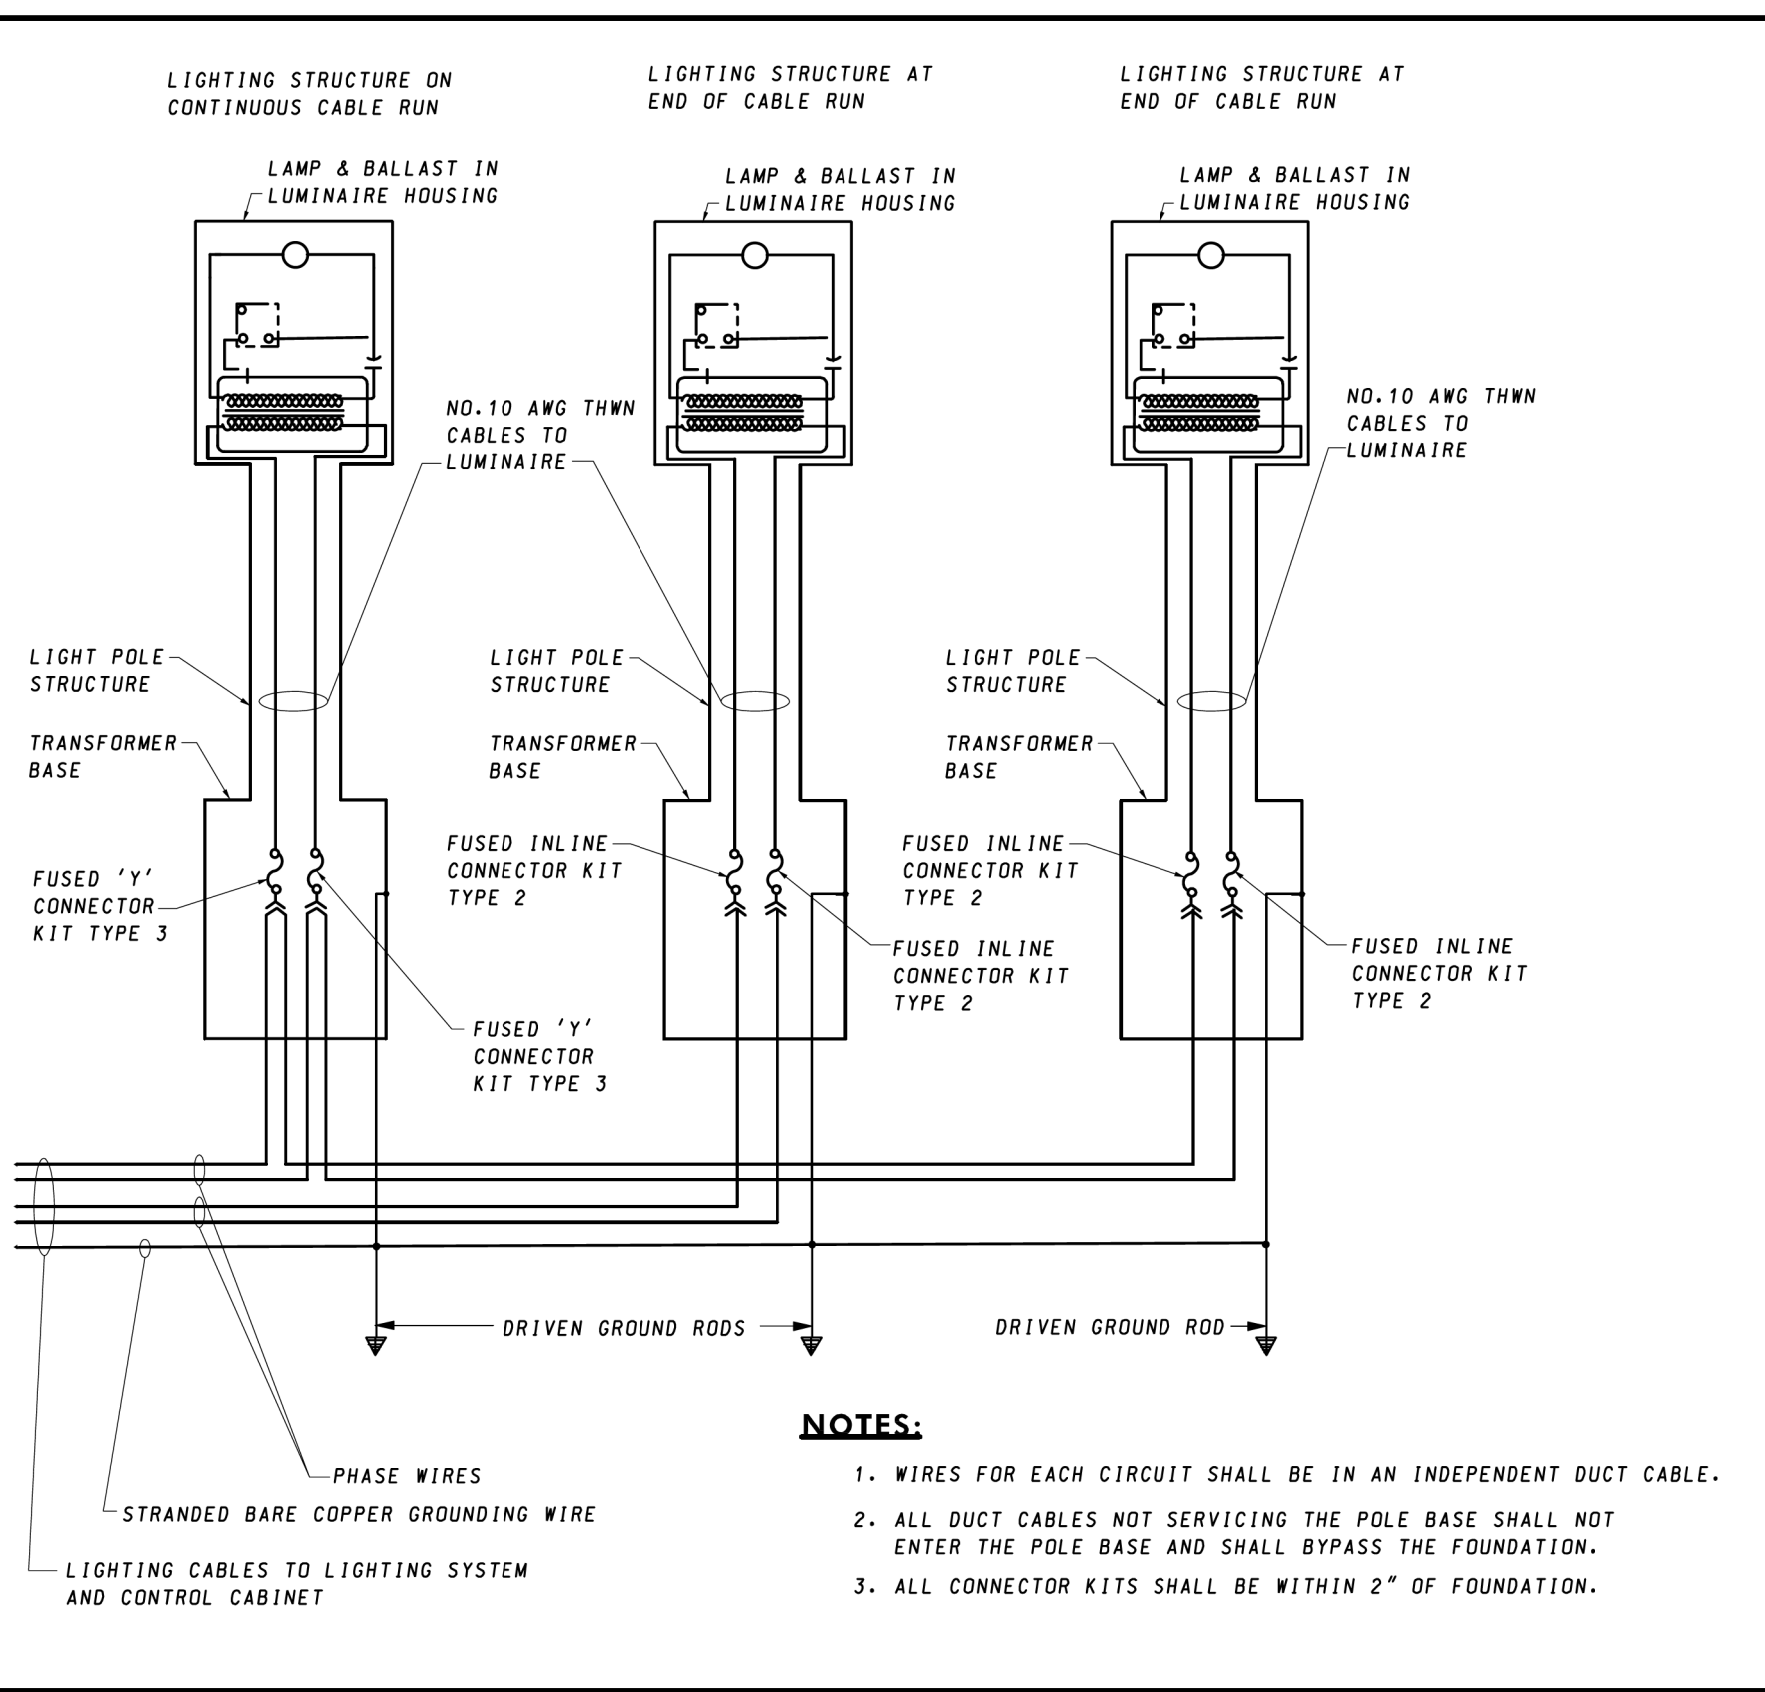

SPECIFICATION	CATEGORY CODE ITEMS	Maryland Department of Transportation STATE HIGHWAY ADMINISTRATION STANDARDS FOR HIGHWAYS AND INCIDENTAL STRUCTURES	
		REMOTE LIGHTING CONTROL CABINET	
		240 VOLTS LUMINAIRE OPERATION	
APPROVED	DIRECTOR - OFFICE OF TRAFFIC AND SAFETY	STANDARD NO. MD 807.05	

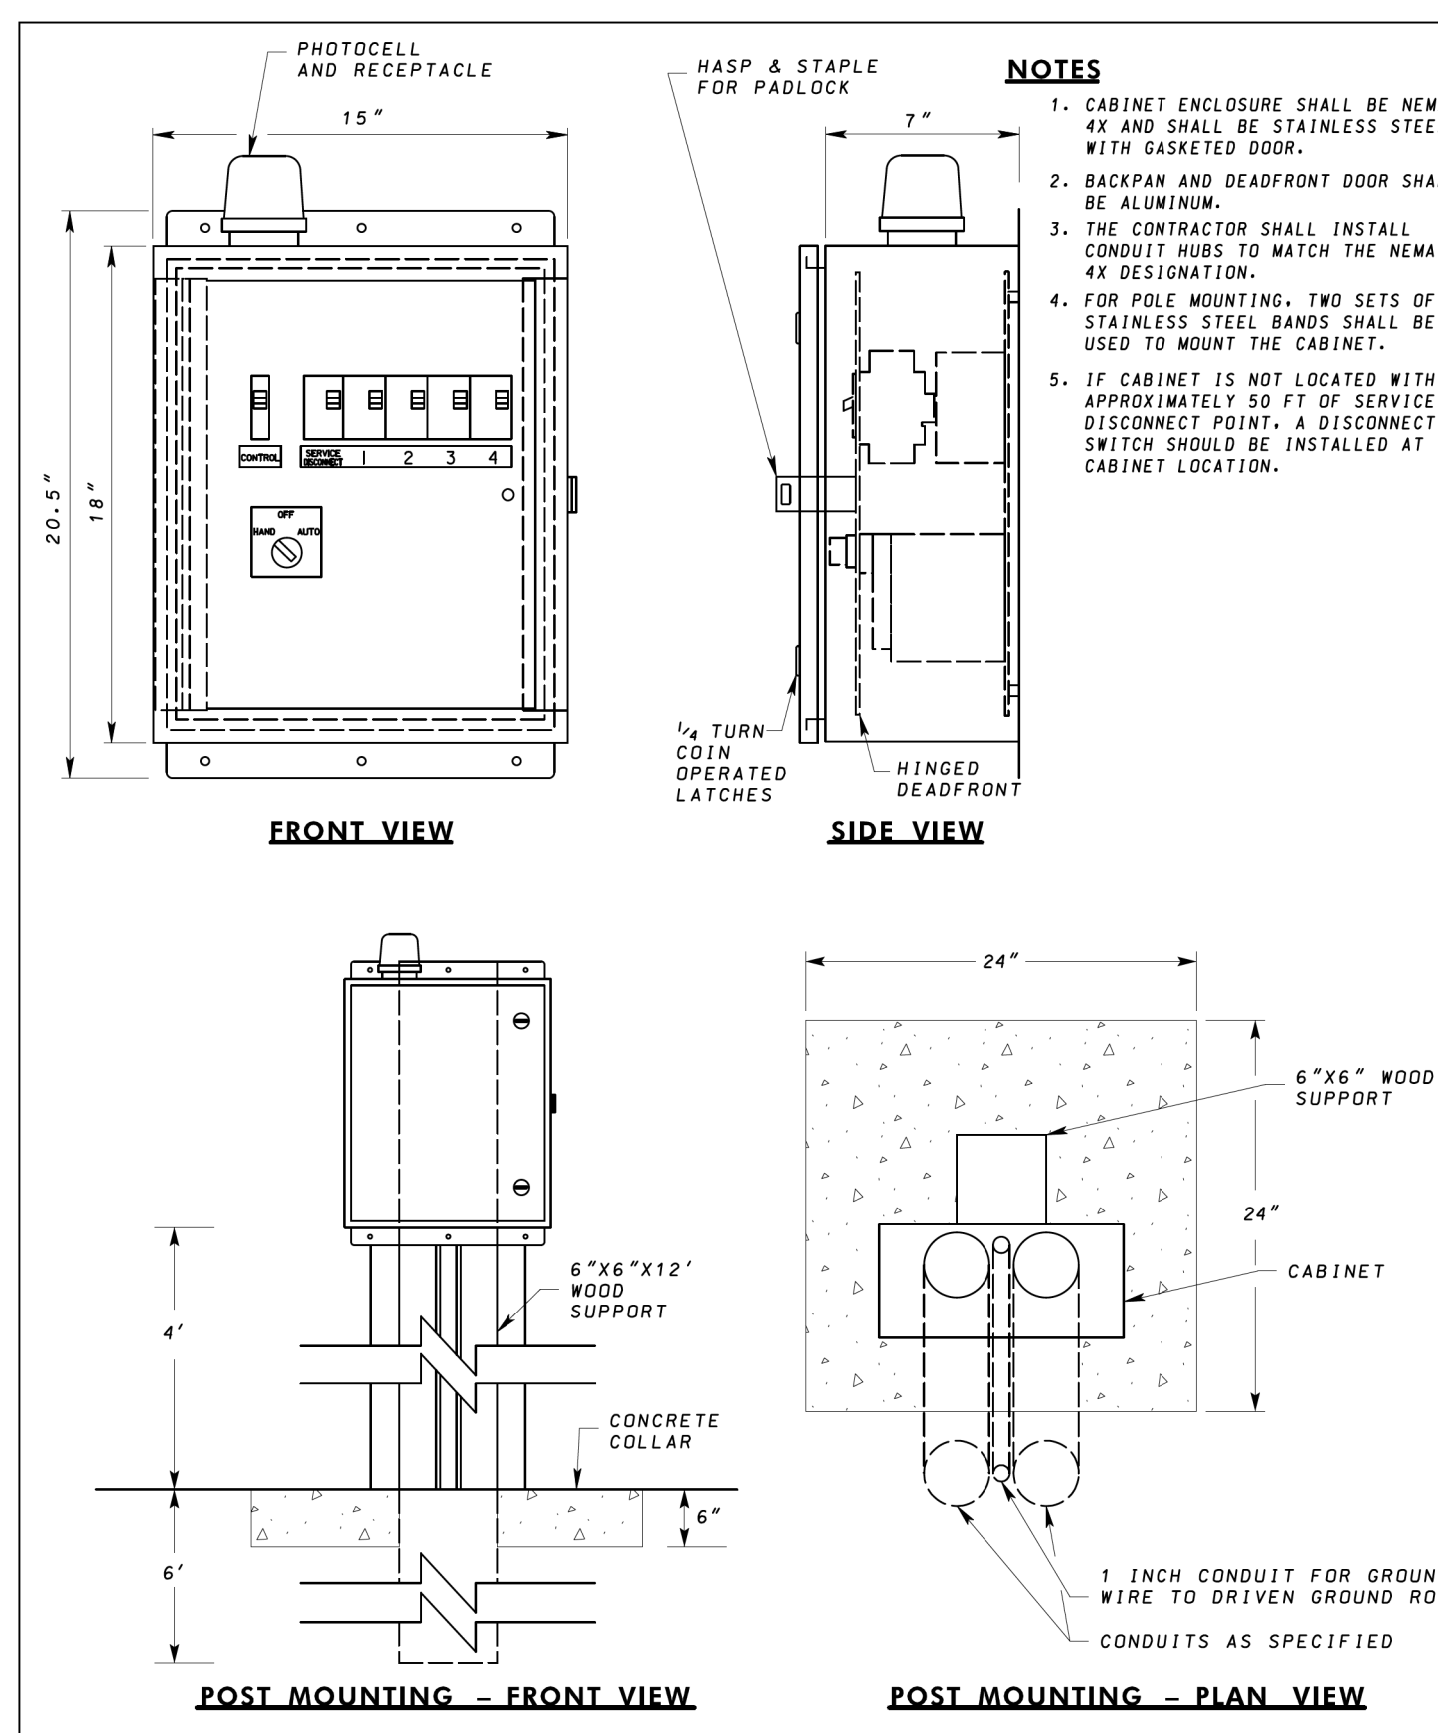


SPECIFICATION	CATEGORY CODE ITEMS	Maryland Department of Transportation STATE HIGHWAY ADMINISTRATION STANDARDS FOR HIGHWAYS AND INCIDENTAL STRUCTURES	
		REMOTE LIGHTING CONTROL CABINET	
APPROVED	DIRECTOR - OFFICE OF TRAFFIC AND SAFETY	STANDARD NO. MD 807.04	

ORDERING INFORMATION:

AWDE2	P20	40K	AS	F	BK	3	F	B	BK
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NOTES ARE LOCATED ON PAGE 3

- NOTES FOR LUMINAIRE:
- LUMINAIRE TO BE WASHINGTON GLOBE STYLE LED LUMINAIRE.

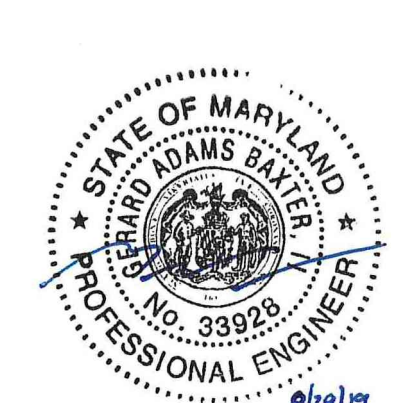

PROFESSIONAL CERTIFICATION

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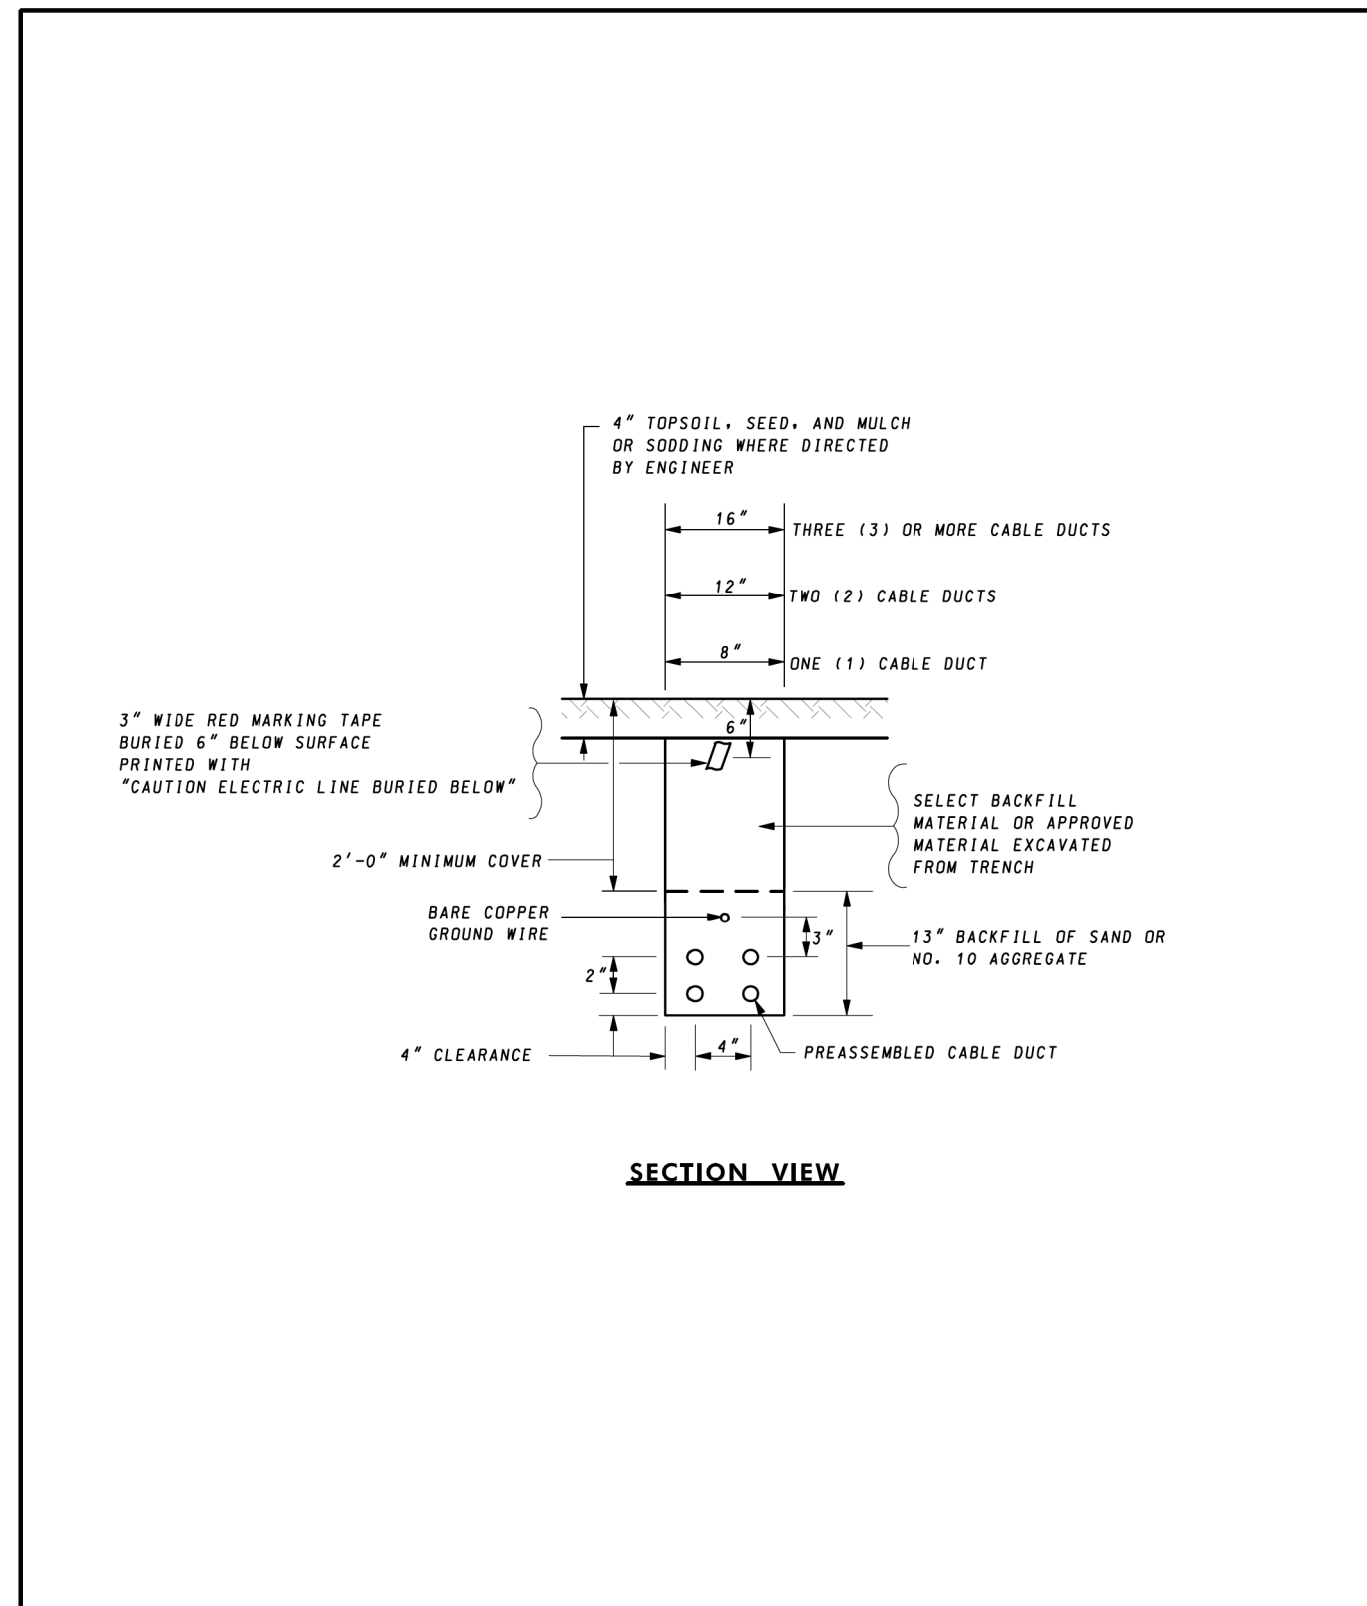
GERARD ADAMS BAXTER, II, PE

MONTGOMERY COUNTY
DEPARTMENT OF HOUSING AND COMMUNITY AFFAIRS


MONTGOMERY VILLAGE /SOUTH VILLAGE HOMES
LIGHTING AND SITE IMPROVEMENTS PROJECT

SCALE NONE		ADVERTISED DATE N/A	CONTRACT NO.
DESIGNED BY	AHB	COUNTY	MONTGOMERY COUNTY
DRAWN BY	AHB	LOGMILE	
CHECKED BY	GAB		
DPS PERMIT			
DRAWING NO.	DE-01	OF	02
SHEET NO. 32		OF 46	





SPECIFICATION	CATEGORY CODE ITEMS	Maryland Department of Transportation STATE HIGHWAY ADMINISTRATION STANDARDS FOR HIGHWAYS AND INCIDENTAL STRUCTURES LIGHTING TRENCHING DETAILS STANDARD NO. MD 809.01
809		
APPROVED	DIRECTOR - OFFICE OF TRAFFIC AND SAFETY	
REVISIONS	REVISIONS	
APPROVAL 7-1-94	APPROVAL 7-1-94	
REVISION 5-17-97	REVISION 5-3-97	
REVISION	REVISION	

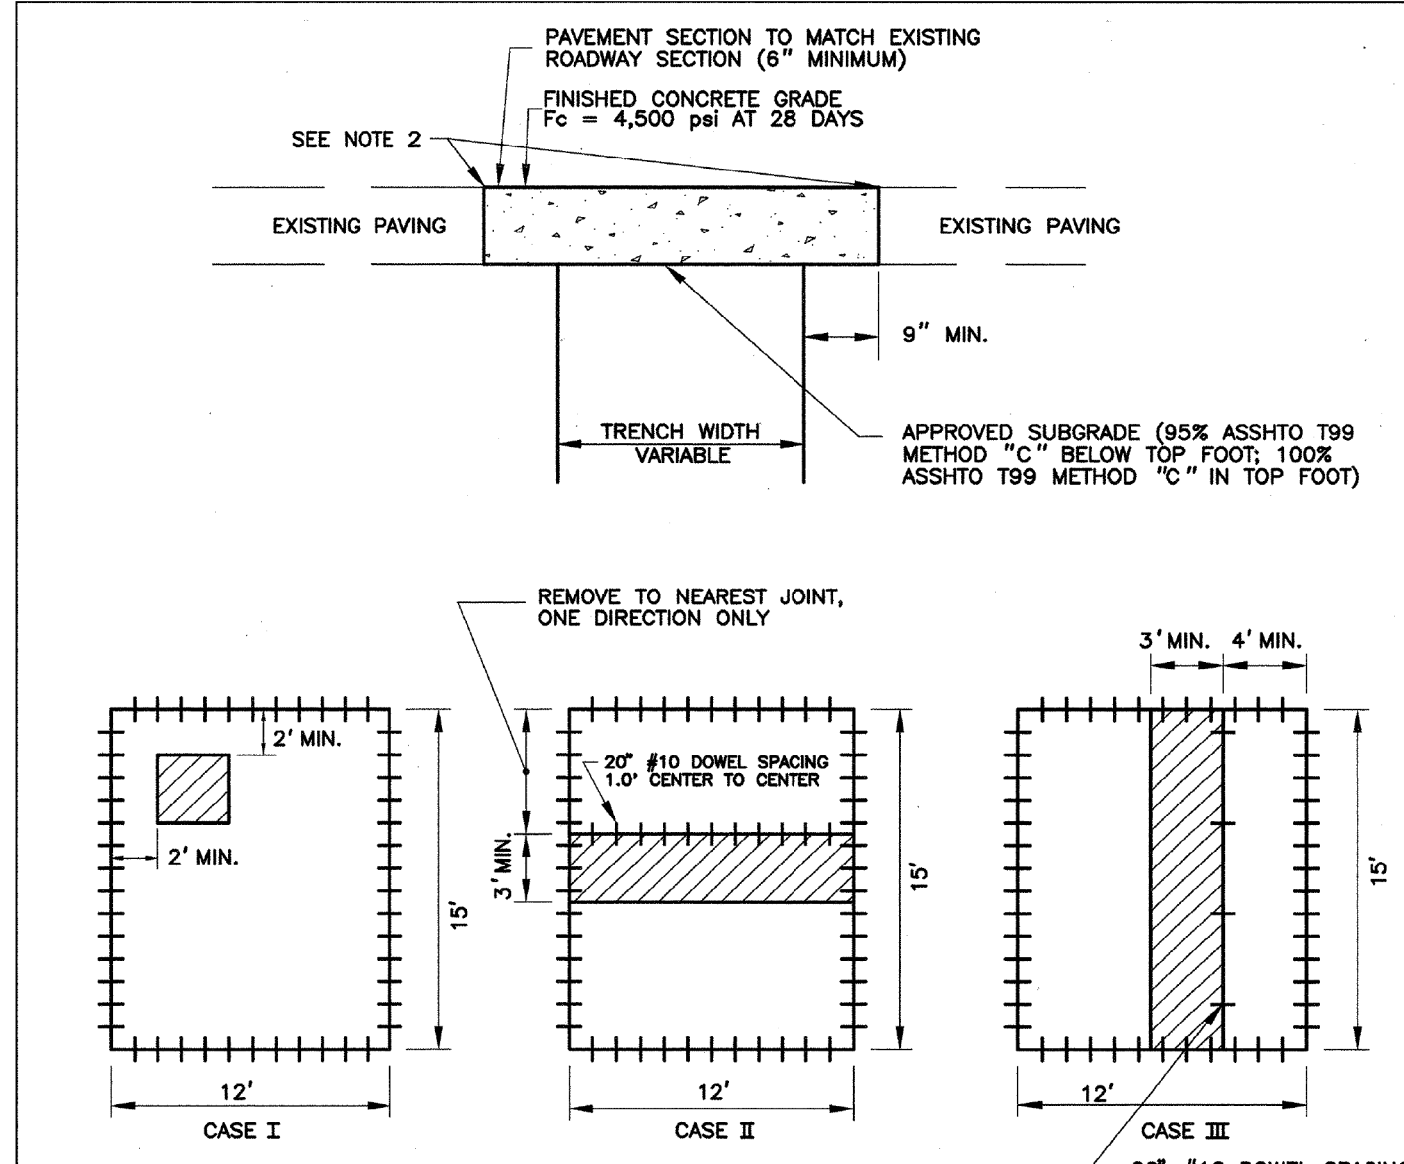

NOTE:
ALL EXISTING TIE DEVICES ARE TO BE UTILIZED, OR REPLACED IF DAMAGED.

GENERAL NOTES


- REFER TO M.C.D.O.T. UTILITY PATCH SPECIFICATIONS FOR MATERIALS AND METHODS OF CONSTRUCTION.
- EXISTING PAVEMENT MUST BE SAW CUT FULL DEPTH PRIOR TO EXCAVATION.
- IF THE CONCRETE ROADWAY IS OVERLAYED WITH BITUMINOUS CONCRETE, A BITUMINOUS CONCRETE SURFACE COURSE SHALL BE PLACED EQUAL IN THICKNESS TO THE EXISTING BITUMINOUS CONCRETE OVERLAY.
- SEE CASES 1, 2, AND 3 FOR JOINT PATTERN.

APPROVED	DATE	REVISED	MONTGOMERY COUNTY DEPARTMENT OF TRANSPORTATION
<i>[Signature]</i>	JAN 5 / 95		UTILITY PATCH IN RIGID PAVEMENT
<i>[Signature]</i>			STANDARD NO. MC-801.01

LIGHTING - GENERAL NOTES

- CENTER OF CABLE TRENCH SHALL BE 3' BEHIND THE CENTER OF LIGHTING STRUCTURES UNLESS OTHERWISE SPECIFIED IN THE CONTRACT DOCUMENTS.
- THE ENGINEER SHALL BE NOTIFIED IMMEDIATELY IN CASE OF DAMAGE TO AN EXISTING FACILITY.
- THE CONTRACTOR SHALL REPLACE ALL CONCRETE GUTTERS, FLUMES, UNDERDRAINS AND OTHER CONCRETE STRUCTURES DAMAGED OR REMOVED DURING THE INSTALLATION OF FOUNDATIONS AND CABLE.
- LIGHTING STRUCTURES SHALL NOT BE PLACED ON THE ROADWAY SIDE OF EXISTING OR PROPOSED TRAFFIC BARRIER W BEAM OR CONCRETE TRAFFIC BARRIER WITHOUT WRITTEN AUTHORIZATION FROM THE ENGINEER.
- ALL CONNECTIONS BETWEEN GROUND RODS AND GROUND CABLE SHALL BE BY ELECTROLYTIC WELD.
- CONDUCTORS SHALL NOT BE SPLICED EXCEPT IN STRUCTURES, MANHOLES AND PULL OR JUNCTION BOXES. ALL MANHOLES, CONDUITS UNDER PAVEMENTS, LIGHTING STRUCTURES, ETC. SHALL BE STAKED OUT AND EVERY LOCATION APPROVED BY THE ENGINEER BEFORE ANY WORK IS DONE.
- ALL DRIVEN CONDUIT SHALL BE PLACED UNDER PAVEMENT BY DIRECTIONAL BORING OR JACKING.
- UPON RECEIVING NOTICE TO PROCEED, THE CONTRACTOR SHALL ARRANGE A MEETING WITH THE LOCAL UTILITY COMPANY, THE PROJECT ENGINEER AND THE TRAFFIC OPERATIONS DIVISION TO INSURE THAT POWER IS AVAILABLE WHEN REQUIRED.
- ALL LIGHTING STRUCTURES NOT PROTECTED BY TRAFFIC BARRIER SHALL BE ON BREAKAWAY BASES.
- ALL TRENCHING MUST BE BACKFILLED AND RESTORED TO ITS ORIGINAL CONDITION ON THE SAME WORKING DAY ON WHICH IT WAS OPENED. AREAS WHICH ARE NOT RESEDED, MULCHED OR SOODED MUST BE COVERED TO PREVENT EROSION. ALL SOIL NOT USED FOR BACKFILL MUST BE REMOVED ON THE SAME WORKING DAY.
- ALL SOIL REMOVED FOR MANHOLES, FOUNDATIONS, ETC. MUST BE COVERED TO PREVENT EROSION. SOIL NOT USED FOR BACKFILL MUST BE DISPOSED OR TO THE ENGINEER'S SATISFACTION ON THE SAME WORKING DAY THE BACKFILL IS COMPLETED.

SPECIFICATION	CATEGORY CODE ITEMS	Maryland Department of Transportation STATE HIGHWAY ADMINISTRATION STANDARDS FOR HIGHWAYS AND INCIDENTAL STRUCTURES LIGHTING GENERAL NOTES STANDARD NO. MD 800.01-05
APPROVED	DIRECTOR - OFFICE OF TRAFFIC AND SAFETY	
APPROVAL - STATE	APPROVAL - FEDERAL	
APPROVAL 7-1-94	APPROVAL 7-1-94	
REVISION 5-17-97	REVISION 5-2-97	
REVISION	REVISION	

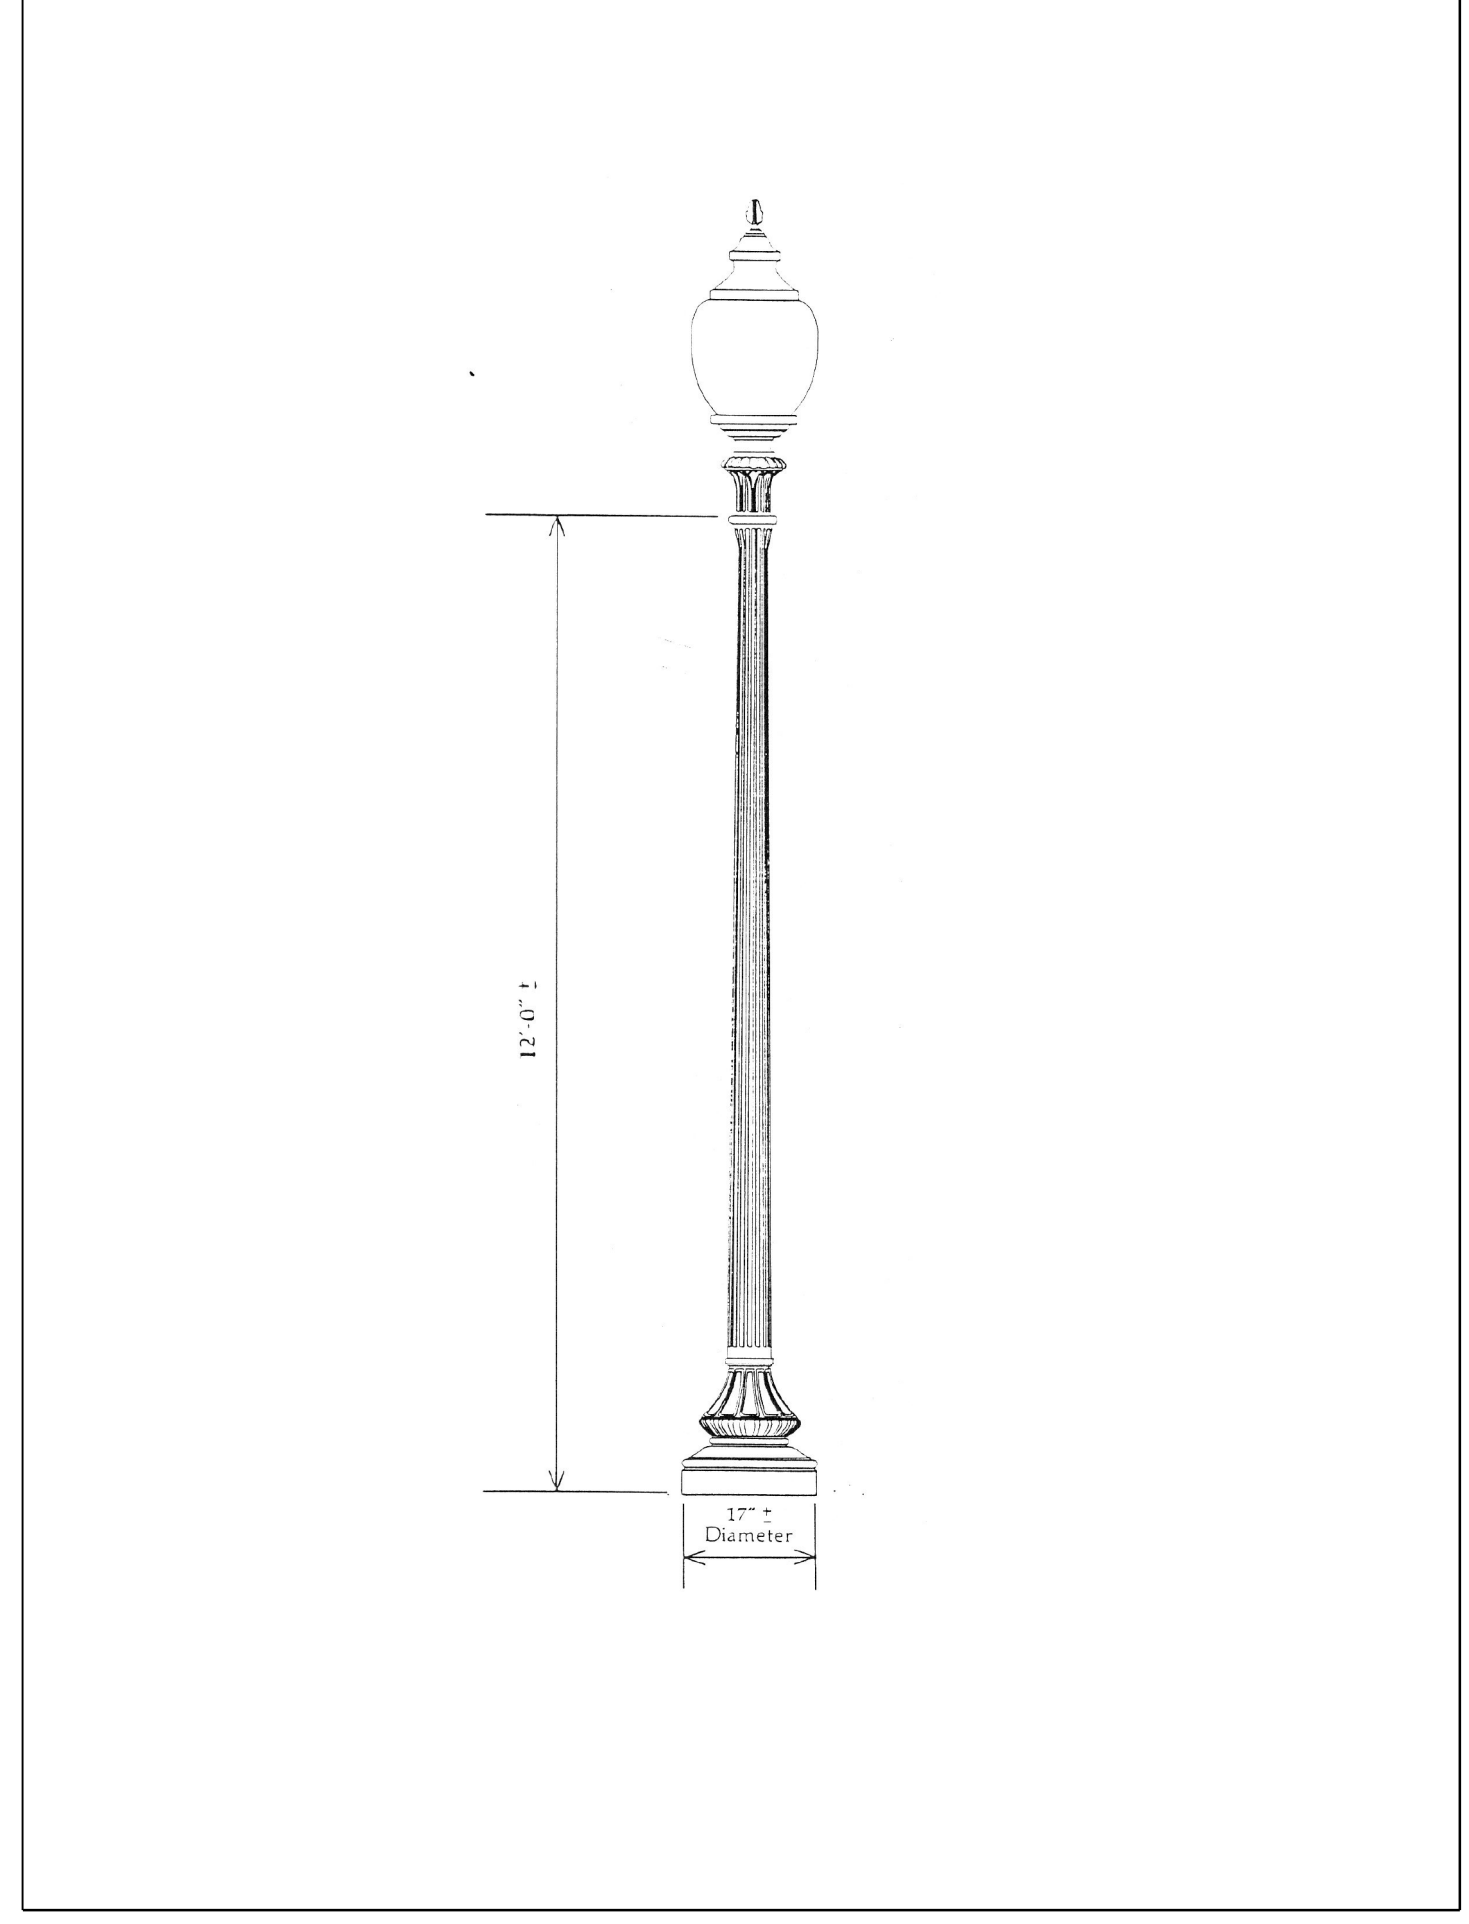

DECORATIVE (RESIDENTIAL) LAMP POST

NOTES FOR DECORATIVE LAMP POST:


- LAMP POST TO MATCH MONTGOMERY COUNTY DEPARTMENT OF TRANSPORTATION TRAFFIC AND ENGINEERING OPERATIONS DECORATIVE (RESIDENTIAL) LAMP POST.
- PROPOSED LAMP POST IDENTIFIED IN THE 800 STREETLIGHT SPECIFICATION COMPLIES WITH MONTGOMERY COUNTY WIND LOAD STANDARDS.



PROFESSIONAL CERTIFICATION

I HEREBY CERTIFY THAT THESE DOCUMENTS WERE PREPARED OR APPROVED BY ME, AND THAT I AM A DULY LICENSED PROFESSIONAL ENGINEER UNDER THE STATE LAWS OF THE STATE OF MARYLAND, LICENSE NO. 33928, EXPIRATION DATE: 01/15 /2021.

GERARD ADAMS BAXTER, II, PE

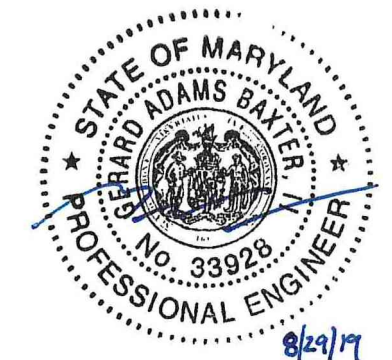

MONTGOMERY COUNTY DEPARTMENT OF HOUSING AND COMMUNITY AFFAIRS MONTGOMERY VILLAGE /SOUTH VILLAGE HOMES LIGHTING AND SITE IMPROVEMENTS PROJECT	
LIGHTING DETAILS	
SCALE	NTS
ADVERTISED DATE	N/A
CONTRACT NO.	
DESIGNED BY	AHB
COUNTY	MONTGOMERY COUNTY
DRAWN BY	AHB
LOGMILE	
CHECKED BY	GAB
DPS PERMIT	
DRAWING NO.	DE-02 OF 02
SHEET NO.	33 OF 46

BY: abortkewicz

SURVEY TRAVERSE POINTS				
POINT	NORTHING	EASTING	ELEVATION	TYPE
JMT 1	541835.2705	1256536.5927	440.47	NAIL
JMT 2	541964.4655	1256942.5013	452.26	R & C
JMT 3	542342.0698	1257136.8060	443.31	R & C

SURVEY NOTES:

- THIS SURVEY WAS BASED ON A FIELD-RUN TOPOGRAPHIC SURVEY PERFORMED BY JOHNSON, MIRMIRAN & THOMPSON (JMT) IN OCTOBER 2018 AND REFLECTS SITE CONDITIONS AS OF THAT DATE.
- COORDINATES ARE REFERENCED TO THE MARYLAND STATE PLANE COORDINATE SYSTEM NAD 83(2011) ZONE 1900 EPOCH 2010 AS DETERMINED BY GPS RTN (KeyNET) OBSERVATIONS IN OCTOBER 2018.
- ELEVATIONS ARE REFERENCED TO THE NORTH AMERICAN VERTICAL DATUM OF 1988 (NAVD88)(GEOID 12B) AS DETERMINED BY GPS RTN (KeyNET) OBSERVATIONS IN OCTOBER 2018.
- ADDITIONAL SPOT ELEVATIONS RESIDE IN THE ELECTRONIC VERSION OF THIS DRAWING BUT ARE NOT PLOTTED HEREON.

BASELINE CONTROL COORDINATES					
CURVE	POINT	STATION	NORTHING	EASTING	BEARING
GF-1	POB	0+00.00	541833.5621	1256561.3419	N 68° 47' 46.39" E
	PI	1+07.54	541872.4570	1256661.5991	N 87° 10' 20.45" E
	PI	1+33.77	541873.7509	1256687.7966	N 67° 34' 23.85" E
	PI	1+61.04	541884.1574	1256713.0112	N 70° 15' 12.77" E
	PC	3+32.45	541942.0688	1256874.3392	
	PI	3+77.29	541957.22	1256916.54	
	CC		541998.5406	1256854.0677	
	PT	4+09.46	542001.9804	1256913.9690	N 3° 17' 11.85" W
	PI	4+25.41	542017.9033	1256913.0546	N 26° 07' 34.29" E
	PI	4+97.29	542082.4374	1256944.7061	N 35° 31' 08.89" E
	PI	5+47.18	542123.0469	1256973.6931	N 29° 55' 42.29" E
	PI	5+52.23	542127.4189	1256976.2100	N 27° 47' 37.95" E
	PI	5+87.50	542158.6185	1256992.6554	N 27° 54' 44.82" E
	PI	6+22.71	542189.7356	1257009.1397	N 80° 44' 25.45" E
	PI	6+45.13	542193.3435	1257031.2695	N 27° 28' 16.28" E
PI	7+98.62	542329.5196	1257102.0713	N 28° 38' 40.37" E	
PI	8+09.74	542339.2863	1257107.4061	N 31° 20' 40.12" E	
POE	8+20.67	542348.6153	1257113.0882		

NOTE: CONSTRUCTION BASELINE IS LOCATED ON INSIDE EDGE OF SIDEWALK.

CURVE DATA						
NAME	DELTA	DC	RADIUS	TANGENT	LENGTH	EXTERNAL
GF-1	73° 32' 24.63"	LEFT	95° 29' 34.68"	60.00'	44.84'	77.01'

SCHEDULE OF QUANTITIES - MONTGOMERY VILLAGE HOA			
MDSHA CATEGORY CODE	DESCRIPTION	UNIT	QUANTITY
120743	TYPE III BARRICADE FOR MAINTENANCE OF TRAFFIC	EA	1
201032	CLASS 2 EXCAVATION (SEE NOTES BELOW)	CY	155
202065	COMMON BORROW (SEE NOTES BELOW)	CY	125
374015	STANDARD 10' COG INLET-MINIMUM DEPTH	EA	1
500000	ASPHALT FOR FULL-DEPTH PATCH	SY	2.7
655105	5 INCH CONCRETE SIDEWALK	SF	4256
690134	6 FOOT GALVANIZED CHAIN LINK FENCE WITH BLACK BONDED VINYL COATING (STA 2+80.20 TO STA 8+10.17)	LF	515
801605	SHEET ALUMINUM SIGNS	SF	3

QUANTITIES NOTES:

- ALL EXCAVATION, INCLUDING SIDEWALK, PAVEMENT, AND CURB AND GUTTER, TO BE PAID FOR BY CLASS II EXCAVATION.
- EXCAVATION AND BORROW QUANTITIES INCLUDE QUANTITIES SHOW ON SHEET EN-01.

SOUTH LAKE ELEMENTARY SCHOOL


SCHEDULE OF QUANTITIES - NON-HOA			
MDSHA CATEGORY CODE	DESCRIPTION	UNIT	QUANTITY
120743	TYPE III BARRICADE FOR MAINTENANCE OF TRAFFIC	EA	3
504584	SUPERPAVE ASPHALT MIX 25.0 MM FOR FULL-DEPTH PATCH, PG 64S-22, LEVEL 2	SY	15.8
549001	5 INCH WHITE PAVEMENT MARKING PAINT	LF	105
634301	STANDARD TYPE A COMBINATION CURB AND GUTTER 12 INCH GUTTER PAN 8 INCH	LF	70
655105	5 INCH CONCRETE SIDEWALK	SF	200
690134	6 FOOT GALVANIZED CHAIN LINK FENCE WITH BLACK BONDED VINYL COATING (STA 8+10.17 TO STA 8+19.31)	LF	10
801605	SHEET ALUMINUM SIGNS	SF	9

CONSTRUCTION NOTES:

- FOR REMOVAL OF EXISTING CURB AND GUTTER, CONTRACTOR SHALL SAW CUT APPROXIMATELY 2 FEET FROM THE EXISTING EDGE OF PAVING REMOVED PAVEMENT SHALL BE REPLACED WITH FULL DEPTH PATCHING WITH INSTALLATION OF NEW CURB AND GUTTER. COST OF SAWCUT SHALL BE INCIDENTAL TO CLASS II EXCAVATION.
- CONTRACTOR SHALL CLOSE SIDEWALK FOR DURATION OF SIDEWALK CONSTRUCTION.
- DURING SIDEWALK CONSTRUCTION, THE CONTRACTOR SHALL INSTALL A BARRIER ACROSS THE FULL WIDTH OF THE SIDEWALK APPROACHING THE CLOSURE. THIS BARRIER SHOULD BE DETECTABLE BY A VISUALLY IMPAIRED INDIVIDUAL TRAVELING WITH THE AID OF A CANE.
- THE CONTRACTOR SHALL MAINTAIN AND PROVIDE ACCESS TO ALL SIDEWALKS AND PEDESTRIAN RAMPS DURING CONSTRUCTION. THE CONTRACTOR SHALL COORDINATE WITH THE ENGINEER FOR APPROVAL TO MAINTAIN AND PROVIDE PEDESTRIAN TRAFFIC DURING CONSTRUCTION.

PEDESTRIAN MOT LEGEND:

••• TYPE III BARRICADE

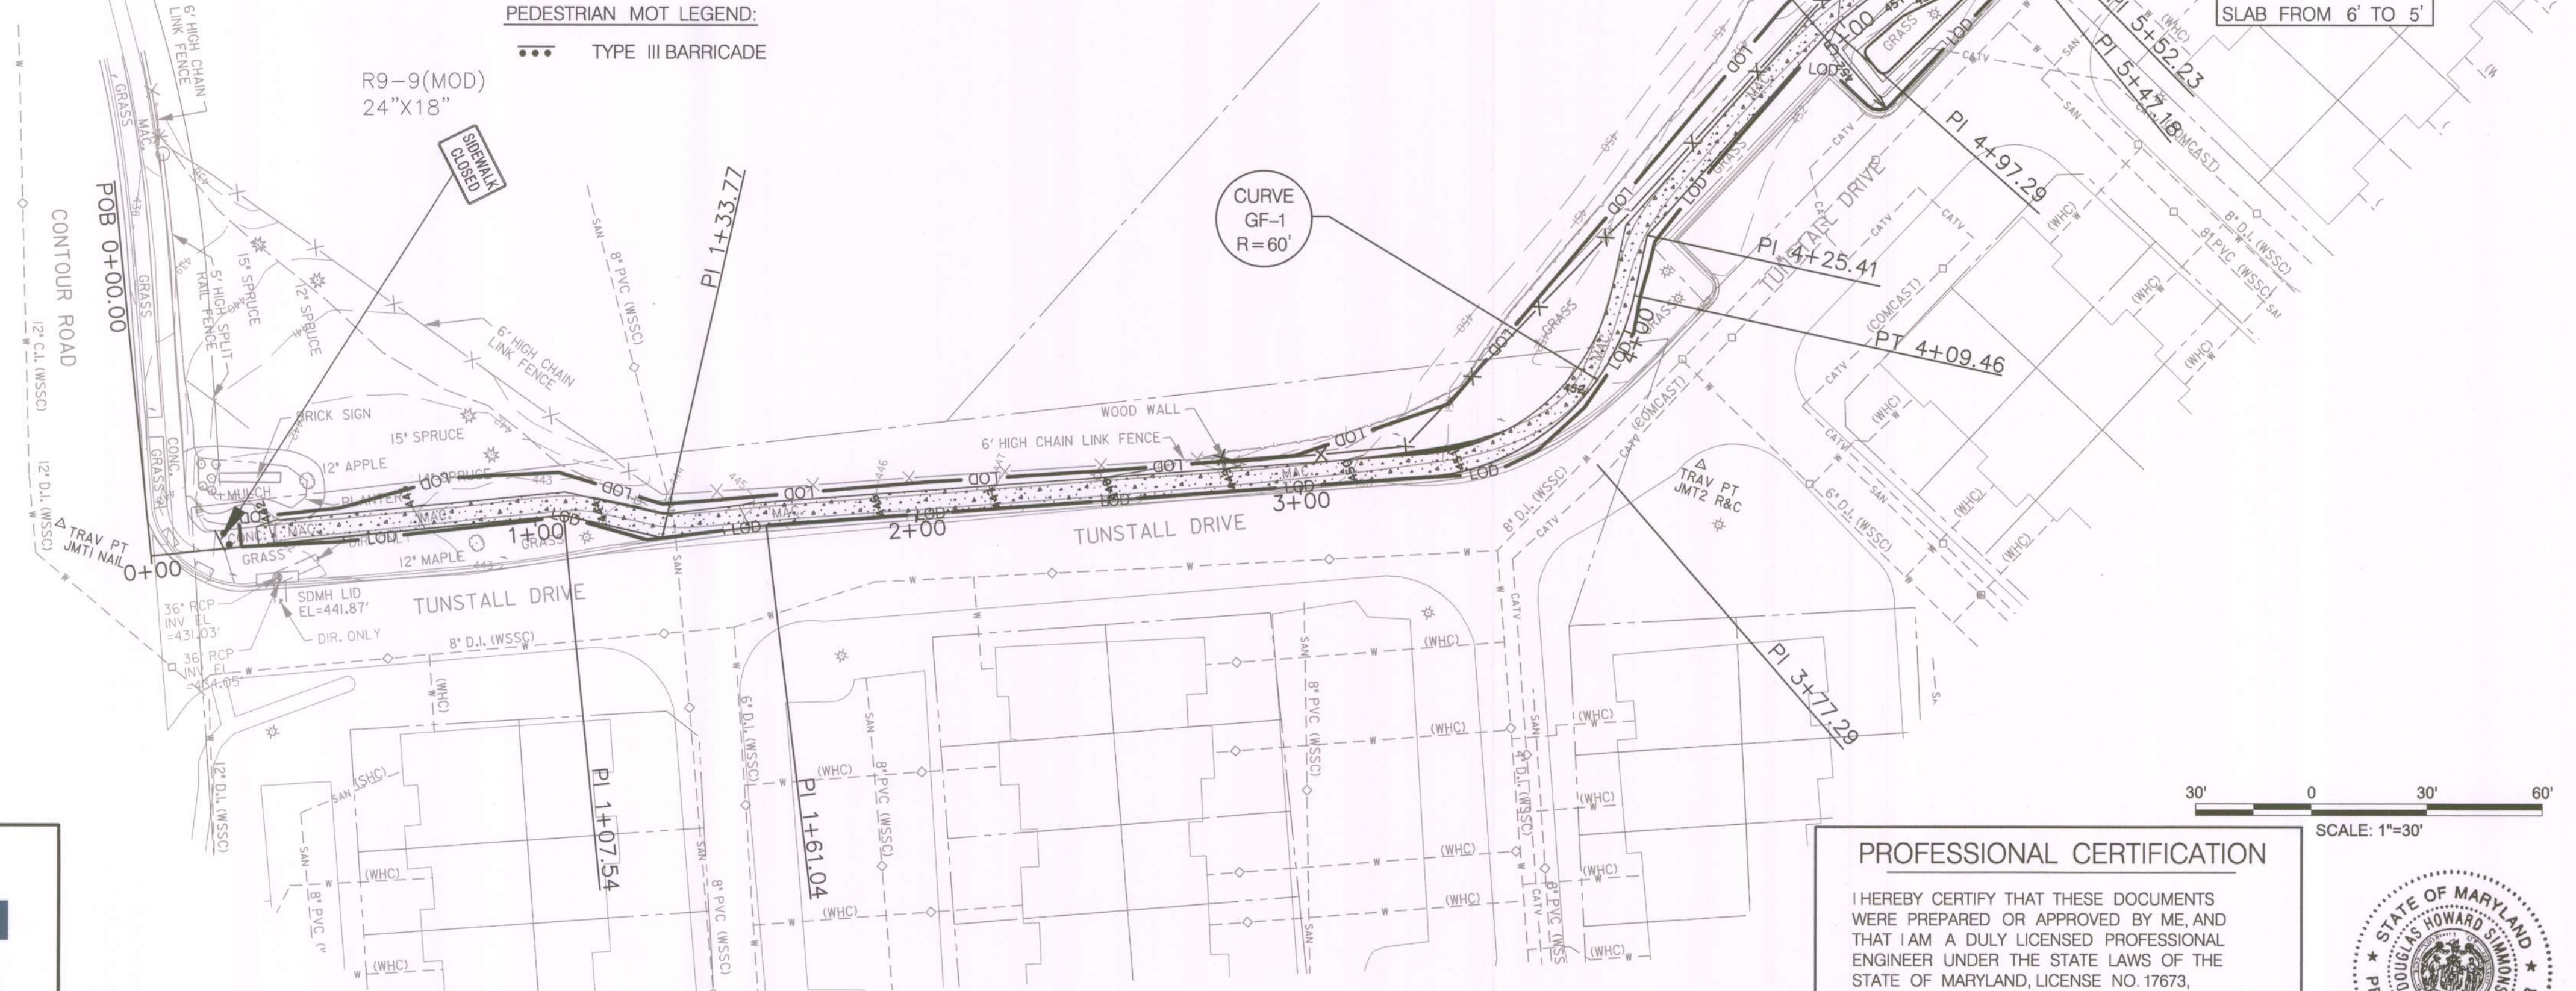

THE FOLLOWING STANDARDS ARE REQUIRED FOR THIS PROJECT:

- MD-374.31 - STANDARD COG INLETS 5', 10' 15' AND 20'
- MD-383.61 - STANDARD MANHOLE TYPE D FRAME & COVER
- MD-620.02 - STANDARD TYPES A & B CONCRETE CURB AND COMBINATION CONCRETE CURB & GUTTER
- MD-655.11 - SIDEWALK RAMPS PERPENDICULAR
- MD-655.12 - SIDEWALK RAMPS PARALLEL
- MD-655.40 - DETECTABLE WARNING SURFACES
- MD-690.01 - CHAIN LINK FENCE TYPICAL 5 FT., RURAL 6 FT. & 8 FT

FOR ALL STANDARDS REFERRED TO ON THE PLANS THE CONTRACTOR MUST GO TO THE BOOK OF STANDARDS WHICH WILL HAVE THE MOST CURRENT VERSION. THE BOOK OF STANDARDS CAN BE ACCESSED AT:
<http://apps.roads.maryland.gov/businesswithshabiz/StdSpecs/ManualStdPub/publicationsonline/thdbooks/index.asp>

ALL ITEMS ARE TO BE CONSTRUCTED IN ACCORDANCE WITH THE CURRENT VERSION OF THE REFERENCED STANDARD AT THE TIME OF CONSTRUCTION.

MONTGOMERY COUNTY
 DEPARTMENT OF HOUSING AND COMMUNITY AFFAIRS
MONTGOMERY VILLAGE / SOUTH VILLAGE HOMES
 LIGHTING AND SITE IMPROVEMENTS PROJECT



GROVER'S FORGE - SIDEWALK PLAN

SCALE	30	SCALE	ADVERTISED DATE	N/A	CONTRACT NO.	
DESIGNED BY	RJS	COUNTY	MONTGOMERY COUNTY			
DRAWN BY	RJS	LOGMILE				
CHECKED BY	JJR					
DPS PERMIT						
DRAWING NO.	PS - 01	OF	01	SHEET NO.	34	OF 46



PROFESSIONAL CERTIFICATION

I HEREBY CERTIFY THAT THESE DOCUMENTS WERE PREPARED OR APPROVED BY ME, AND THAT I AM A DULY LICENSED PROFESSIONAL ENGINEER UNDER THE STATE LAWS OF THE STATE OF MARYLAND, LICENSE NO. 17673, EXPIRATION DATE: 01/29/2020.

[Signature] 6/25/19
 DOUGLAS H. SIMMONS, PE

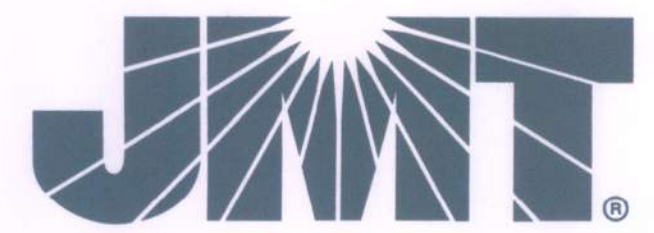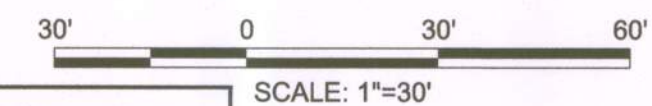

BY: Stratmeyer

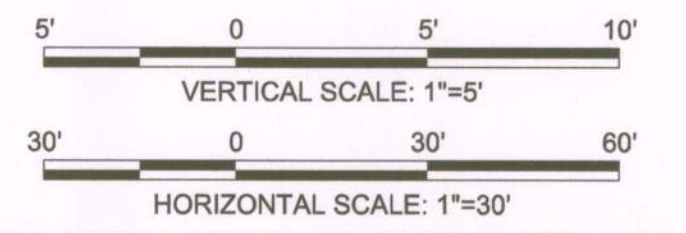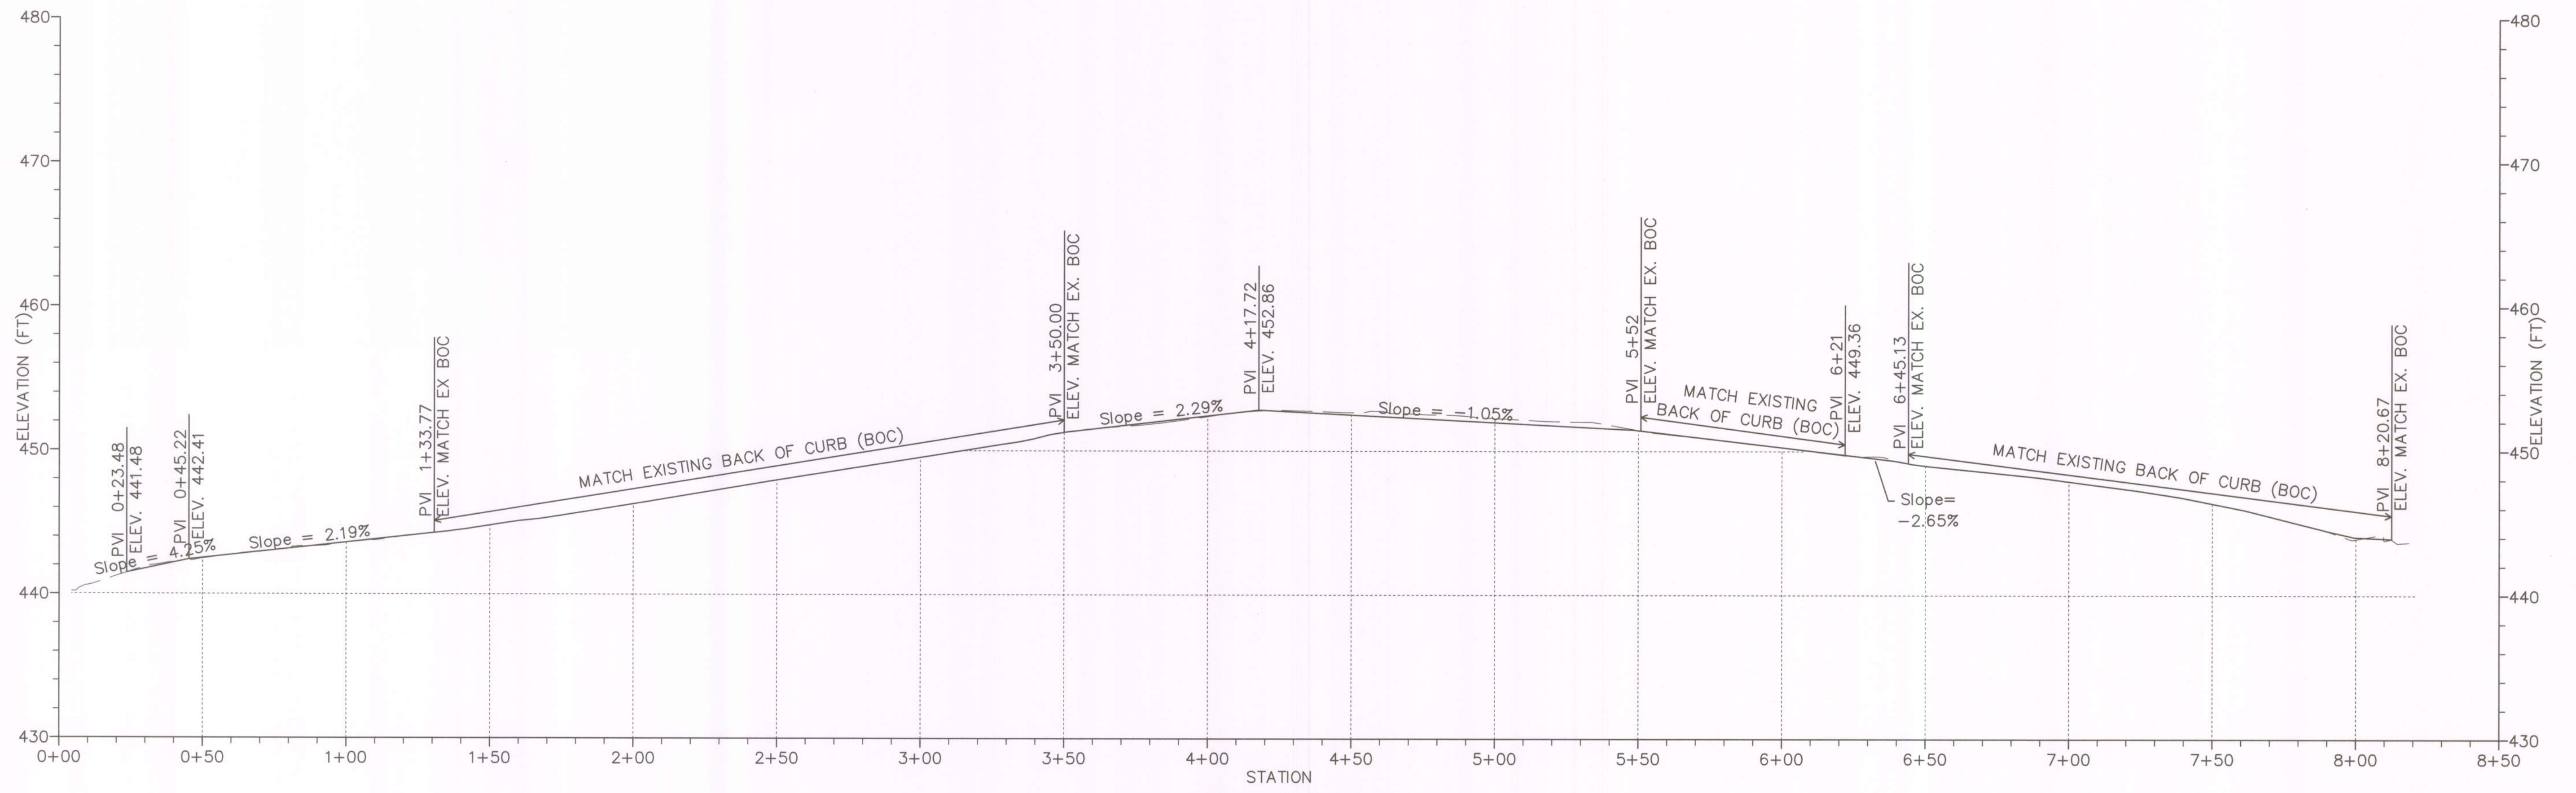

BY: Stratmeyer




PROFESSIONAL CERTIFICATION
 I HEREBY CERTIFY THAT THESE DOCUMENTS WERE PREPARED OR APPROVED BY ME, AND THAT I AM A DULY LICENSED PROFESSIONAL ENGINEER UNDER THE STATE LAWS OF THE STATE OF MARYLAND, LICENSE NO. 17873, EXPIRATION DATE: 01/29/2020.
[Signature] 6/25/19
 DOUGLAS H. SIMMONS, PE

MONTGOMERY COUNTY
 DEPARTMENT OF HOUSING AND COMMUNITY AFFAIRS
 MONTGOMERY VILLAGE / SOUTH VILLAGE HOMES
 LIGHTING AND SITE IMPROVEMENTS PROJECT

GROVER'S FORGE - SIDEWALK PROFILE		
SCALE <u>30'</u> SCALE <u> </u> ADVERTISED DATE <u> </u> N / A <u> </u> CONTRACT NO. <u> </u>		
DESIGNED BY <u> RJS </u>	COUNTY <u> MONTGOMERY COUNTY </u>	
DRAWN BY <u> RJS </u>	LOGMILE <u> </u>	
CHECKED BY <u> JJR </u>		
DPS PERMIT <u> </u>		
DRAWING NO. HP-01	OF 01	SHEET NO. 35 OF 46

ADA RAMP CALLOUT POINTS				
POINT	NORTHING	EASTING	ELEVATION	NOTE
1000	542342.6772	1257103.6137	443.92	
1001	542346.9467	1257106.2158	443.60	LEVEL LANDING
1002	542351.2162	1257108.8179	443.53	LEVEL LANDING
1003	542348.6143	1257113.0871	MATCH EXISTING (443.96)	LEVEL LANDING
1004	542344.3448	1257110.4850	443.52	LEVEL LANDING
1005	542340.0752	1257107.8829	MATCH EXISTING (443.87)	
1006	542331.1746	1257131.7881	MATCH EXISTING (443.54)	
1007	542335.4593	1257134.7055	MATCH EXISTING (443.39)	
1008	542332.8564	1257138.8692	443.84	
1009	542338.2798	1257148.7932	443.42	LEVEL LANDING
1010	542342.1479	1257149.8585	MATCH EXISTING (443.34)	LEVEL LANDING
1011	542333.5606	1257146.9695	444.22	
1012	542328.7676	1257136.2354	444.01	
1013	542331.1034	1257151.2407	MATCH EXISTING (444.28)	LEVEL LANDING
1014	542335.4374	1257153.7340	MATCH EXISTING (443.57)	LEVEL LANDING
1015	542322.7729	1257146.4483	444.38	LEVEL LANDING

SCHEDULE OF QUANTITIES - NON-HOA			
MDSHA CATEGORY CODE	DESCRIPTION	UNIT	QUANTITY
655120	DETECTABLE WARNING SURFACE FOR CURB RAMPS	SF	35

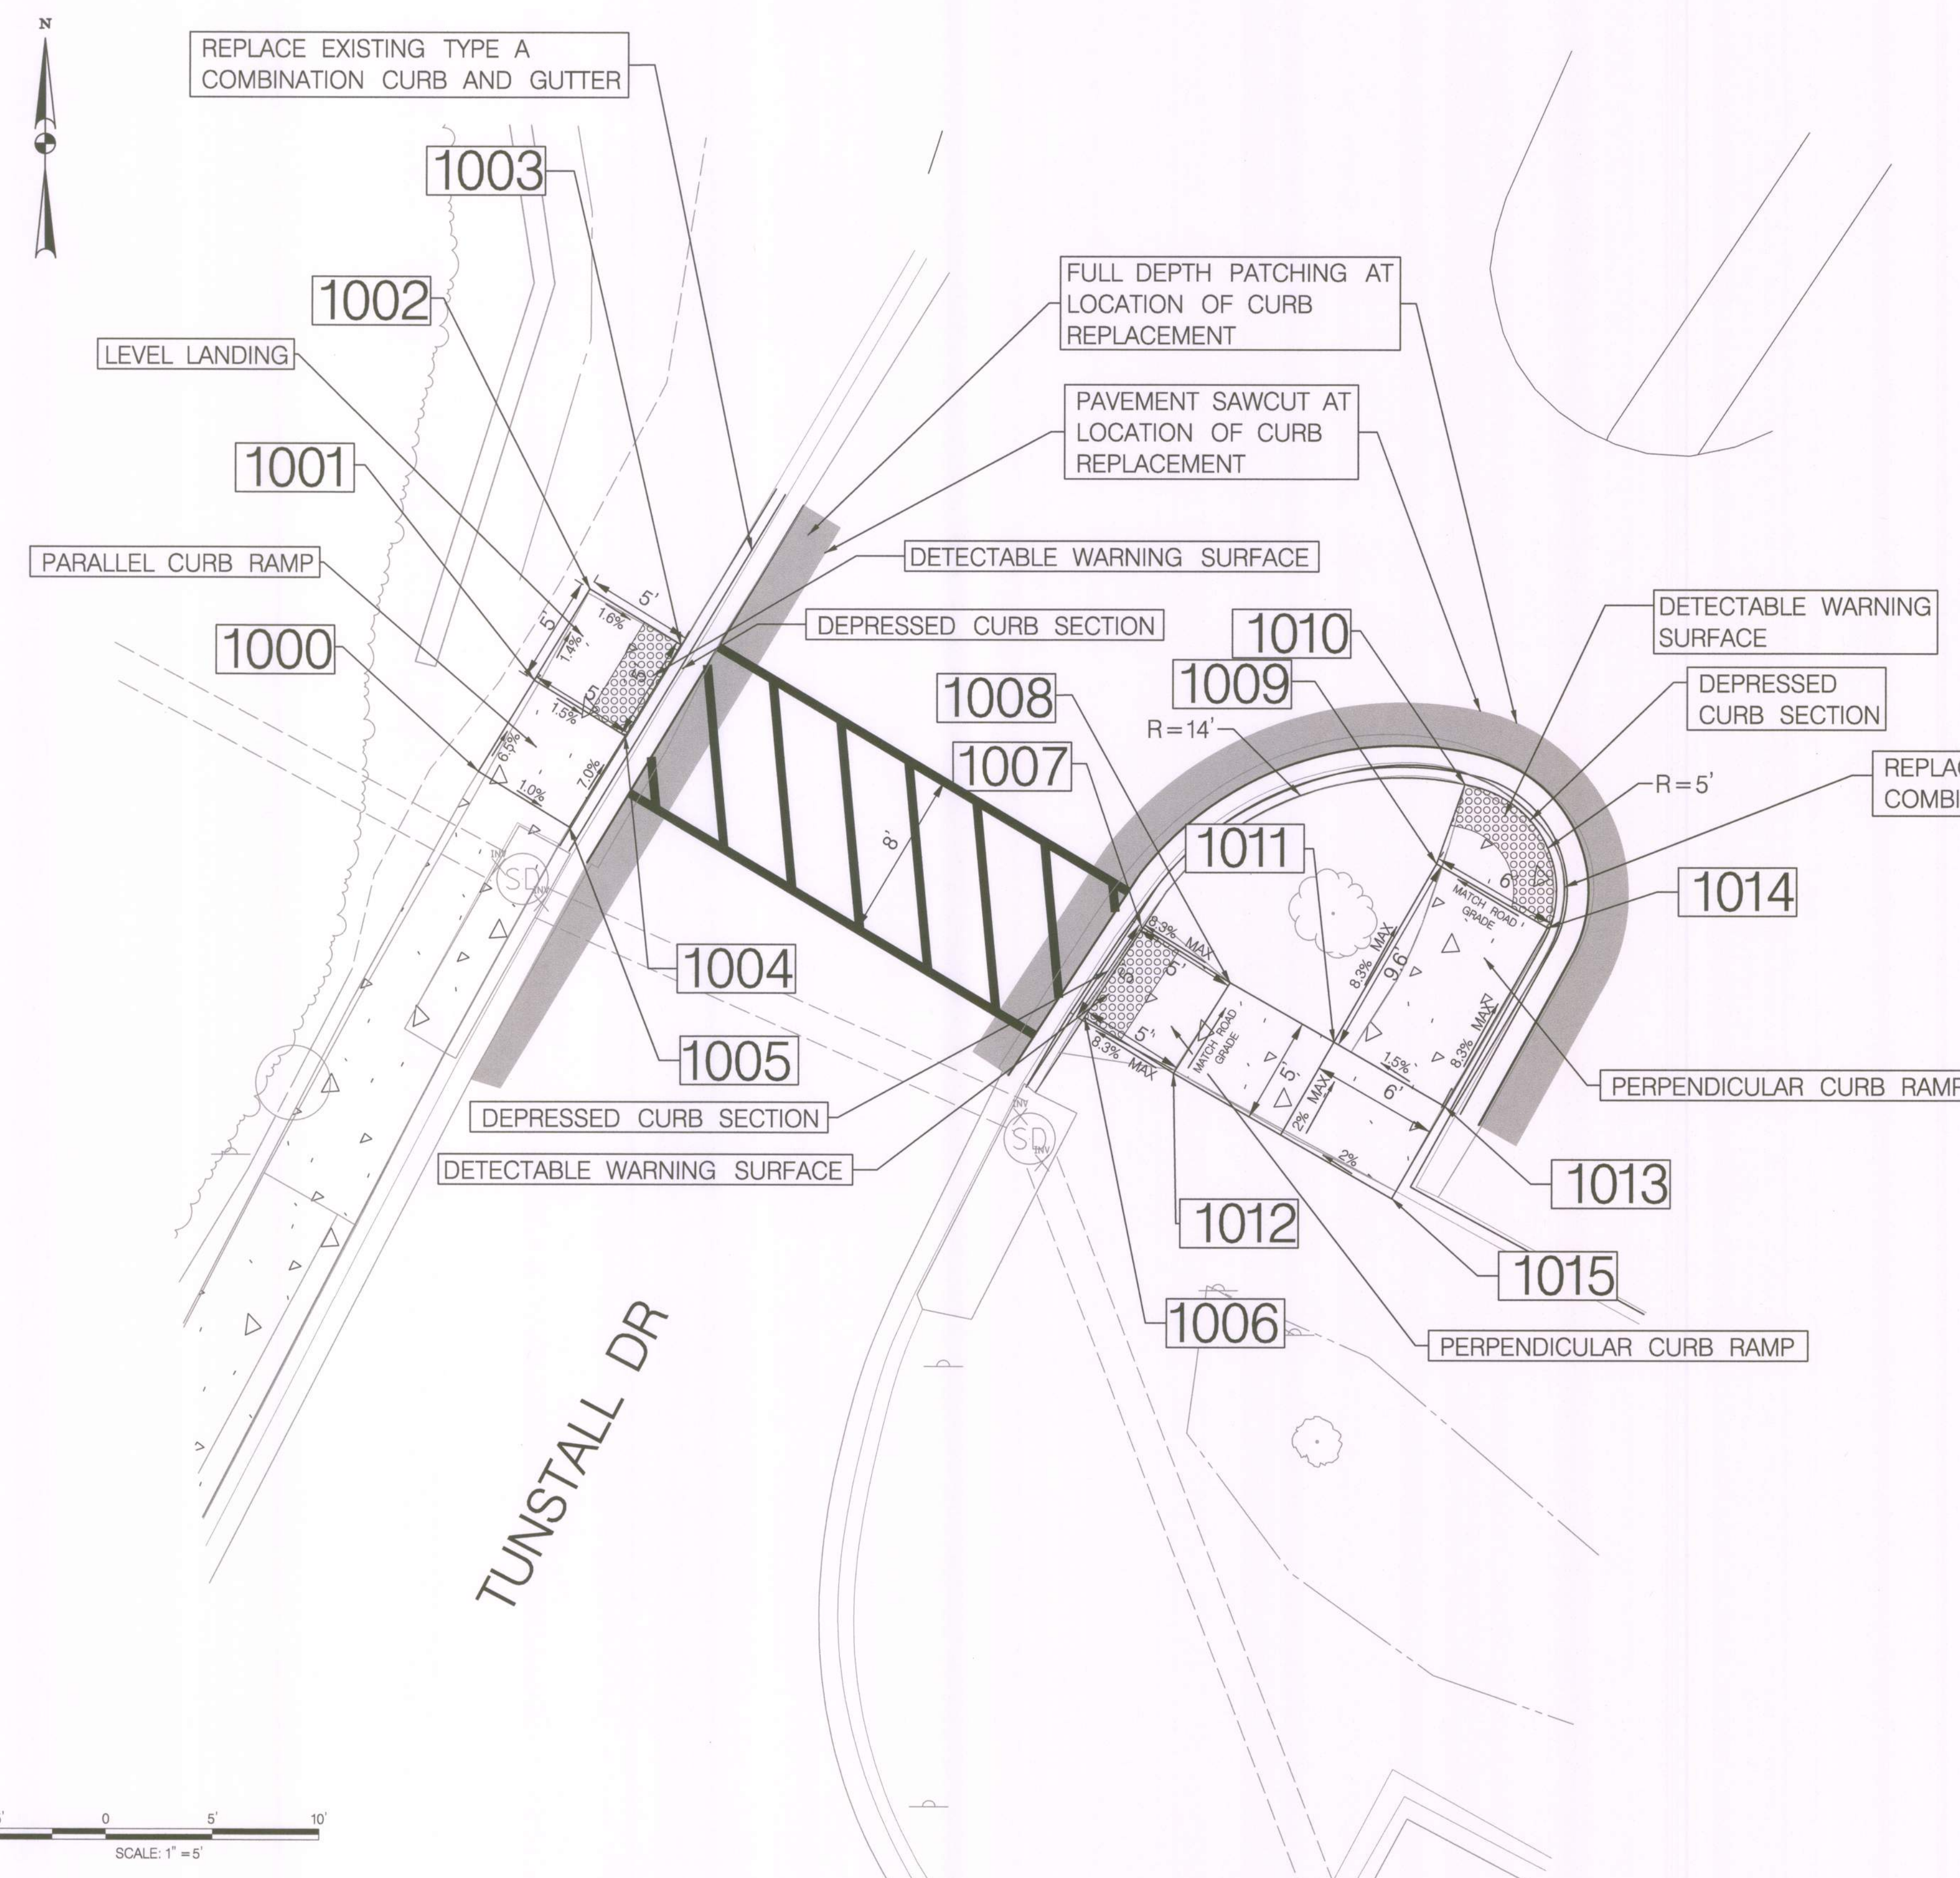

PROFESSIONAL CERTIFICATION

I HEREBY CERTIFY THAT THESE DOCUMENTS WERE PREPARED OR APPROVED BY ME, AND THAT I AM A DULY LICENSED PROFESSIONAL ENGINEER UNDER THE STATE LAWS OF THE STATE OF MARYLAND, LICENSE NO. 17673, EXPIRATION DATE: 01/29/2020.

DS
DOUGLAS H. SIMMONS, PE

MONTGOMERY COUNTY
DEPARTMENT OF HOUSING AND COMMUNITY AFFAIRS


MONTGOMERY VILLAGE /SOUTH VILLAGE HOMES
LIGHTING AND SITE IMPROVEMENTS PROJECT

GROVER'S FORGE - SIDEWALK DETAILS

SCALE: 5 SCALE, ADVERTISED DATE: N/A, CONTRACT NO. _____

DESIGNED BY: RJS COUNTY: MONTGOMERY COUNTY
DRAWN BY: RJS LOGMILE: _____
CHECKED BY: JJR
DPS PERMIT: _____

DRAWING NO. **DT-01** OF **01** SHEET NO. 36 OF 46

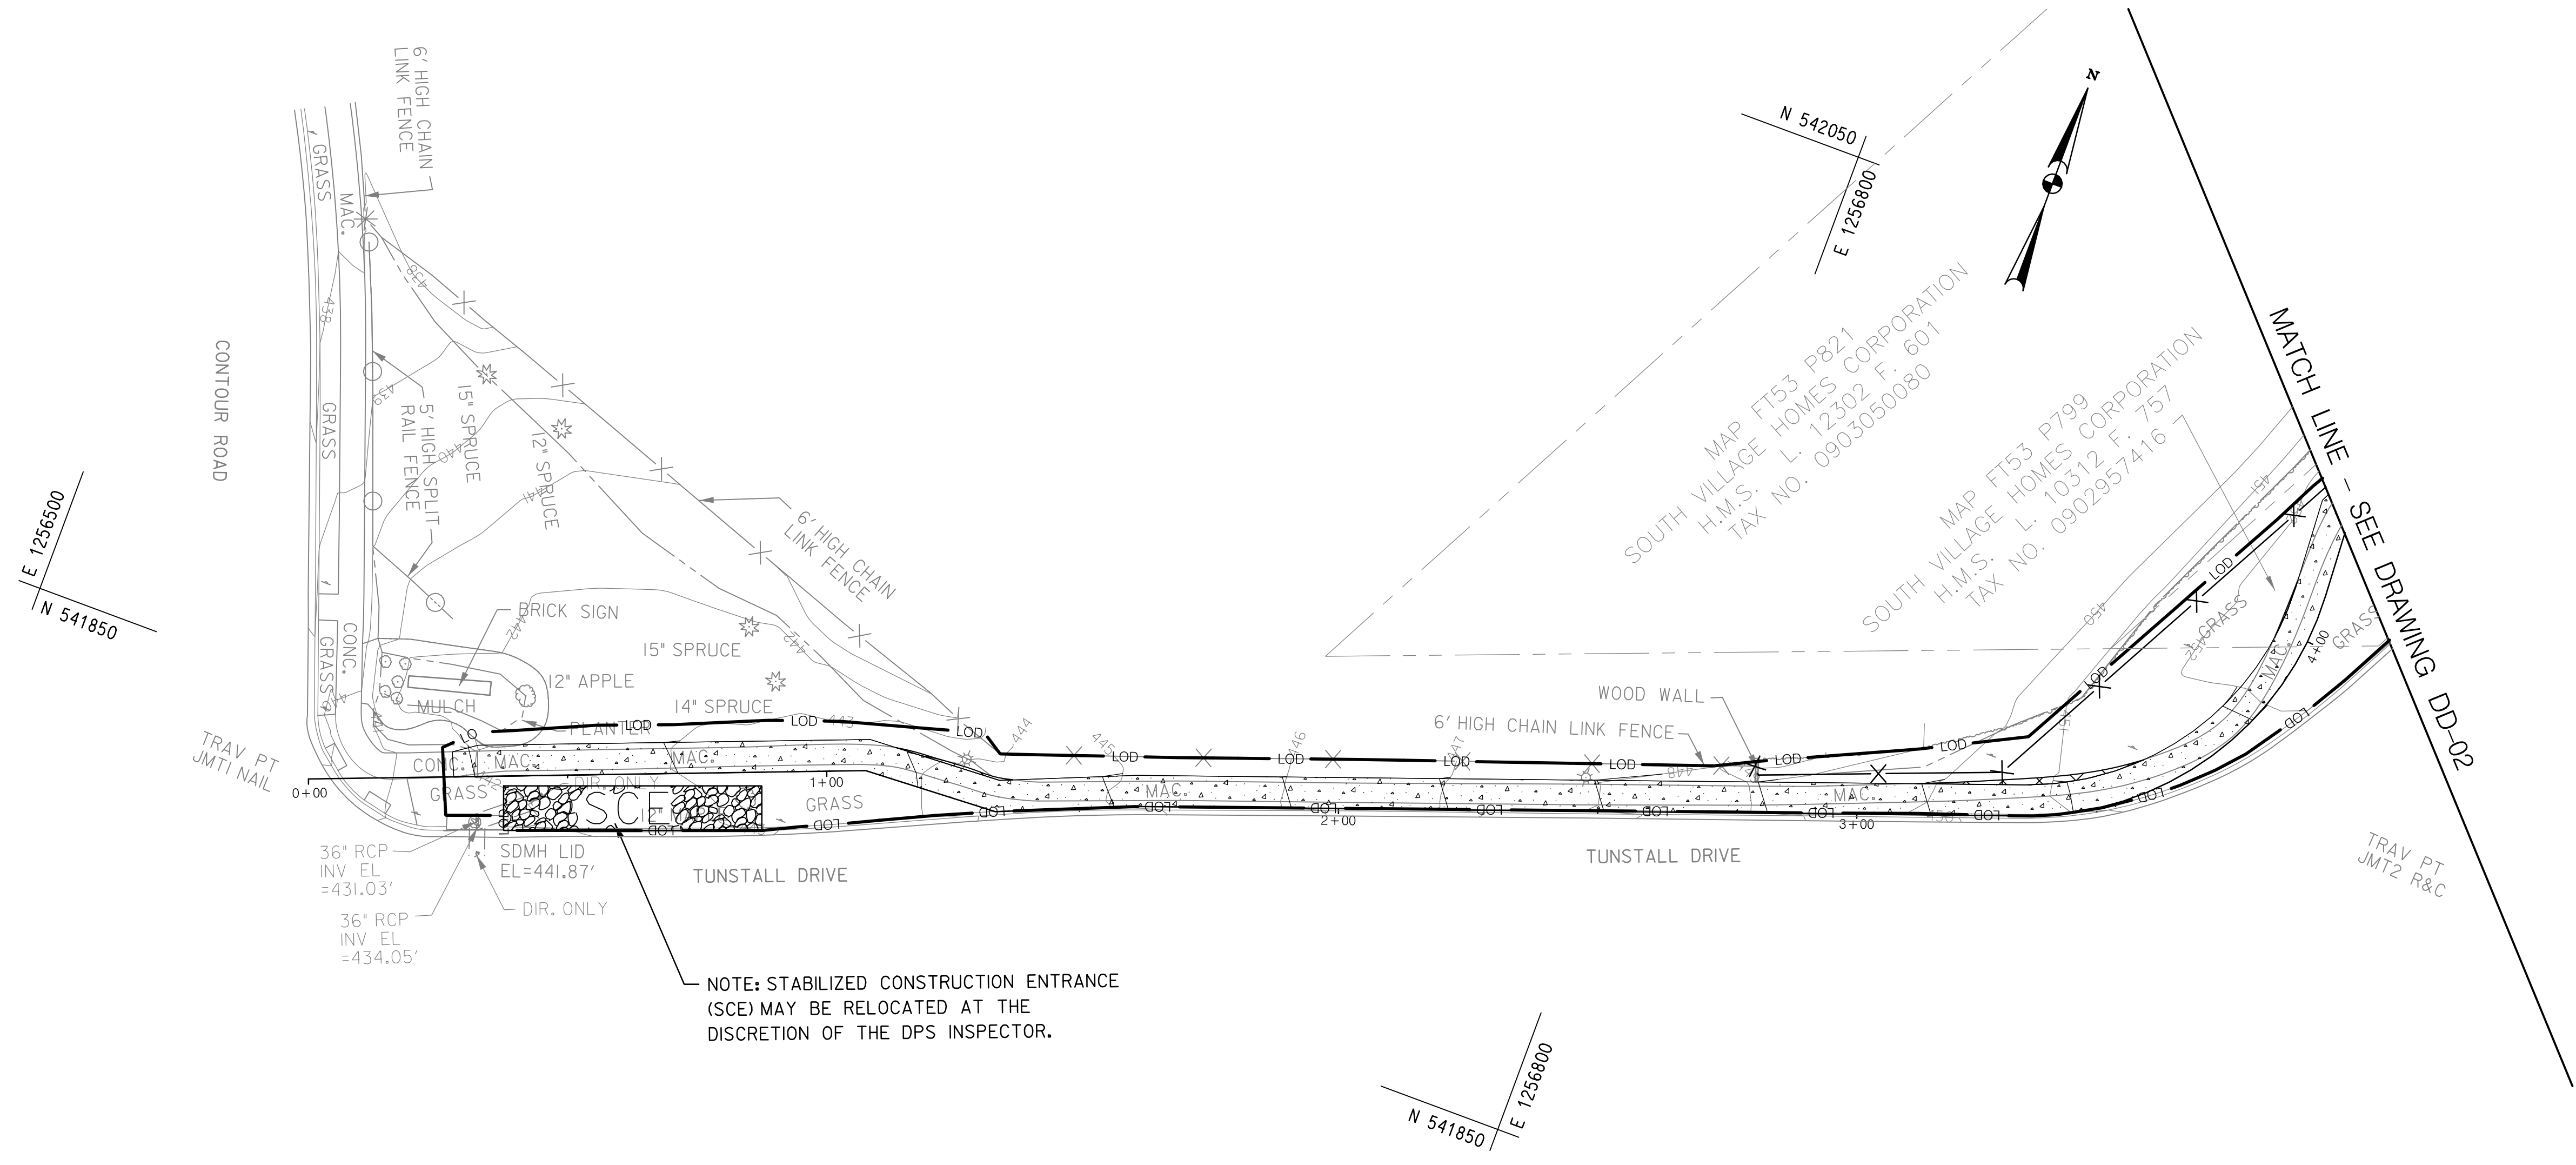


NOTE: STABILIZED CONSTRUCTION ENTRANCE (SCE) MAY BE RELOCATED AT THE DISCRETION OF THE DPS INSPECTOR.

SEDIMENT CONTROL NOTES:

1. WORK IS TO BE DONE AS A CUT AND COVER OPERATION. ONLY DISTURB WHAT CAN BE STABILIZED AT THE END OF EACH WORK DAY. ADEQUATE SEDIMENT CONTROL MEASURES ARE TO BE INSTALLED AS NEEDED AT THE END OF EACH WORK DAY.
2. ANY SEDIMENT TRACKED ONTO THE ROADWAY SHALL BE PROMPTLY REMOVED.
3. SILT FENCE OR OTHER SEDIMENT CONTROL MEASURES ARE TO BE ADDED, REMOVED, OR RELOCATED BY THE DPS INSPECTOR AS SITE GRADING PROGRESSES.

LEGEND

	5 INCH CONCRETE SIDEWALK
	FULL DEPTH ASPHALT PAVING
	GRINDING & ASPHALT RESURFACING
	SIDEWALK REMOVAL
	DETECTABLE WARNING SURFACE
	PROPOSED FENCE
	PROPOSED CONTOURS

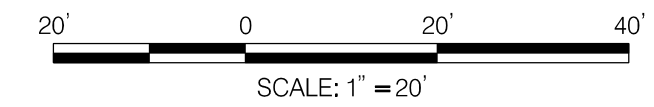

MONTGOMERY COUNTY
 DEPARTMENT OF HOUSING AND COMMUNITY AFFAIRS

**MONTGOMERY VILLAGE /SOUTH VILLAGE HOMES
 LIGHTING AND SITE IMPROVEMENTS PROJECT**

GROVER'S FORGE - GRADING AND DRAINAGE


SCALE: 1" = 20' ADVERTISED DATE: N/A CONTRACT NO. _____

DESIGNED BY: JB COUNTY: MONTGOMERY COUNTY
 DRAWN BY: JB LOGMILE: _____
 CHECKED BY: KS
 DPS PERMIT: 284408

DRAWING NO. **DD - 01** OF **02** SHEET NO. 37 OF 46

RJM ENGINEERING

BY: Kevin -

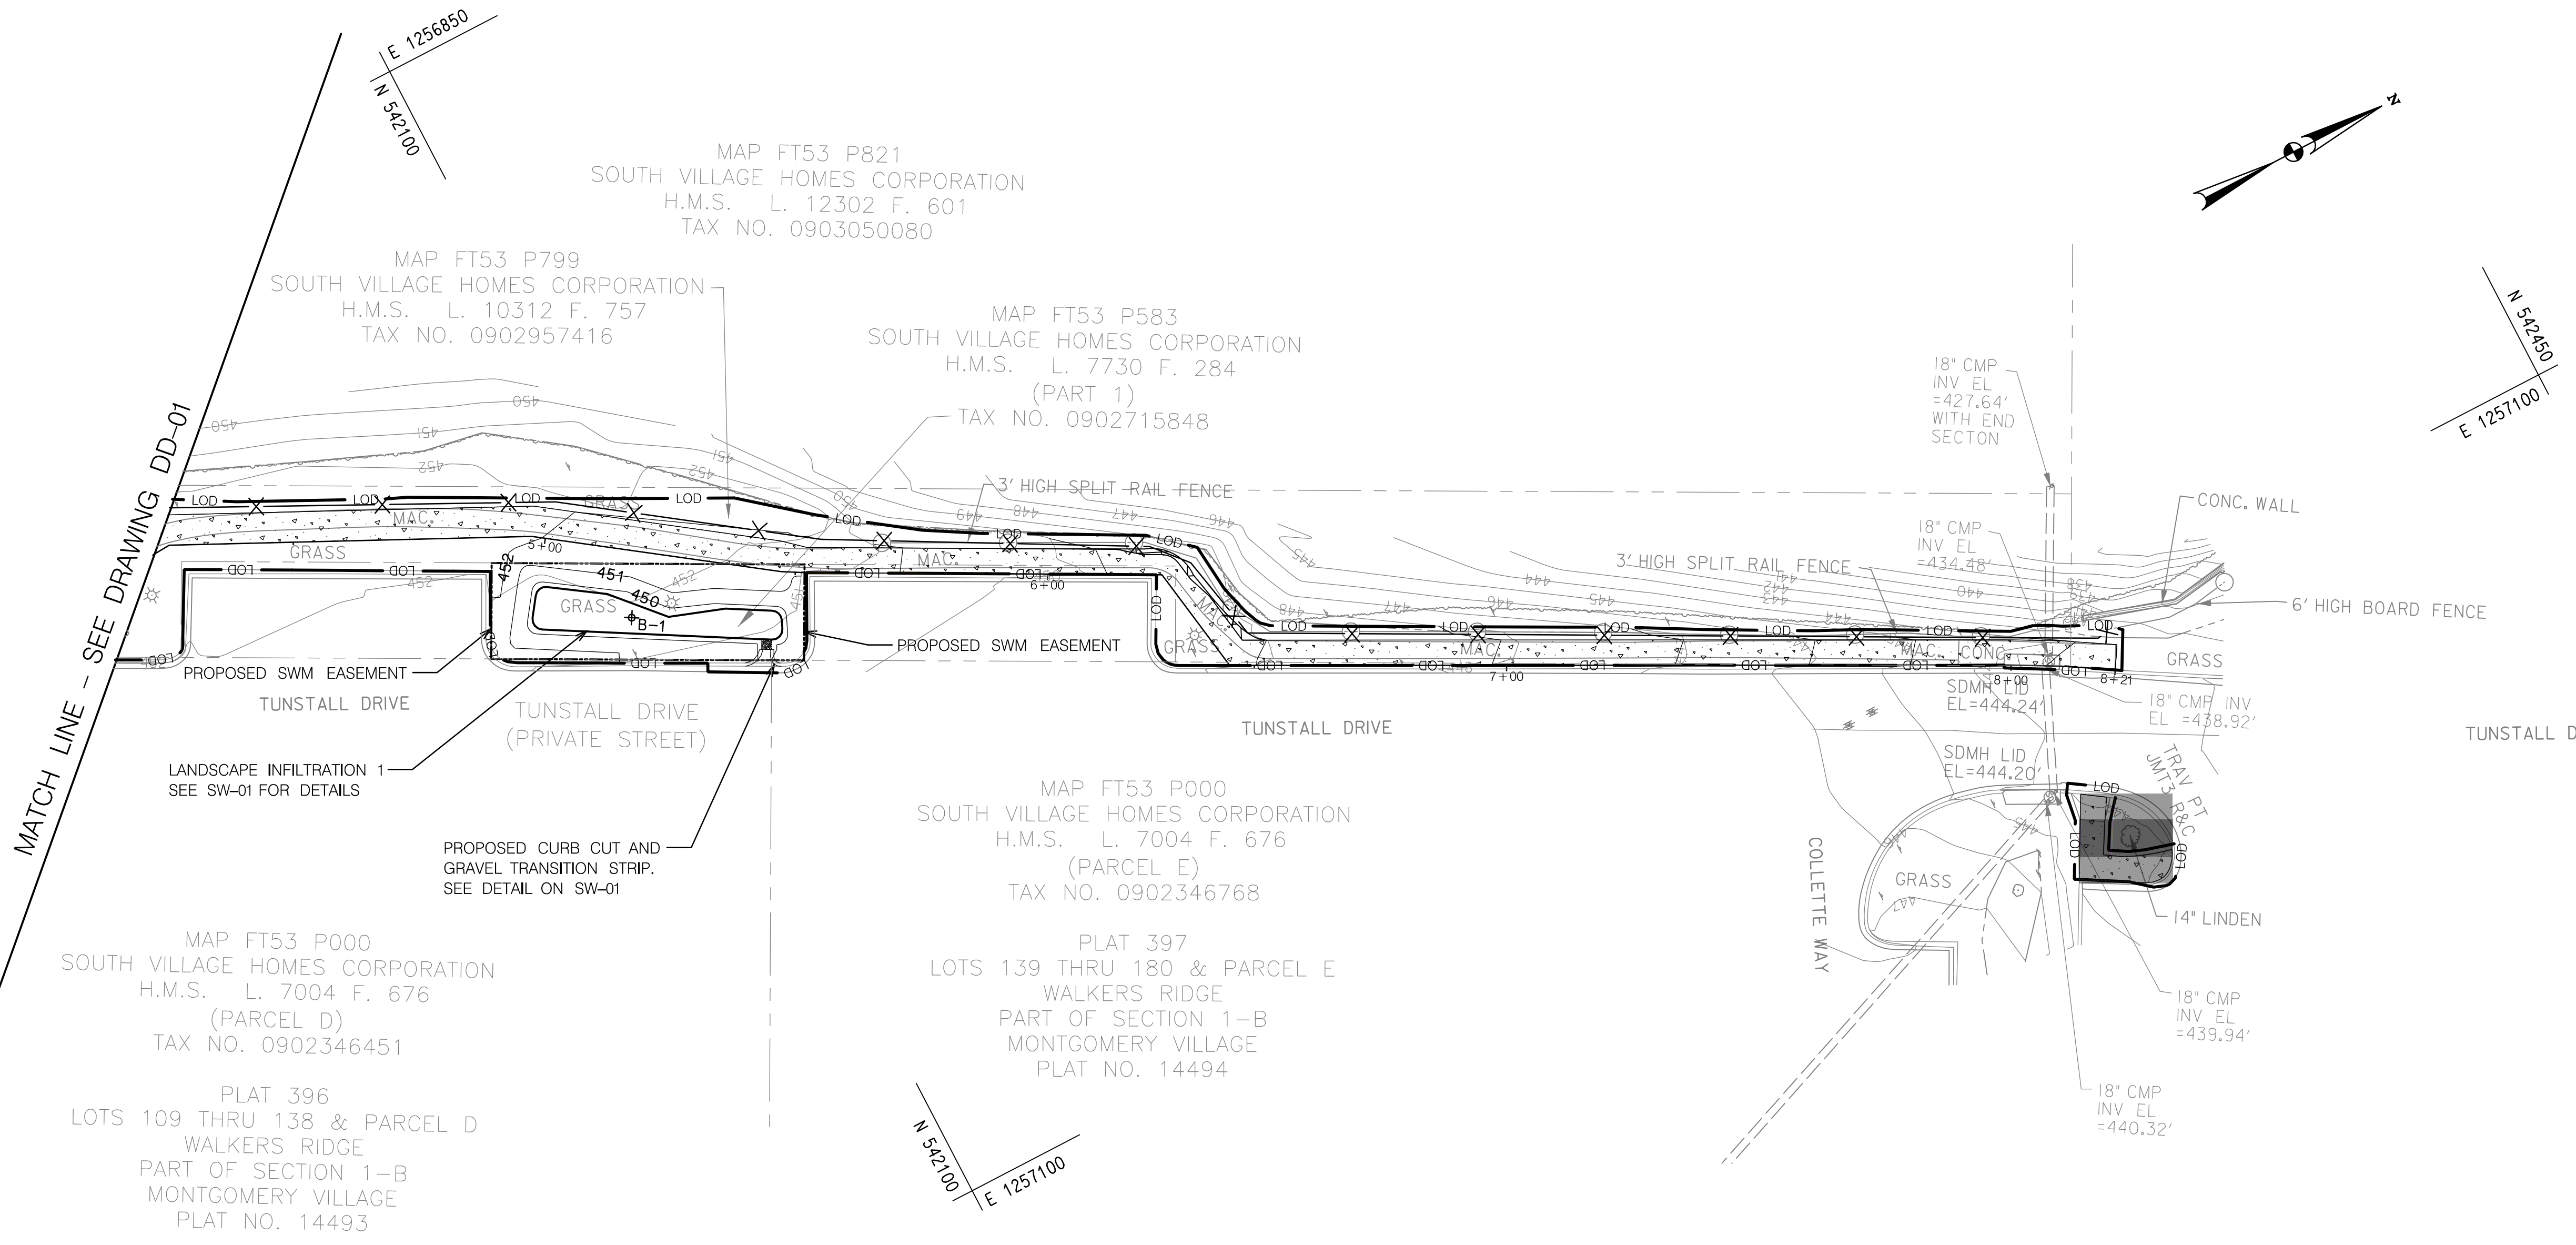


SEDIMENT CONTROL NOTES:



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LEGEND

	5 INCH CONCRETE SIDEWALK
	FULL DEPTH ASPHALT PAVING
	GRINDING & ASPHALT RESURFACING
	SIDEWALK REMOVAL
	DETECTABLE WARNING SURFACE
	PROPOSED FENCE
	SOIL BORING
	PROPOSED CONTOURS

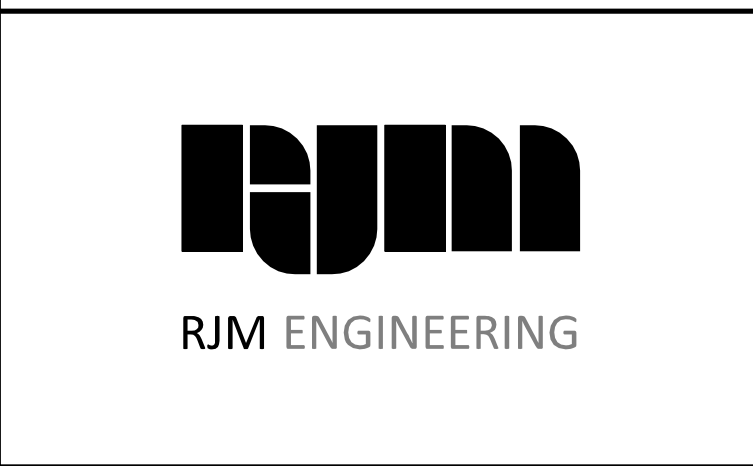

BY: Kevin -

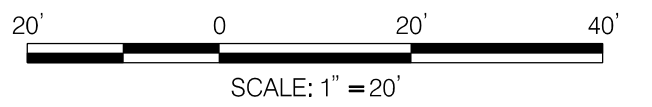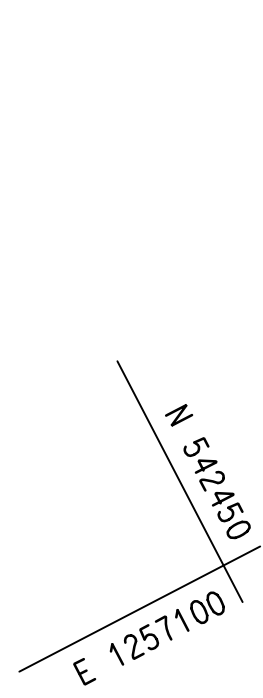

MONTGOMERY COUNTY
 DEPARTMENT OF HOUSING AND COMMUNITY AFFAIRS

**MONTGOMERY VILLAGE /SOUTH VILLAGE HOMES
 LIGHTING AND SITE IMPROVEMENTS PROJECT**

GROVER'S FORGE - GRADING AND DRAINAGE

SCALE 1" = 20' ADVERTISED DATE TBD CONTRACT NO. _____

DESIGNED BY JB COUNTY MONTGOMERY COUNTY
 DRAWN BY JB LOGMILE _____
 CHECKED BY KS
 DPS PERMIT 284408


DRAWING NO. **DD - 02 OF 02** SHEET NO. 38 OF 46

MAP FT53 P799
 SOUTH VILLAGE HOMES CORPORATION
 H.M.S. L. 10312 F. 757
 TAX NO. 0902957416

MAP FT53 P583
 SOUTH VILLAGE HOMES CORPORATION
 H.M.S. L. 7730 F. 284
 (PART 1)
 TAX NO. 0902715848

MAP FT53 P000
 SOUTH VILLAGE HOMES CORPORATION
 H.M.S. L. 7004 F. 676
 (PARCEL E)
 TAX NO. 0902346768

PLAT 397
 LOTS 139 THRU 180 & PARCEL E
 WALKERS RIDGE
 PART OF SECTION 1-B
 MONTGOMERY VILLAGE
 PLAT NO. 14494

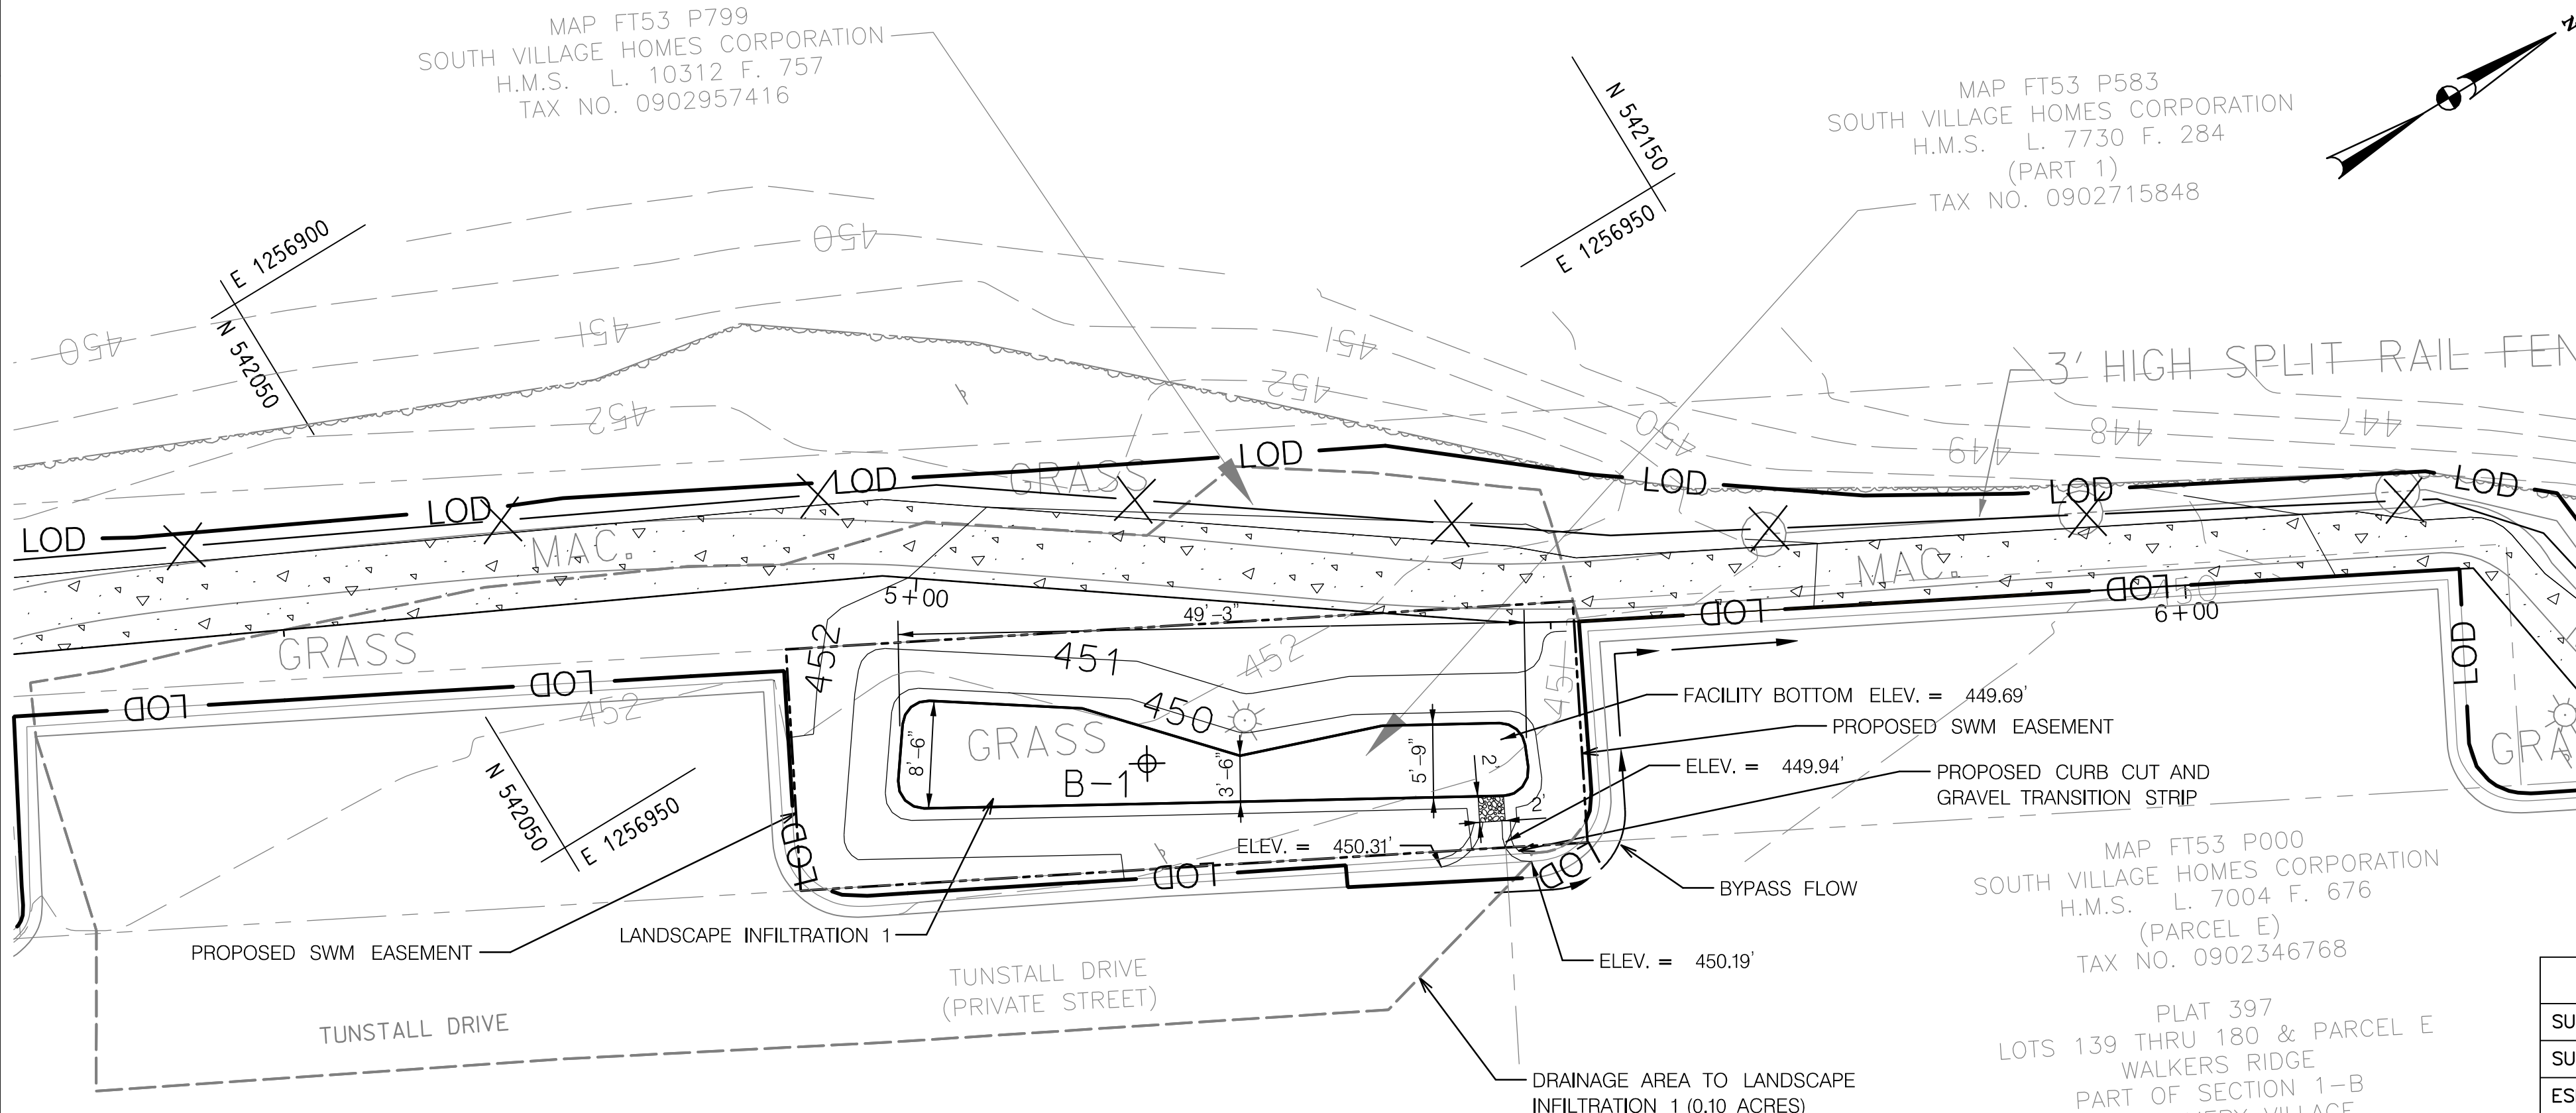

SWM FACILITY PLAN
 1" = 10'


**CONSTRUCTION INSPECTION
 CHECK-OFF LIST FOR LANDSCAPE INFILTRATION**

STAGE	MCDPS INSPECTOR INITIALS/DATE	OWNER/DEVELOPER INITIALS/DATE
MANDATORY NOTIFICATION: Inspection and approval of each practice is required at these points prior to proceeding with construction. The permittee is required to give the MCDPS Inspector twenty-four (24) hours notice (DPS telephone 240-777-0311). The DPS inspector may waive an inspection, and allow the owner/developer to make the required inspection per a prior scheduled arrangement which has been confirmed with the DPS inspector in writing. Work completed without MCDPS approval may result in the permittee having to remove and reconstruct the unapproved work. Upon completion of the project, a formal Stormwater Management As-Built must be submitted to MCDPS unless a Record Drawing Certification has been allowed instead. Each of the steps listed below must be verified by either the MCDPS Inspector OR the Owner/Developer.		
1. Excavation to subgrade conforms to approved plans		
2. Placement of backfill and observation well conforms to approved plans		
3. Placement of filter fabric, soil, and gravel media conforms to approved plans		
4. Construction of appurtenant conveyance structures conforms to approved plans		
5. Final grading and establishment of permanent stabilization conforms to approved plans		


TOTAL NUMBER OF LANDSCAPE INFILTRATION AREAS INSTALLED PER THIS PERMIT:

APPROVED _____ **CONSTRUCTED** _____

LANDSCAPE INFILTRATION 1	
SURFACE AREA REQUIRED (SF)	300
SURFACE AREA PROVIDED (SF)	
ESD VOLUME REQUIRED (CF)	510
ESD VOLUME PROVIDED (CF)	

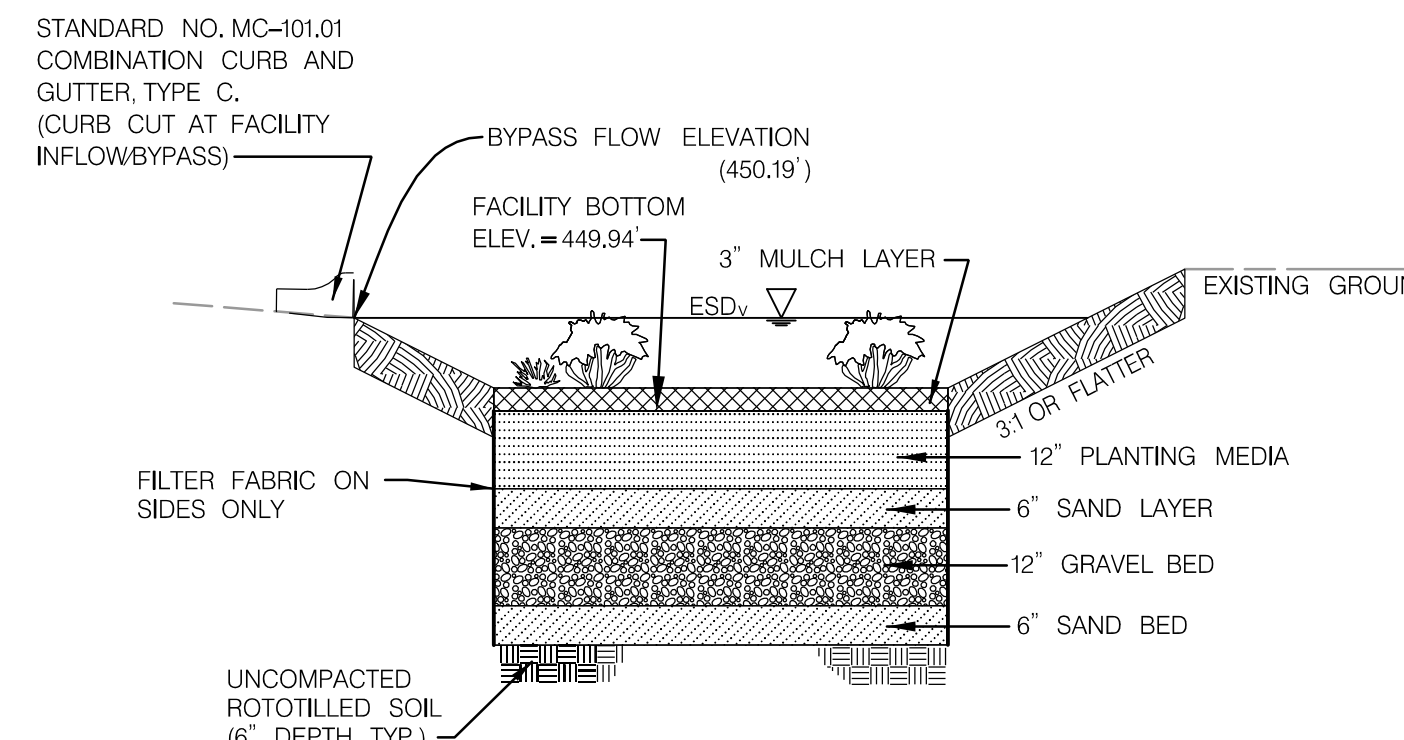


**LANDSCAPE INFILTRATION
 TYPICAL CROSS SECTION**
 NOT TO SCALE

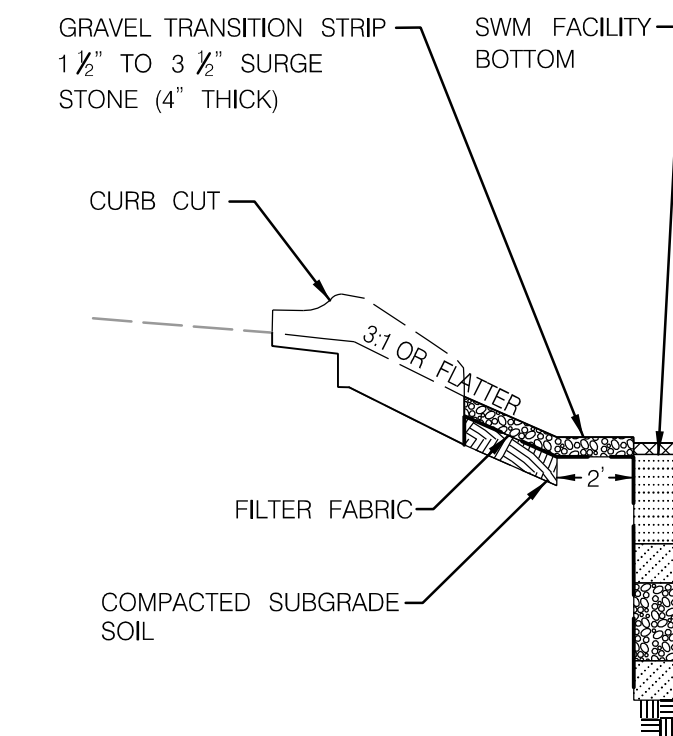

CURB CUT - TYPICAL STABILIZATION DETAIL
 NOT TO SCALE

**LANDSCAPE INFILTRATION
 SEQUENCE OF CONSTRUCTION**

1. PROTECT THE FACILITY FROM RECEIVING RUNOFF UNTIL THE INSTALLATION IS COMPLETE AND SURROUNDING AREAS HAVE BEEN STABILIZED (IF THE CURB CUT IS INSTALLED PRIOR TO COMPLETION OF THE FACILITY, INSTALL A SANDBAG DIVERSION TO DIVERT FLOW ALONG THE CURB AND GUTTER AS IT DOES UNDER EXISTING CONDITIONS.)
2. EXCAVATE THE FILTER BED AREA, ROTOTILL THE TOP 6 INCHES OF SUBGRADE SOIL.
3. INSTALL THE BOTTOM SAND BED LAYER, GRAVEL LAYER, AND UPPER SAND BED LAYER.
4. INSTALL THE PLANTING MEDIA.
5. INSTALL THE PLANTS AND MULCH LAYER ON THE FACILITY SURFACE AS INDICATED ON THE LANDSCAPING PLANS.

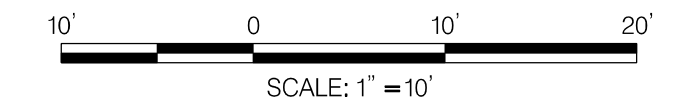

DEPARTMENT OF PERMITTING SERVICES
 Marc Elrich
 County Executive
 Diane R. Schwartz Jones
 Director

January 28, 2019

Mr. Keith Schiefer
 RJM Engineering, Inc.
 6031 University Boulevard, Suite 290
 Ellicott City, Md 21043

Re: **COMBINED STORMWATER MANAGEMENT
 CONCEPT/SITE DEVELOPMENT
 STORMWATER MANAGEMENT PLAN** for
 South Village Sidewalk
 Preliminary Plan #: N/A
 SM File #: 284408
 Tract Size/Zone: 1.43/R-20
 Total Concept Area: .27ac
 Lots/Block: N/A
 Parcel(s): A
 Watershed: Great Seneca Creek

Dear Mr. Schiefer,

Based on a review by the Department of Permitting Services Review Staff, the stormwater management concept for the above-mentioned site is **acceptable**. The stormwater management concept proposes to meet required stormwater management goals via the use of landscape infiltration.

The following items will need to be addressed during the detailed sediment control/stormwater management plan stage:

1. A detailed review of the stormwater management computations will occur at the time of detailed plan review.
2. An engineered sediment control plan must be submitted for this development.
3. All filtration media for manufactured best management practices, whether for new development or redevelopment, must consist of MDE approved material.
4. A stormwater management waiver fee will **not** be required for this community improvement project. The stormwater management volume provided exceeds the volume that would be required for the net increase of impervious area.

This list may not be all-inclusive and may change based on available information at the time.

This letter must appear on the sediment control/stormwater management plan at its initial submittal. The concept approval is based on all stormwater management structures being located outside of the Public Utility Easement, the Public Improvement Easement, and the Public Right of Way unless specifically approved on the concept plan. Any divergence from the information provided to this office; or additional information received during the development process; or a change in an applicable

SAND SPECIFICATIONS

Washed ASTM C33 Fine Aggregate Concrete Sand is utilized for stormwater management applications in Montgomery County. In addition to the ASTM C33 specification, sand must meet ALL of the following conditions:

1. Sand must meet gradation requirements for ASTM C-33 Fine Aggregate Concrete Sand. AASHTO M-6 gradation is also acceptable.
2. Sand must be silica based. No limestone based products may be used. If the material is white or gray in color, it is probably not acceptable.
3. Sand must be clean. Natural, unwashed sand deposits may not be used. Likewise, sand that has become contaminated by improper storage or installation practices will be rejected.
4. Manufactured sand or stone dust is not acceptable under any circumstance.

PLANTING MEDIA SPECIFICATIONS

The planting media shall be 24 inches thick and shall consist of 1/3 perlite or Solite, 1/3 compost and 1/3 topsoil.

1. The perlite shall be coarse grade horticultural perlite.
2. The compost shall be high grade compost free of stones and partially composted woody material.
3. The topsoil shall meet the following minimum criteria: contain no more than 10% clay, 10-25% silts and 60-75% sand. The soil shall be free of stones, stumps, roots or other similar objects larger than 2 inches.
4. The first layer of the planting medium shall be lightly filled to mix it into the sand layer, so as not to create a definitive boundary.
5. The planting material shall be flocced after placement. Any settlement that occurs shall be filled back to the design elevation.


MONTGOMERY COUNTY
 DEPARTMENT OF HOUSING AND COMMUNITY AFFAIRS
 MONTGOMERY VILLAGE /SOUTH VILLAGE HOMES
 LIGHTING AND SITE IMPROVEMENTS PROJECT

GROVER'S FORGE - STORMWATER MANAGEMENT PLAN



SCALE AS NOTED ADVERTISED DATE TBD CONTRACT NO. _____

DESIGNED BY _____ COUNTY MONTGOMERY COUNTY
 DRAWN BY _____ LOGMILE _____
 CHECKED BY _____
 DPS PERMIT 284408

DRAWING NO. **SW-01** OF **01** SHEET NO. 39 OF 46

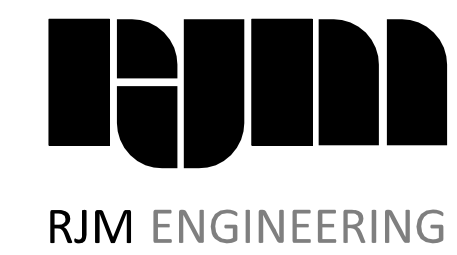

BY: Kevin

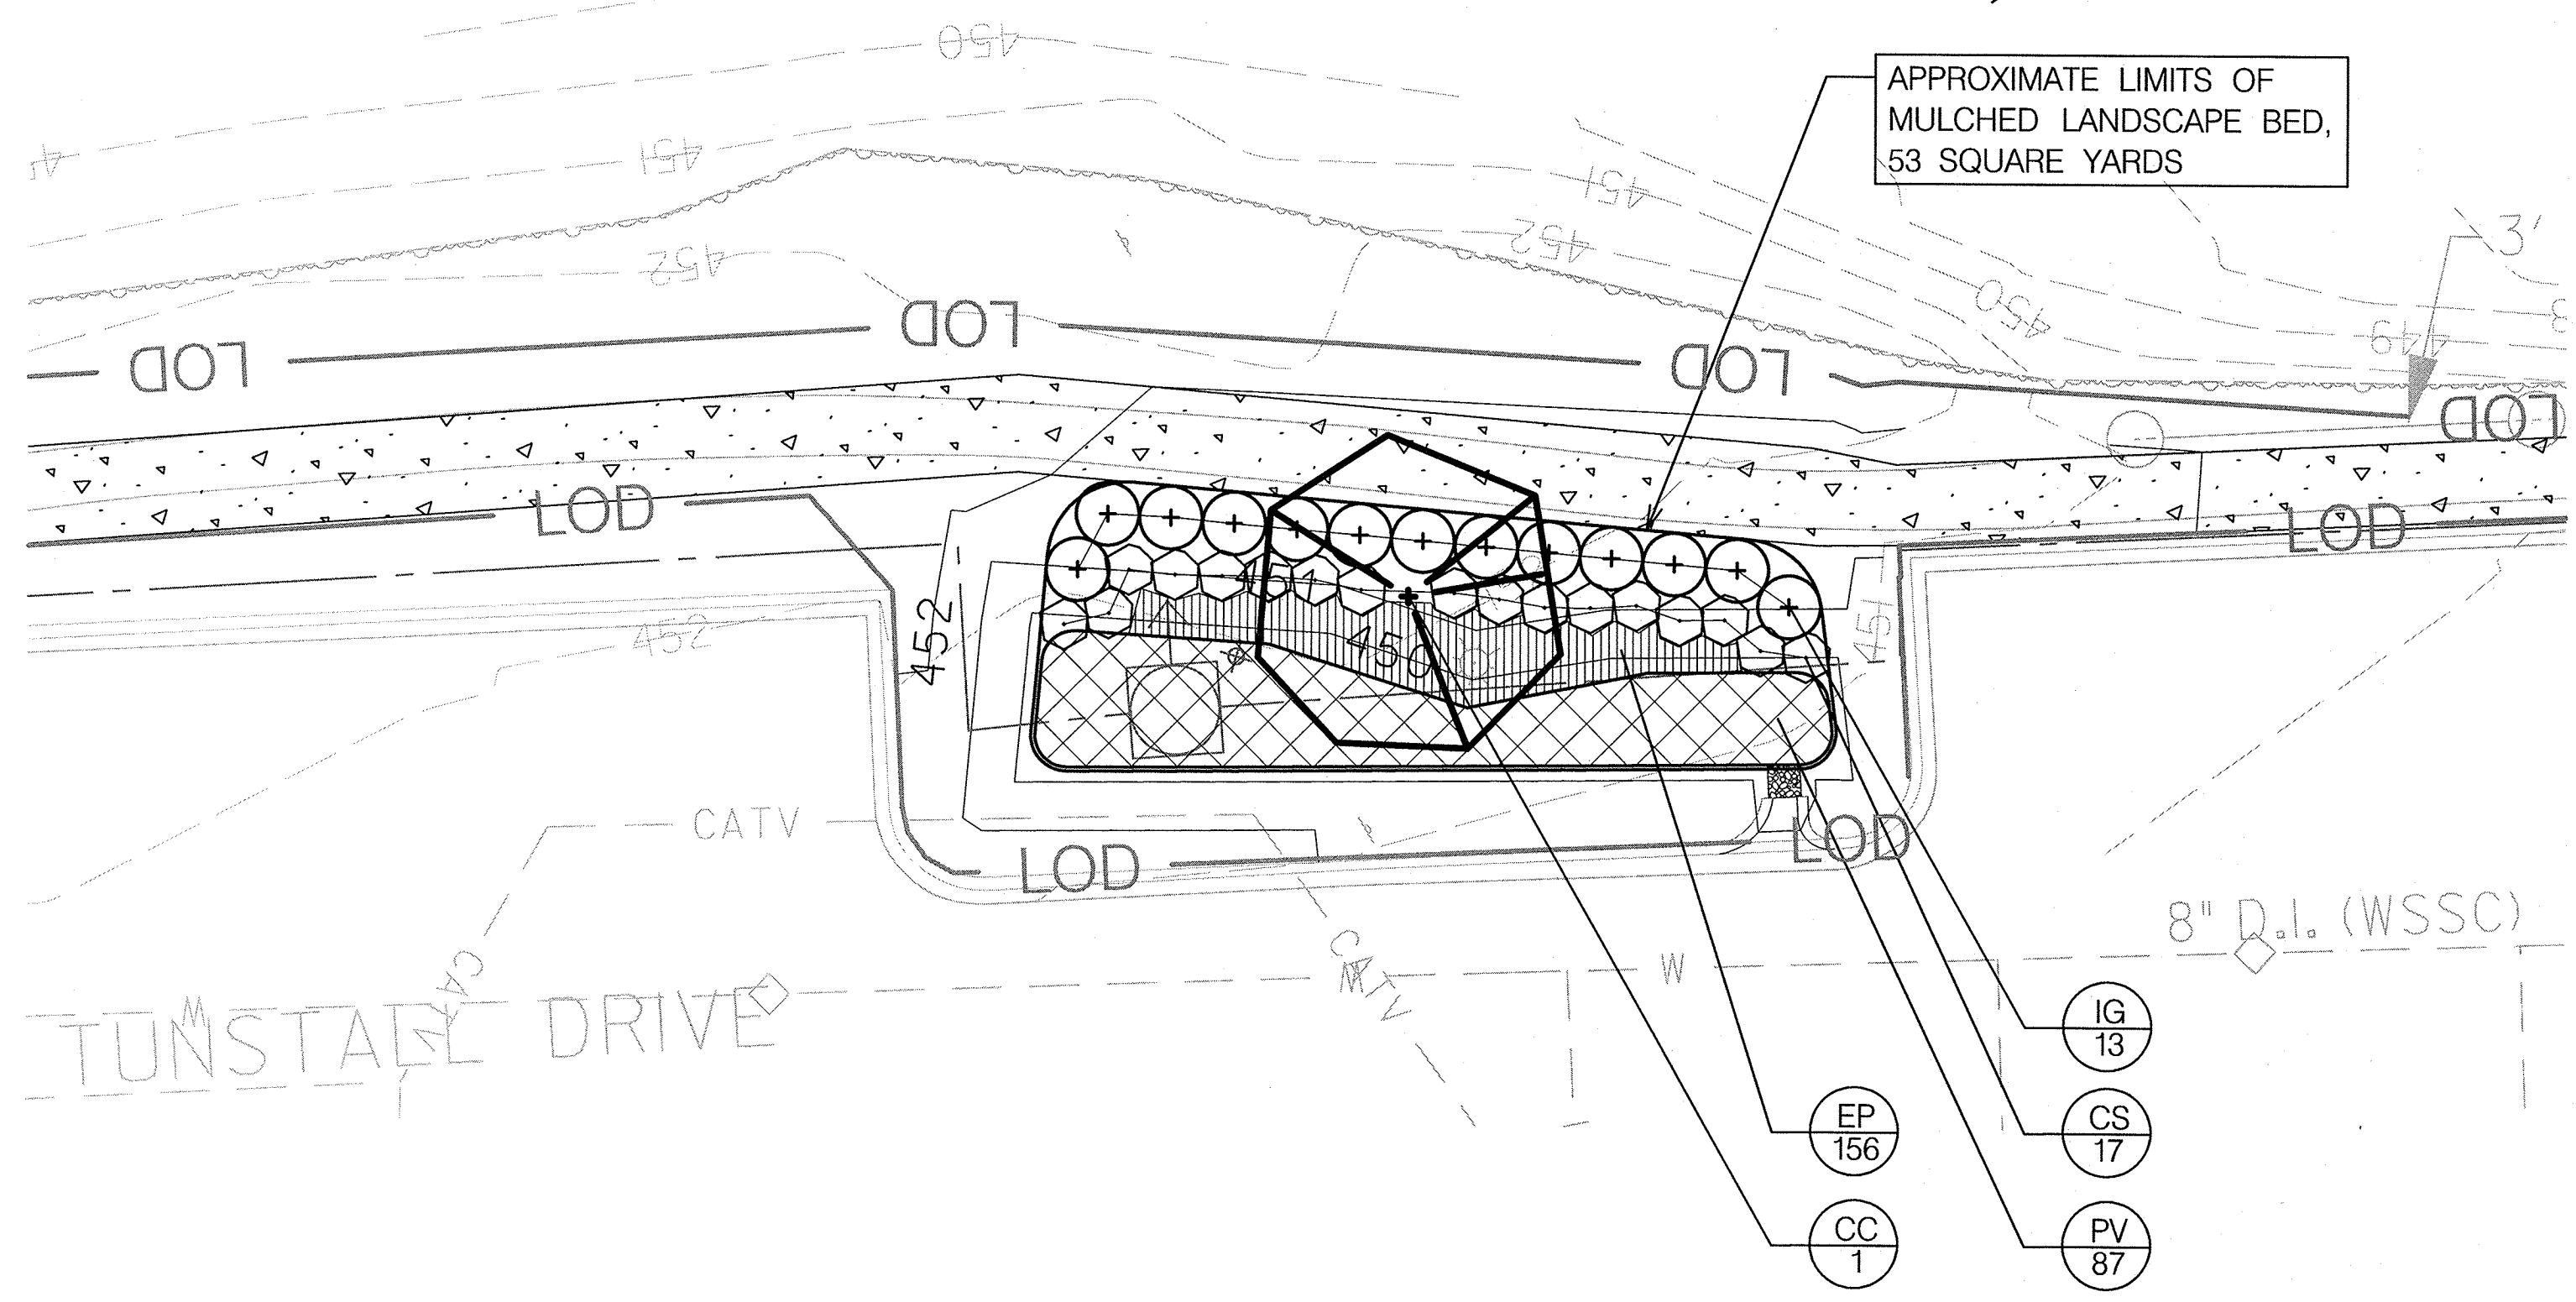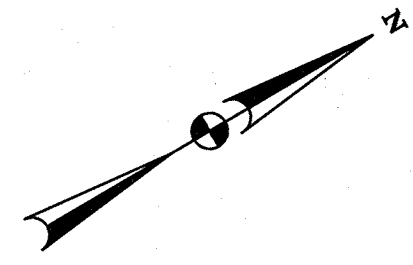

LANDSCAPE PLAN VIEW
 1" = 10'

ALL PRUNING SHALL BE DONE BY AN I.S.A. CERTIFIED ARBORIST OR UNDER THE DIRECTION OF. DO NOT HEAVILY PRUNE TREES AT PLANTING.


ALL DEAD, BROKEN, AND CROSSING BRANCHES SHALL BE PRUNED OFF FOLLOWING INSTALLATION.

NOTCH STAKES 12" FROM TOP OF STAKE TO HOLD WIRE IN PLACE. WIRE 5' ABOVE GRADE.

2 ea. - 2" x 2" x 8' HARDWOOD STAKES SPACED 180" APART. PLACE STAKES PARALLEL TO SIDEWALK AND 5" - 8" FROM ROOT BALL.

ROOT COLLAR SHALL BE PLACED 1" - 2" ABOVE FINISHED GRADE. PLANT TREES SUCH THAT THE TRUNK FLARE IS VISIBLE. DO NOT COVER TOP OF ROOT BALL WITH SOIL.

REMOVE BURLAP AND ROPE FROM TOP 1/3 OF ROOT BALL FOR TREES. REMOVE WIRE BASKETS ENTIRELY.

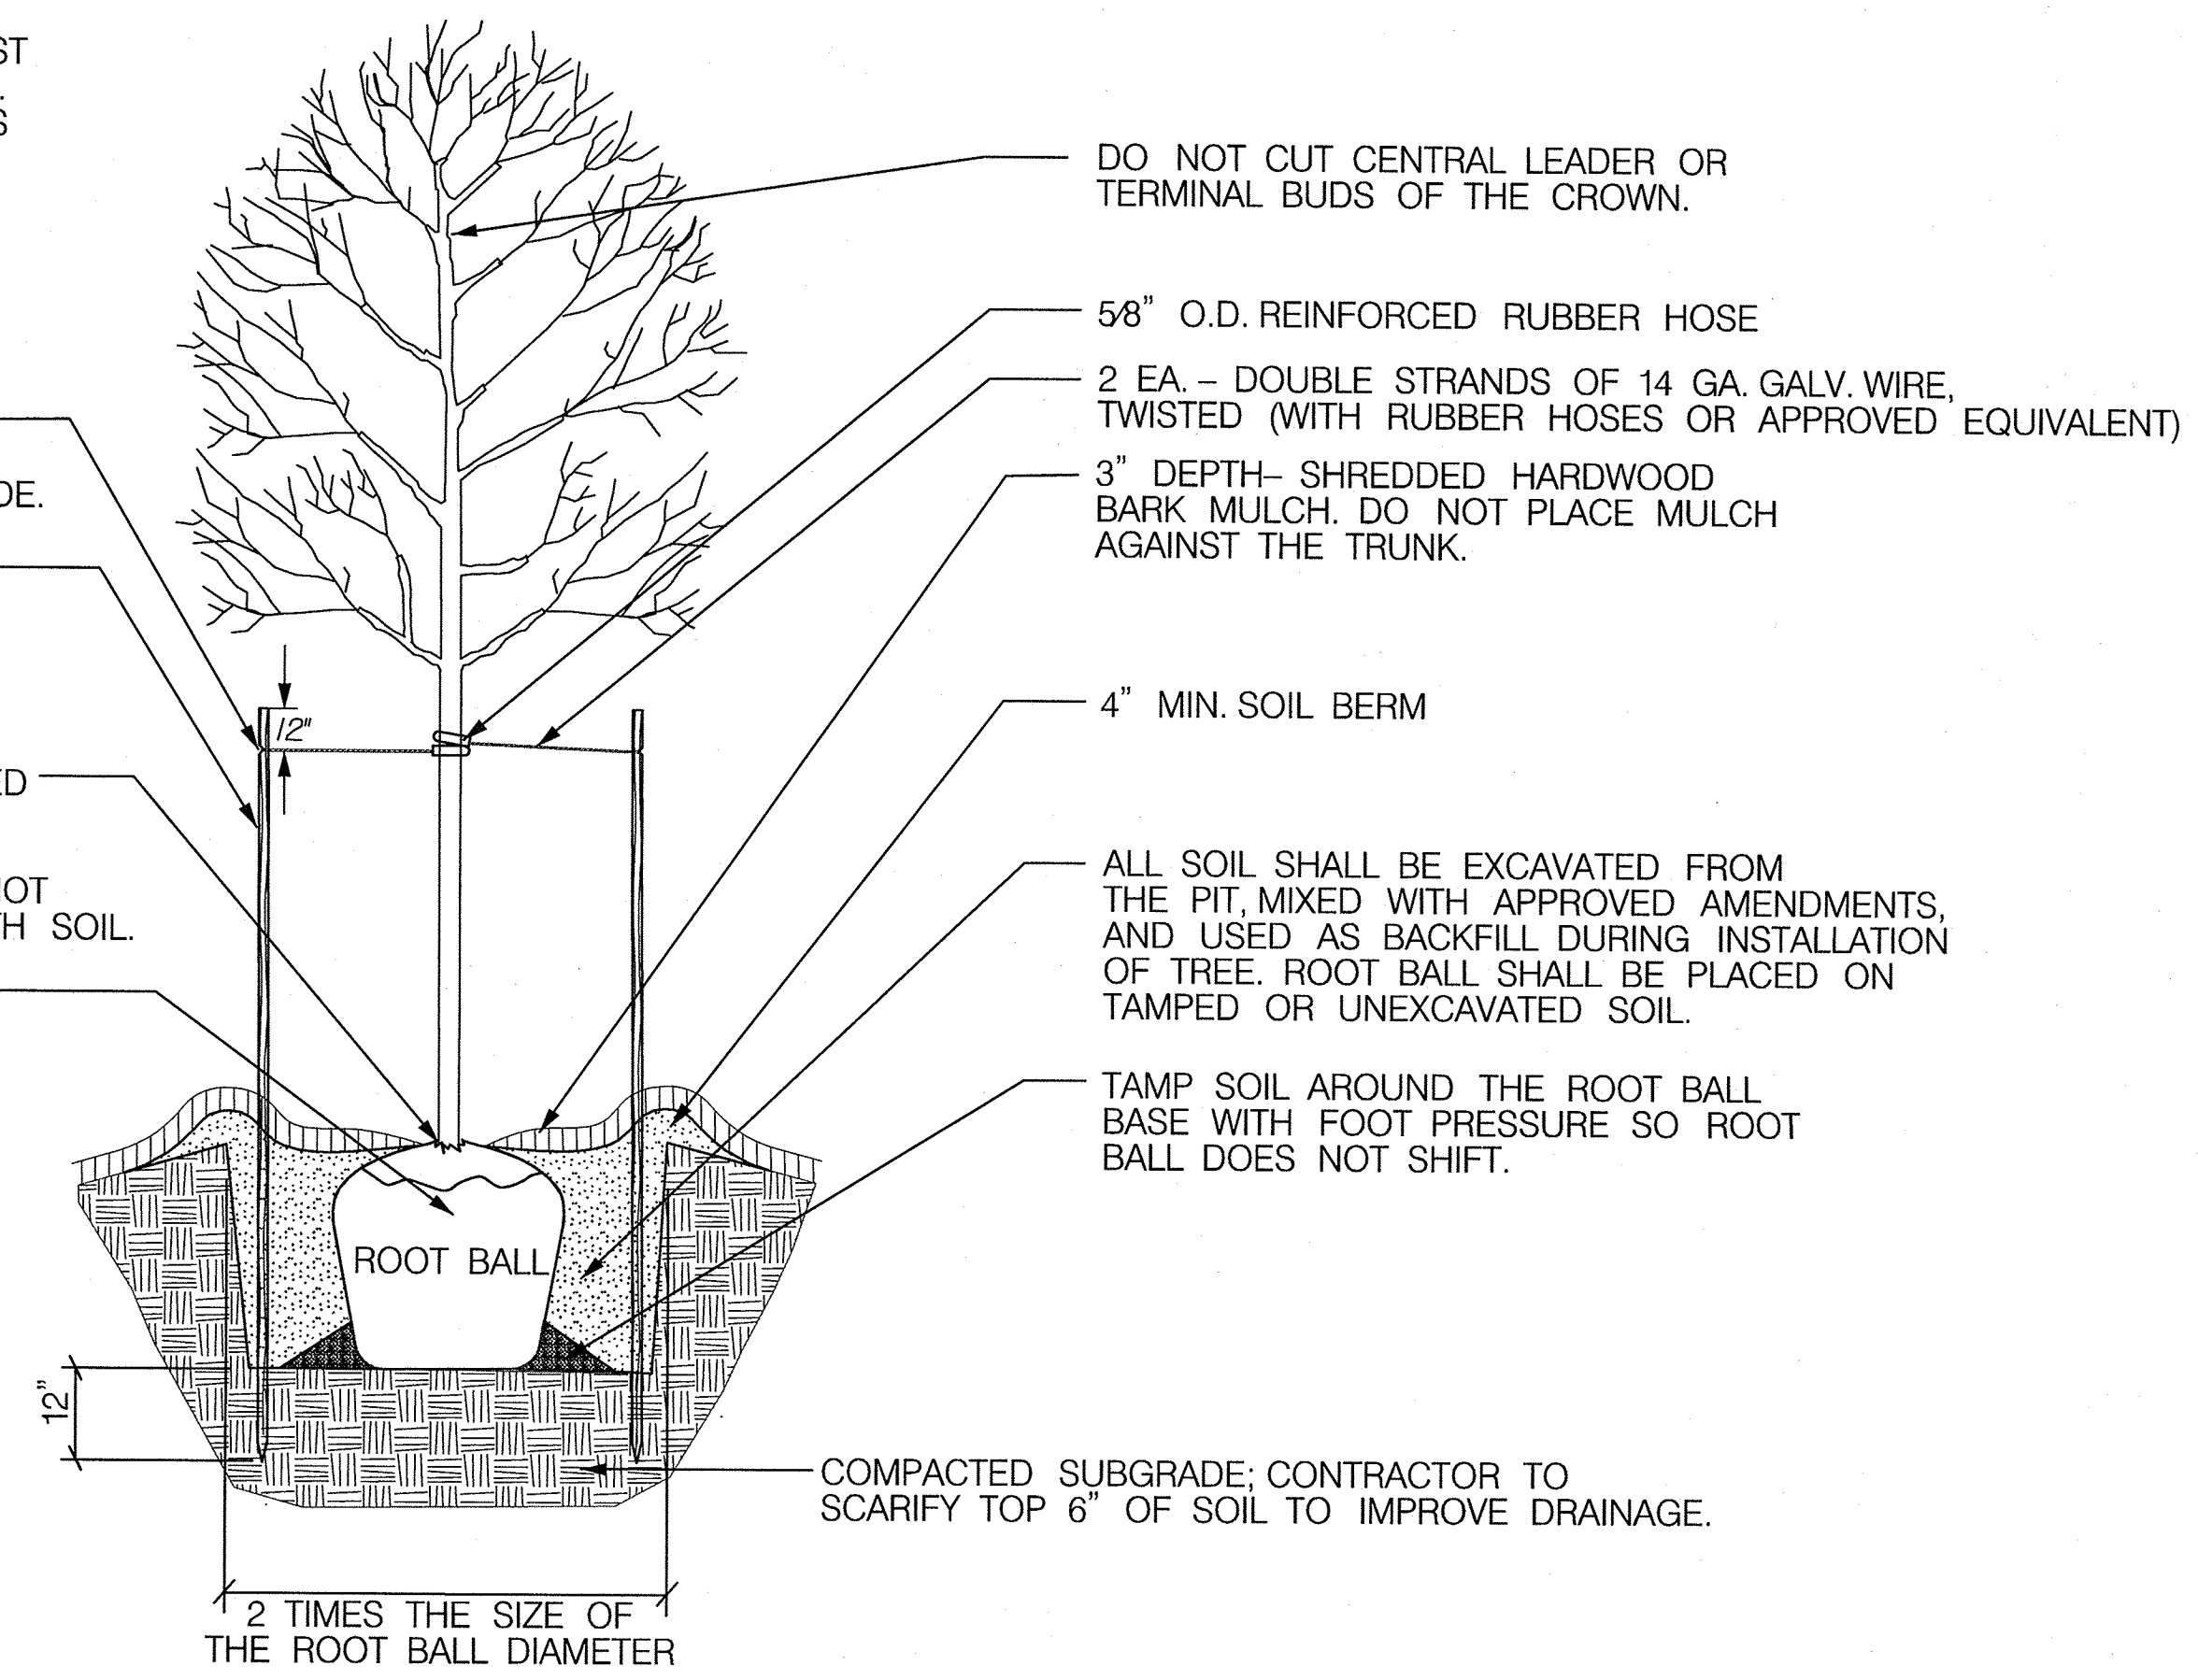

TREE PLANTING DETAIL
 N.T.S.


PLANTING SCHEDULE [TOTAL]							
	KEY	QTY.	BOTANICAL NAME	COMMON NAME	SIZE	ROOT	SPACING/REMARKS
TREES	CC	1	<i>Cercis canadensis</i> 'Forest Pansy'	'Forest Pansy' Eastern Redbud	2" CAL.	B&B/#20 CONT.	as shown
SHRUBS	CS	17	<i>Cornus sericea</i> 'Farrow' ARCTIC FIRE	Red Twig Dogwood	18" HT.	#3 CONT.	3' o.c.
	IG	13	<i>Ilex glabra</i> 'Shamrock'	'Shamrock' Inkberry Holly	24" HT.	#3 CONT.	4' o.c.
ORNAMENTAL GRASSES / PERENNIALS	EP	156	<i>Echinacea purpurea</i>	Purple Coneflower	#SP4	CONT.	12" o.c.
	PV	87	<i>Panicum virgatum</i> 'Shenandoah'	'Shenandoah' Red Switchgrass	#1	CONT.	2' o.c.

3" DEPTH- SHREDDED HARDWOOD BARK MULCH. DO NOT PLACE MULCH AGAINST THE SHRUB STEM.


4" MIN. SOIL BERM

ALL SOIL SHALL BE EXCAVATED FROM THE PIT, MIXED WITH APPROVED AMENDMENTS AND USED AS BACKFILL DURING INSTALLATION OF THE SHRUB. ROOT BALL SHALL BE PLACED ON TAMPED OR UNEXCAVATED SOIL.

FOR CONTAINER PLANTS COMPLETELY REMOVE CONTAINER AND SCARIFY ROOTBALL

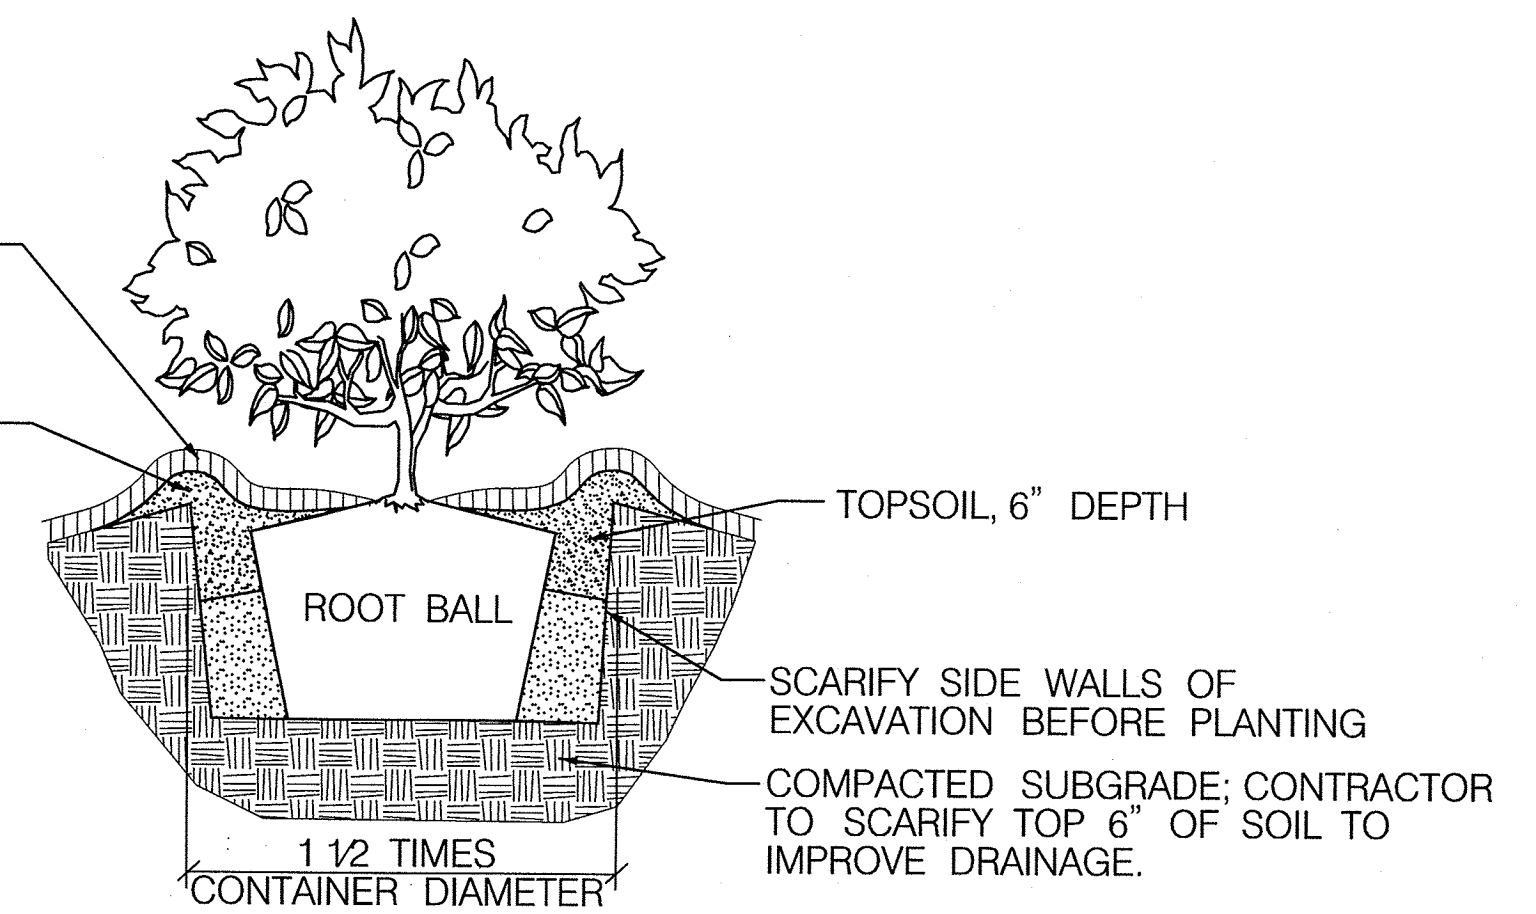

SHRUB PLANTING DETAIL
 N.T.S.

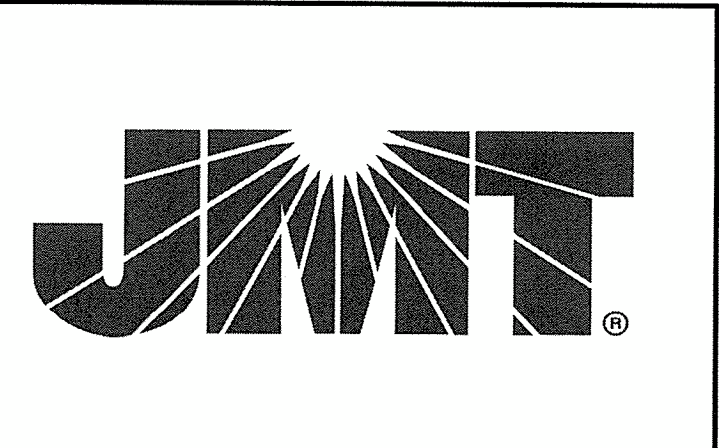

Scott Rasmussen
 2019.08.19.18.08.18.04.07









MONTGOMERY COUNTY
 DEPARTMENT OF HOUSING AND COMMUNITY AFFAIRS
 MONTGOMERY VILLAGE /SOUTH VILLAGE HOMES
 LIGHTING AND SITE IMPROVEMENTS PROJECT

GROVER'S FORGE - LANDSCAPE PLAN

SCALE AS SHOWN ADVERTISED DATE N/A CONTRACT NO. _____

DESIGNED BY SJR COUNTY MONTGOMERY COUNTY
 DRAWN BY SJR LOGMILE _____
 CHECKED BY JSC
 DPS PERMIT 284408

DRAWING NO. **LS - 01** OF **01** SHEET NO. 41 OF 46

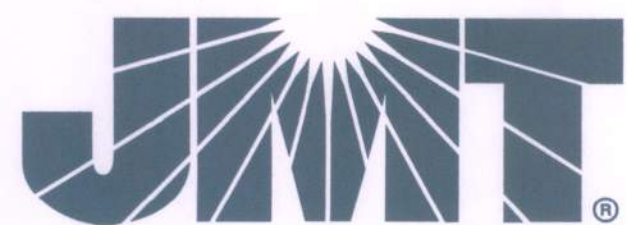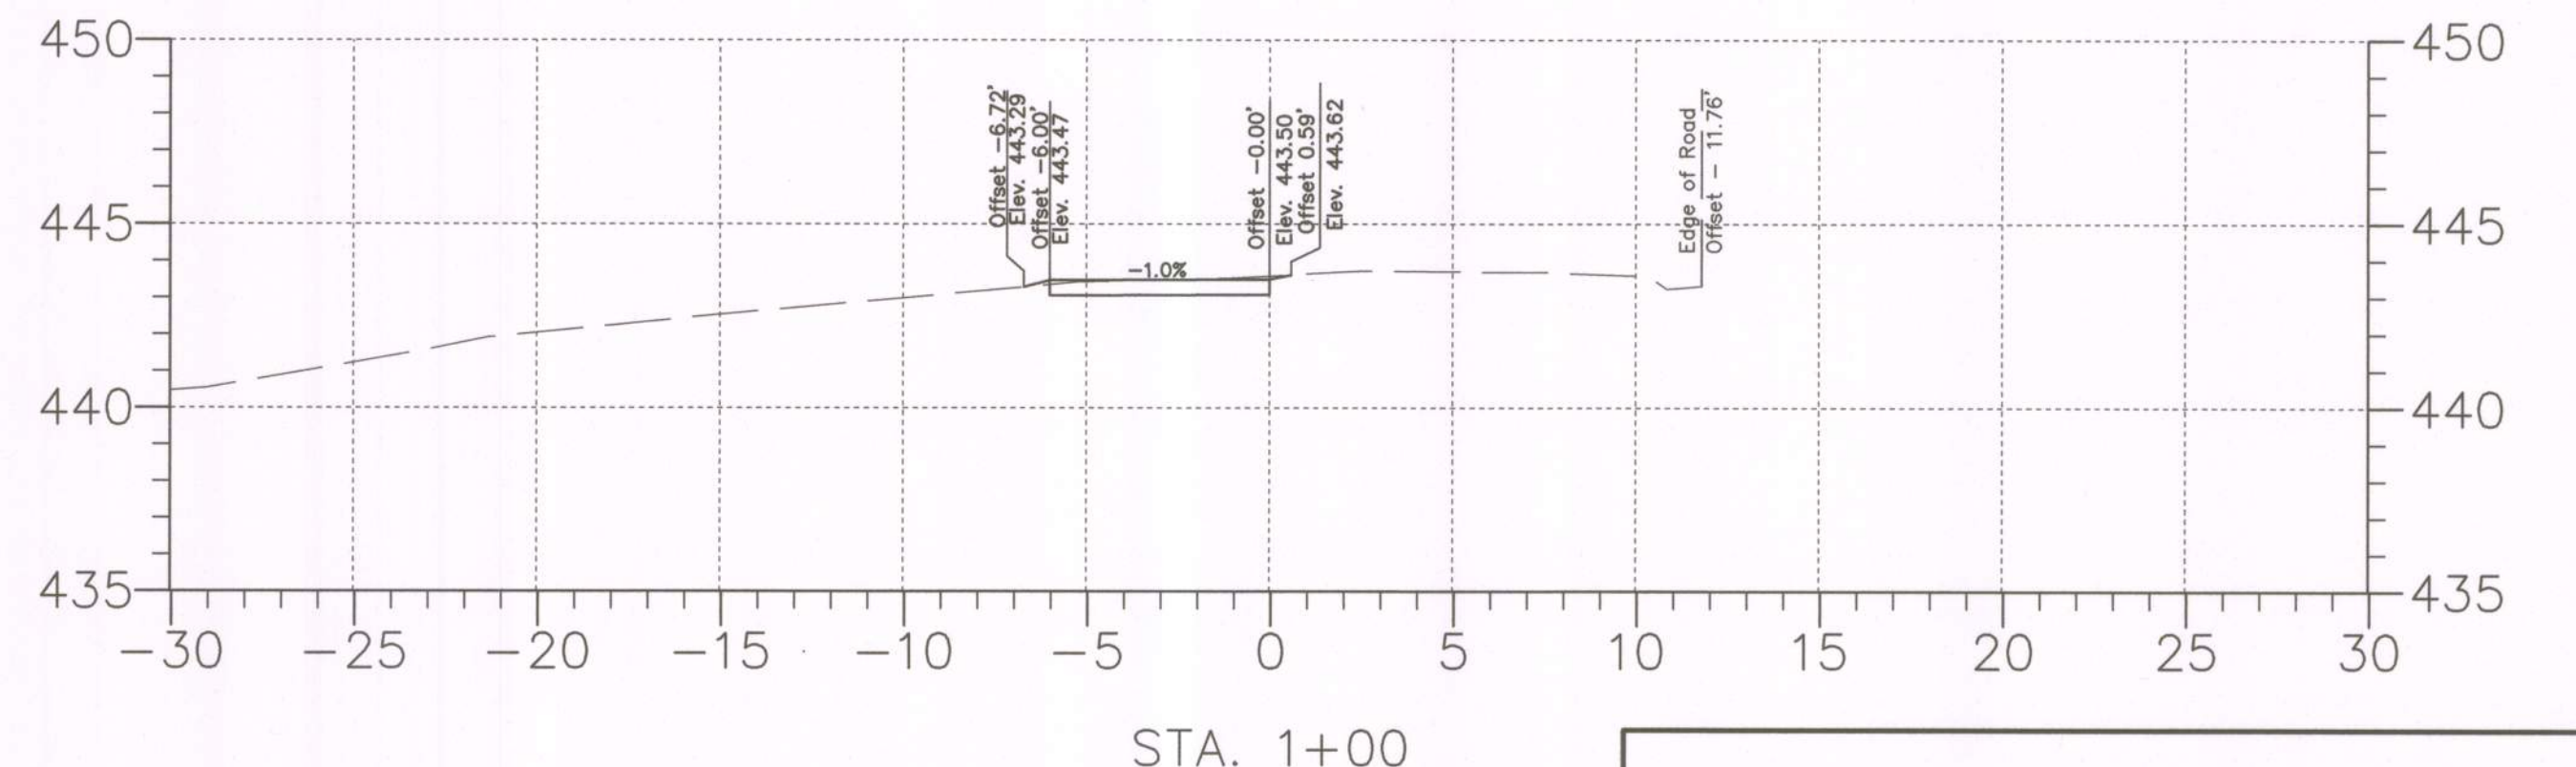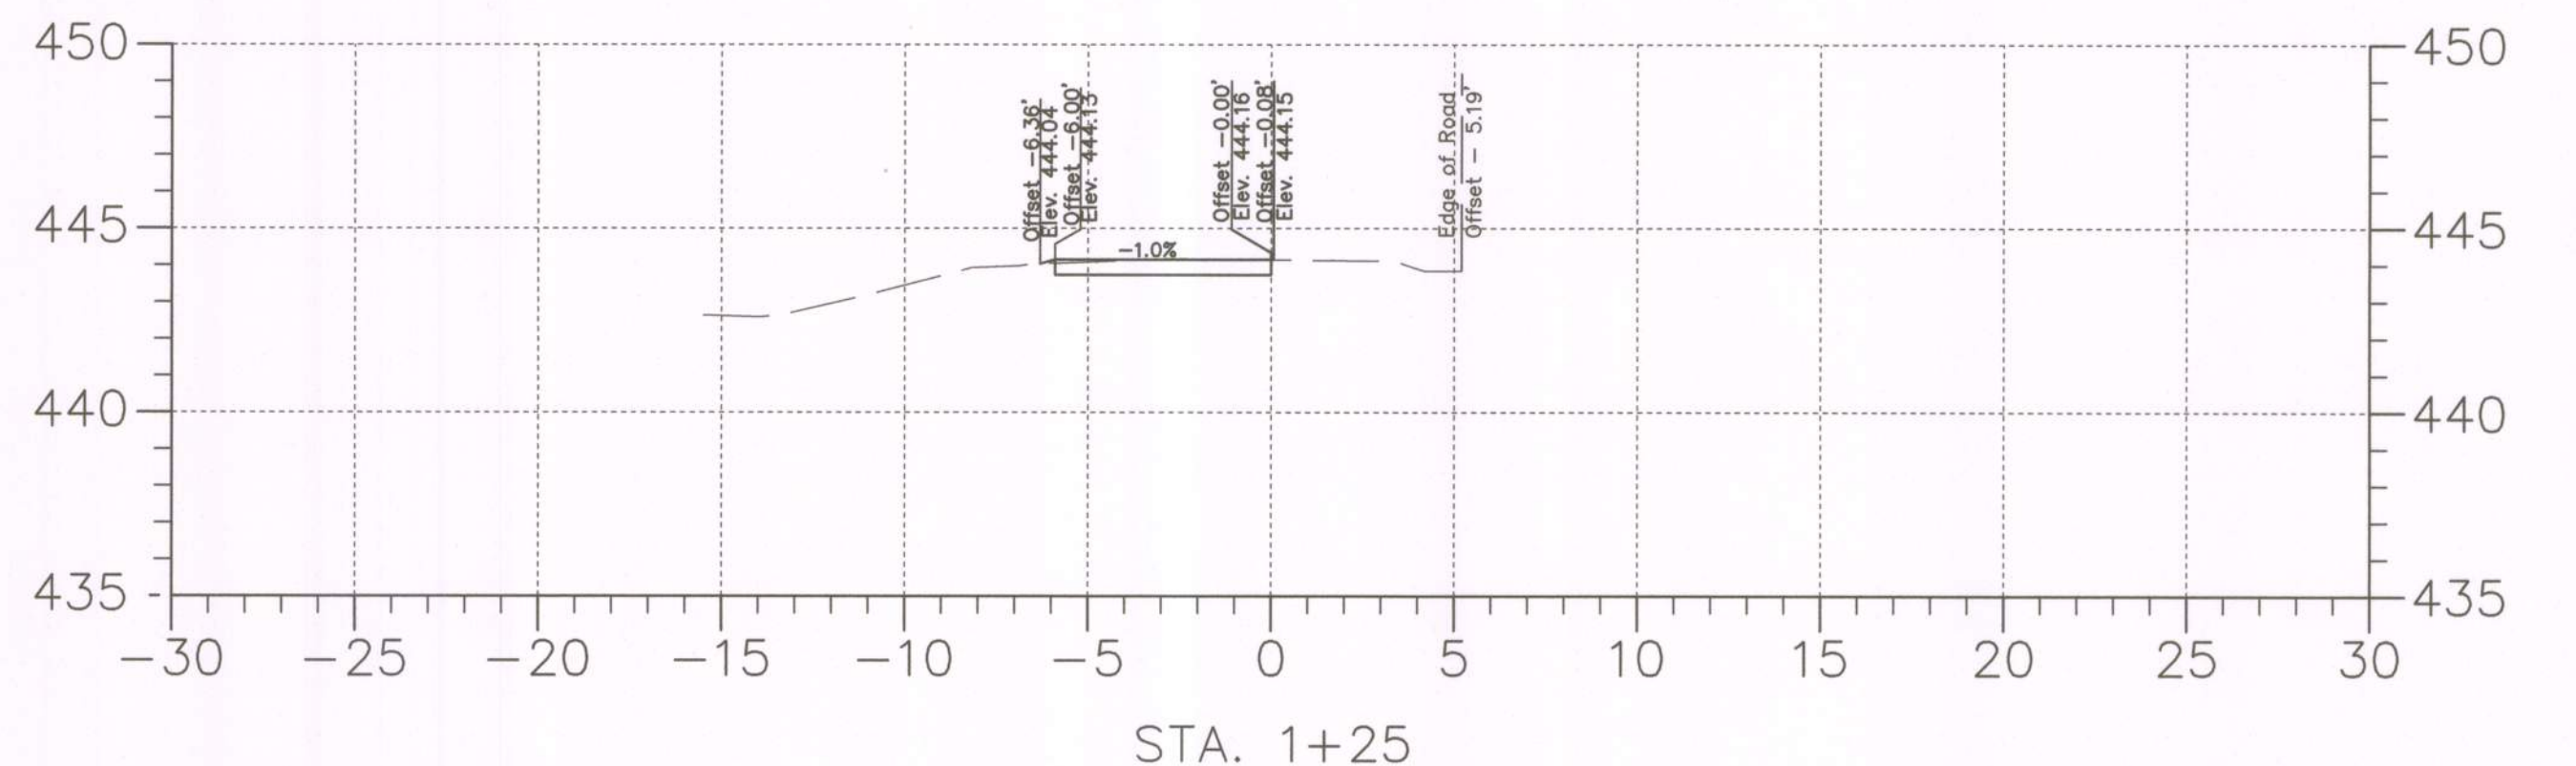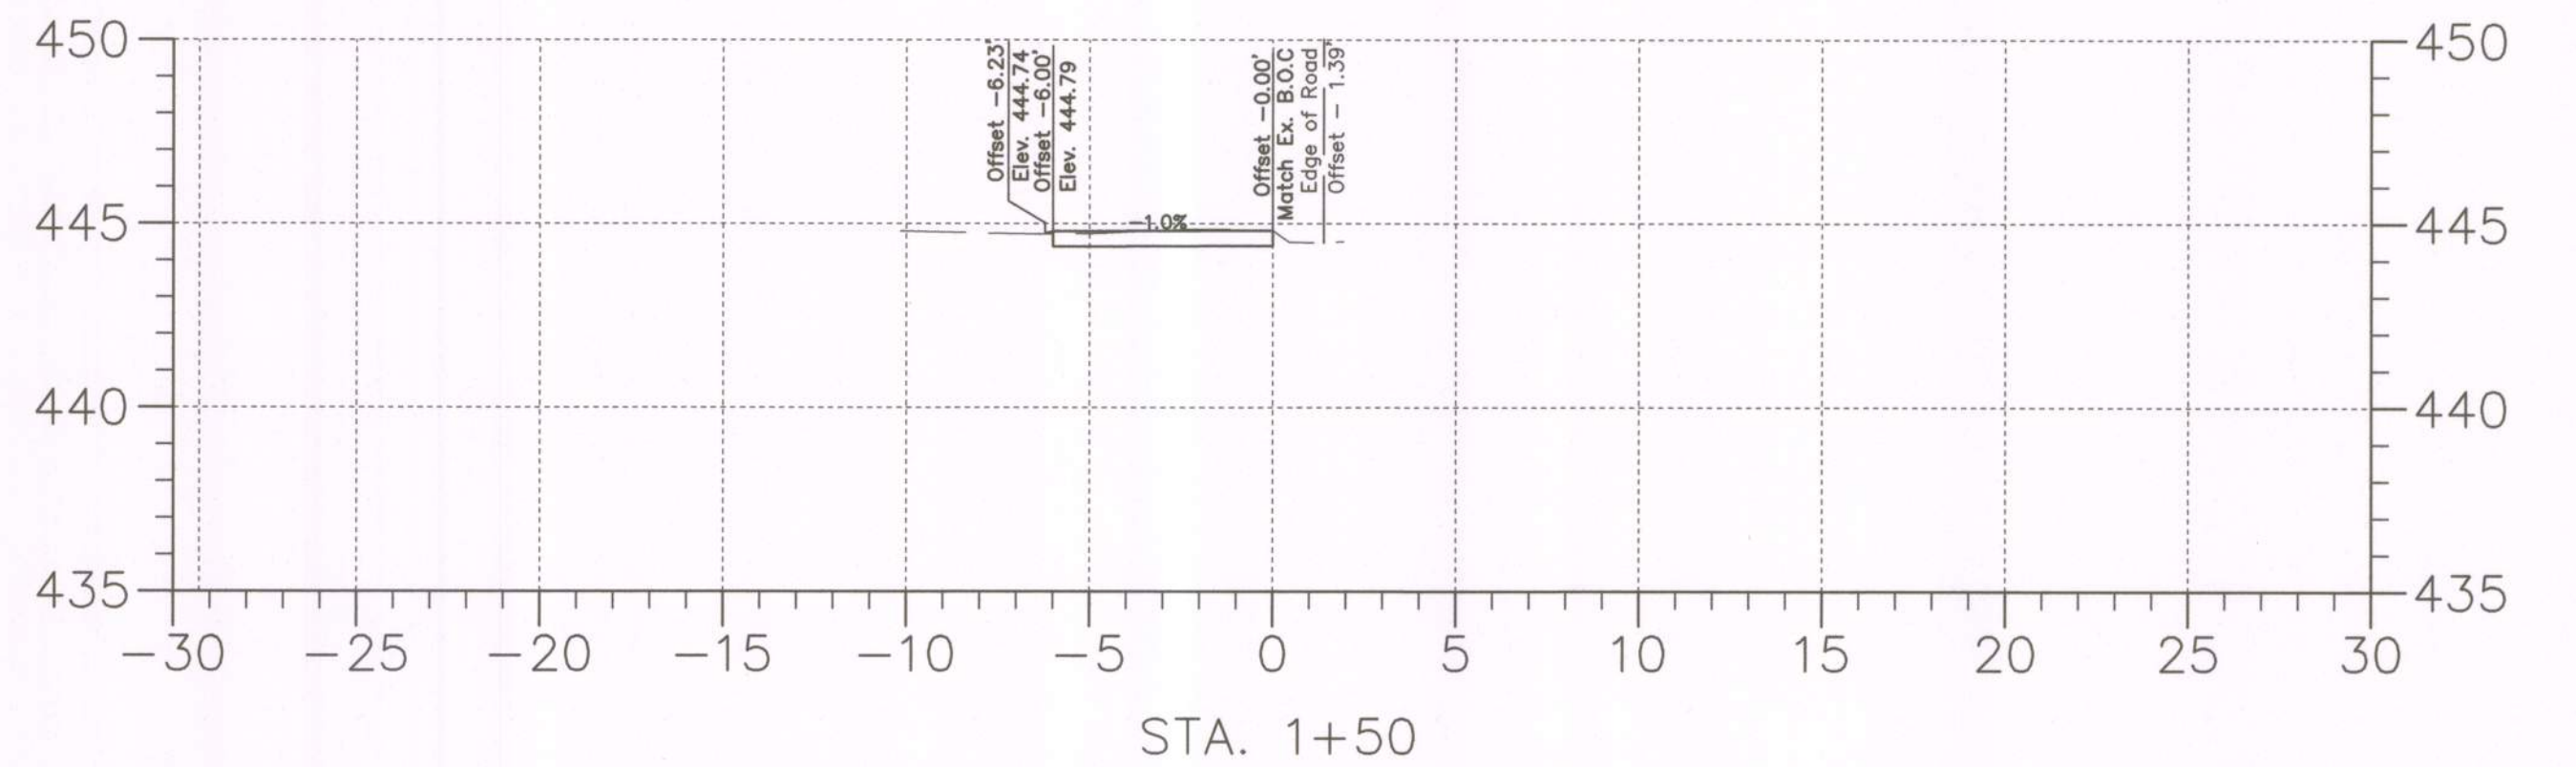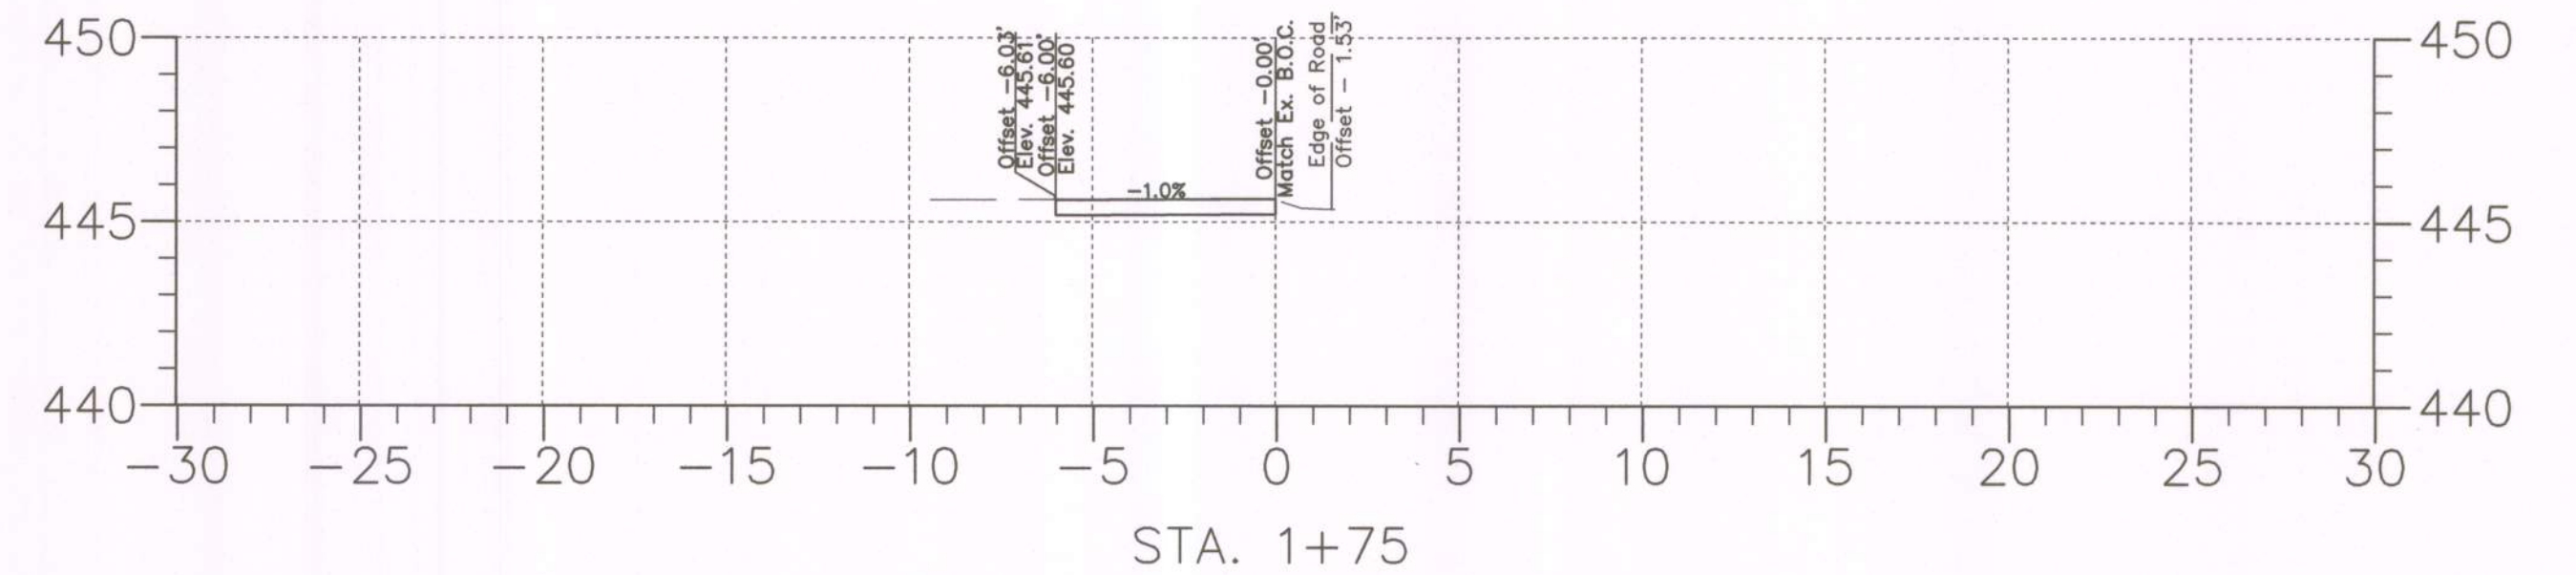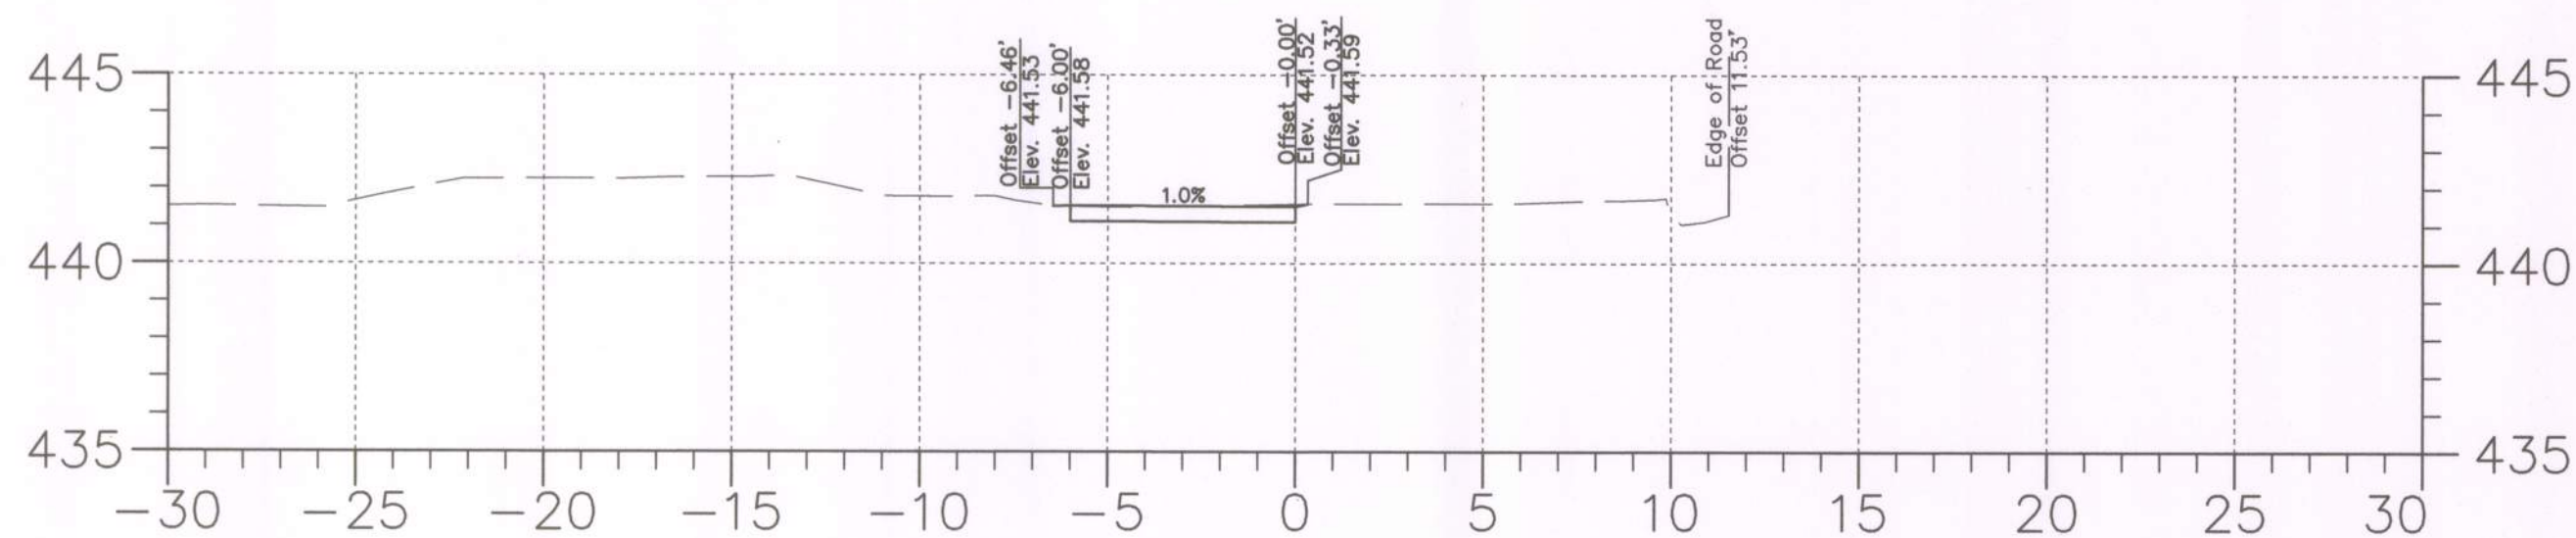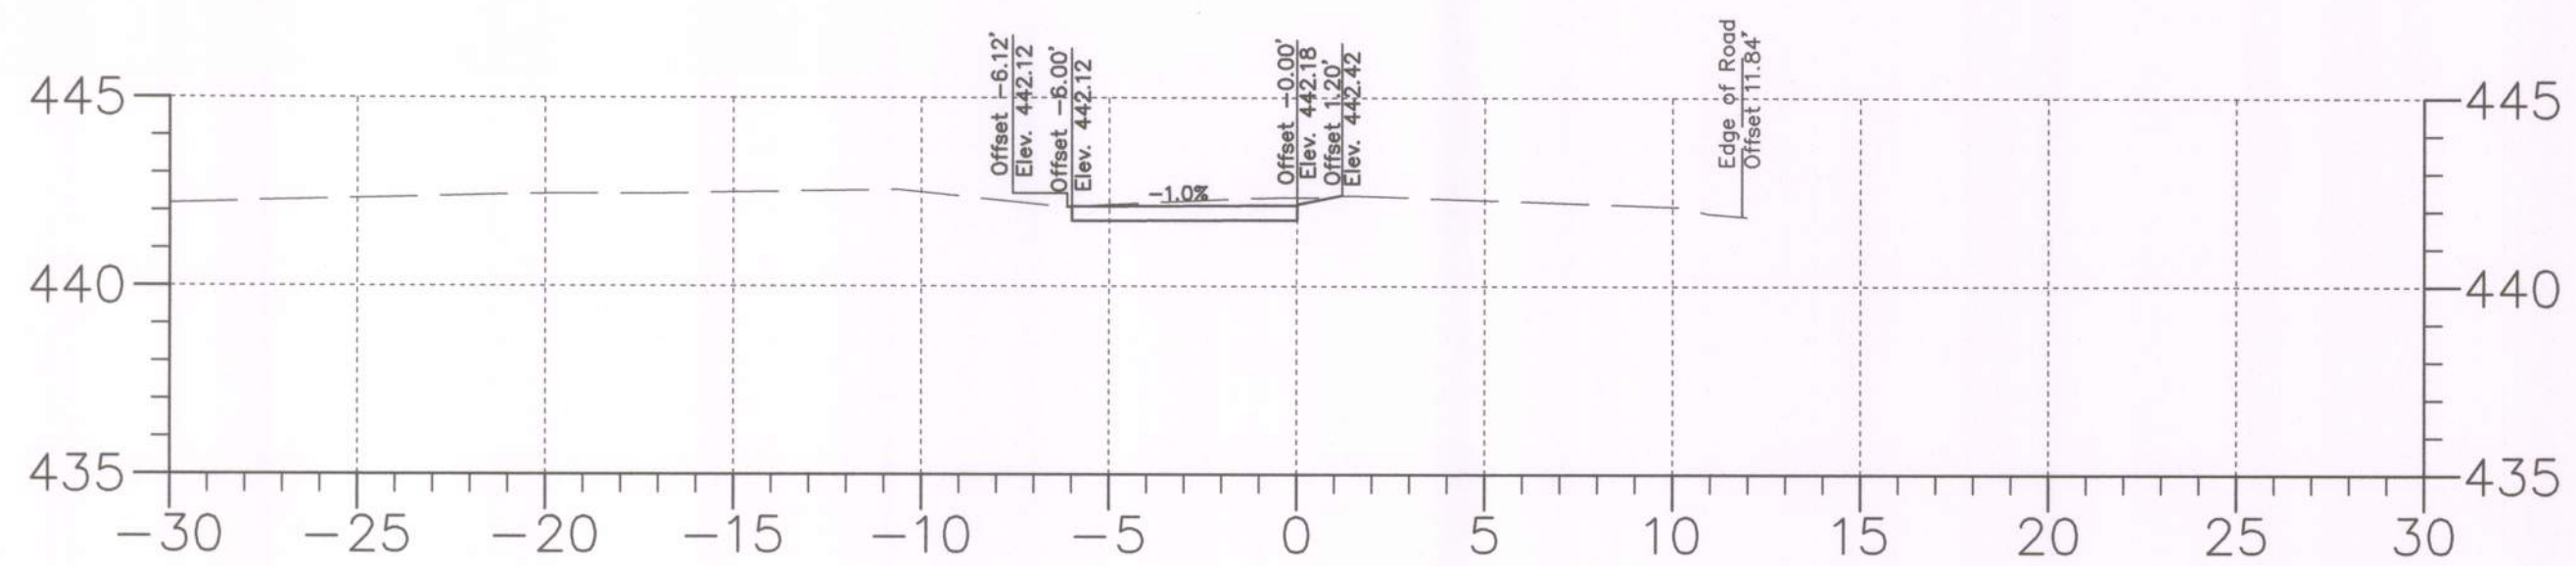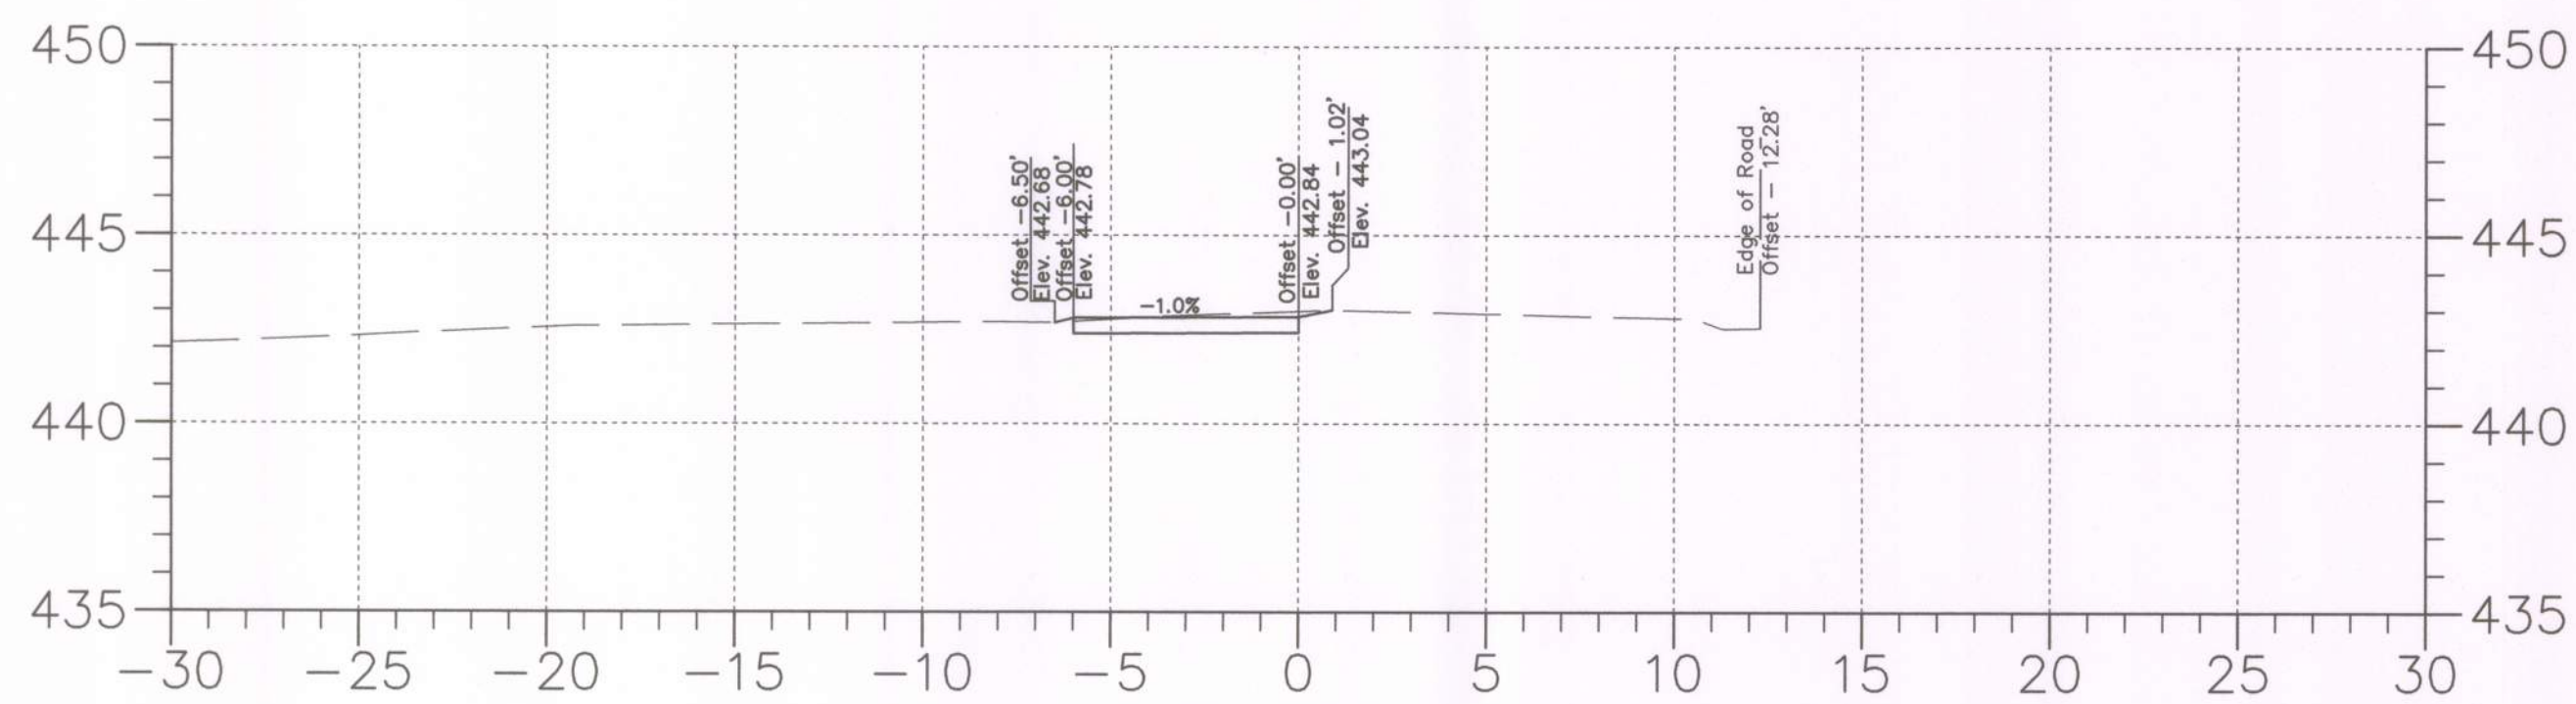


BY: Stratmeyer

PLOTTED: Friday, May 24, 2019 AT 02:09 PM
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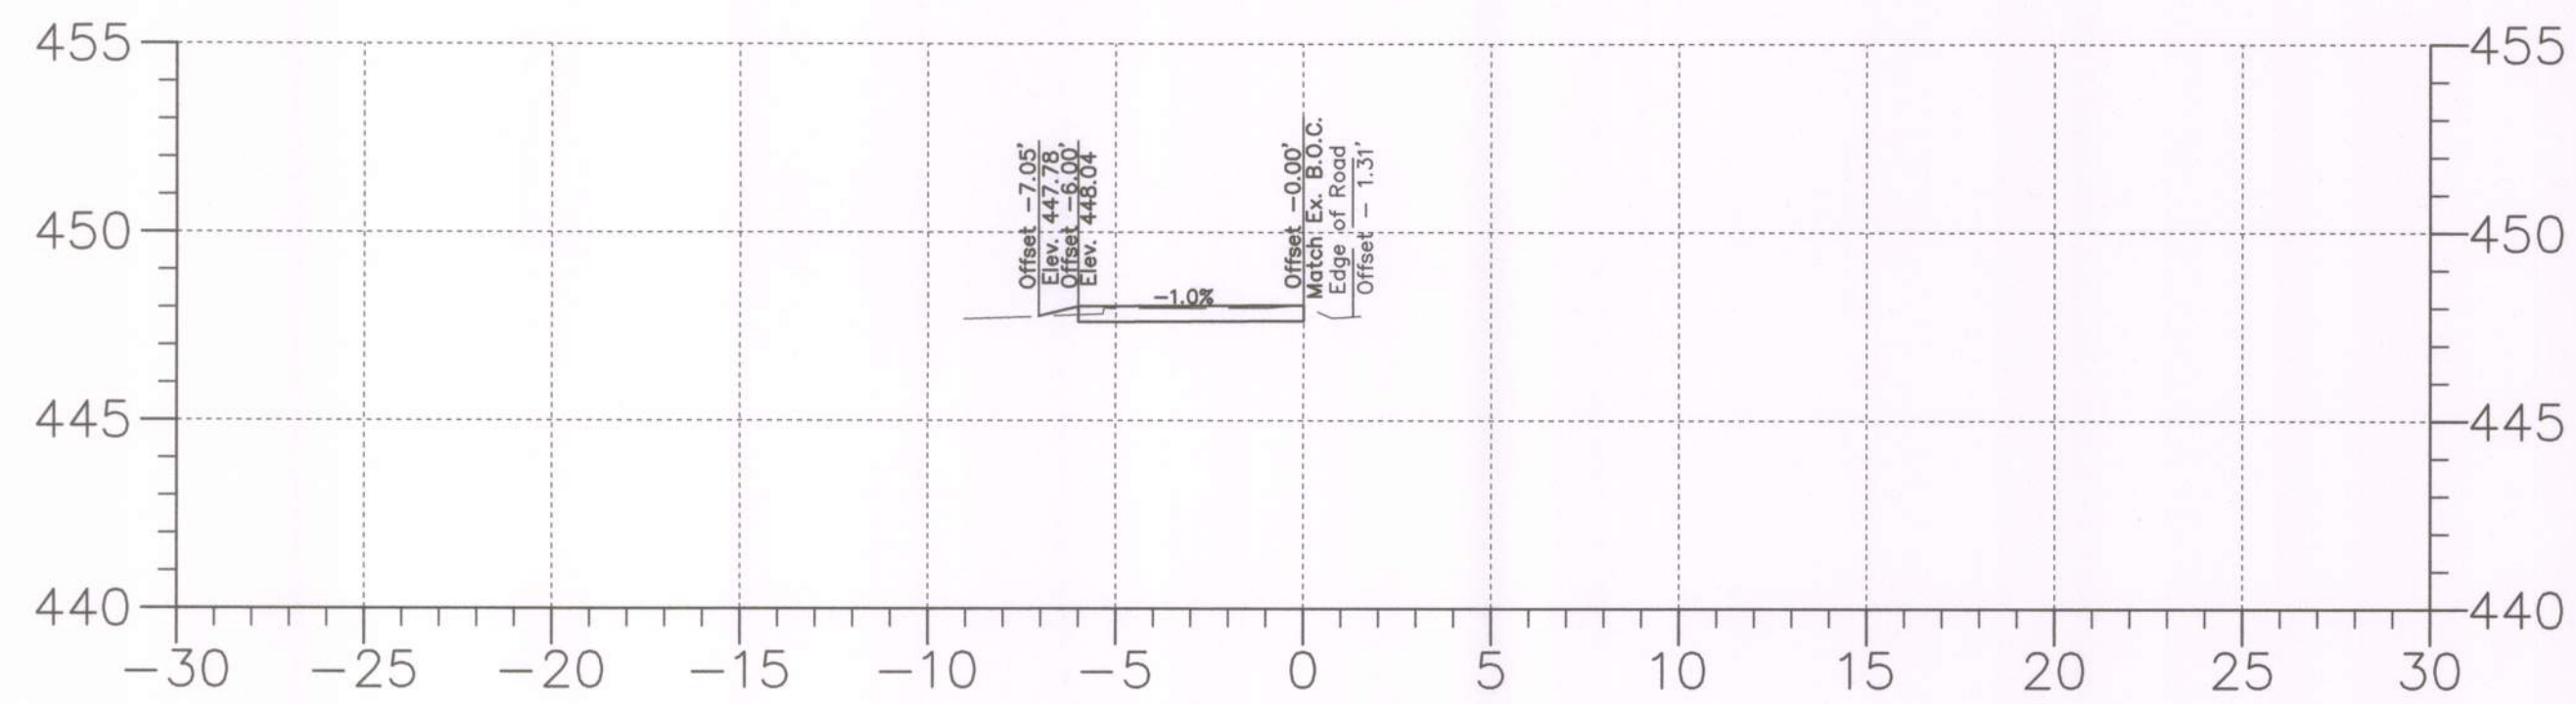


PROFESSIONAL CERTIFICATION
 I HEREBY CERTIFY THAT THESE DOCUMENTS WERE PREPARED OR APPROVED BY ME, AND THAT I AM A DULY LICENSED PROFESSIONAL ENGINEER UNDER THE STATE LAWS OF THE STATE OF MARYLAND, LICENSE NO. 17673, EXPIRATION DATE: 01/29/2020.
 DOUGLAS H. SIMMONS, PE


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MONTGOMERY VILLAGE / SOUTH VILLAGE HOMES LIGHTING AND SITE IMPROVEMENTS PROJECT	
GROVER'S FORGE - CROSS SECTIONS	
SCALE: 5 SCALE ADVERTISED DATE: N/A CONTRACT NO. _____	
DESIGNED BY: RJS	COUNTY: MONTGOMERY COUNTY
DRAWN BY: RJS	LOGMILE: _____
CHECKED BY: JJR	
DPS PERMIT: _____	
DRAWING NO. XS-01 OF 05	SHEET NO. 42 OF 46

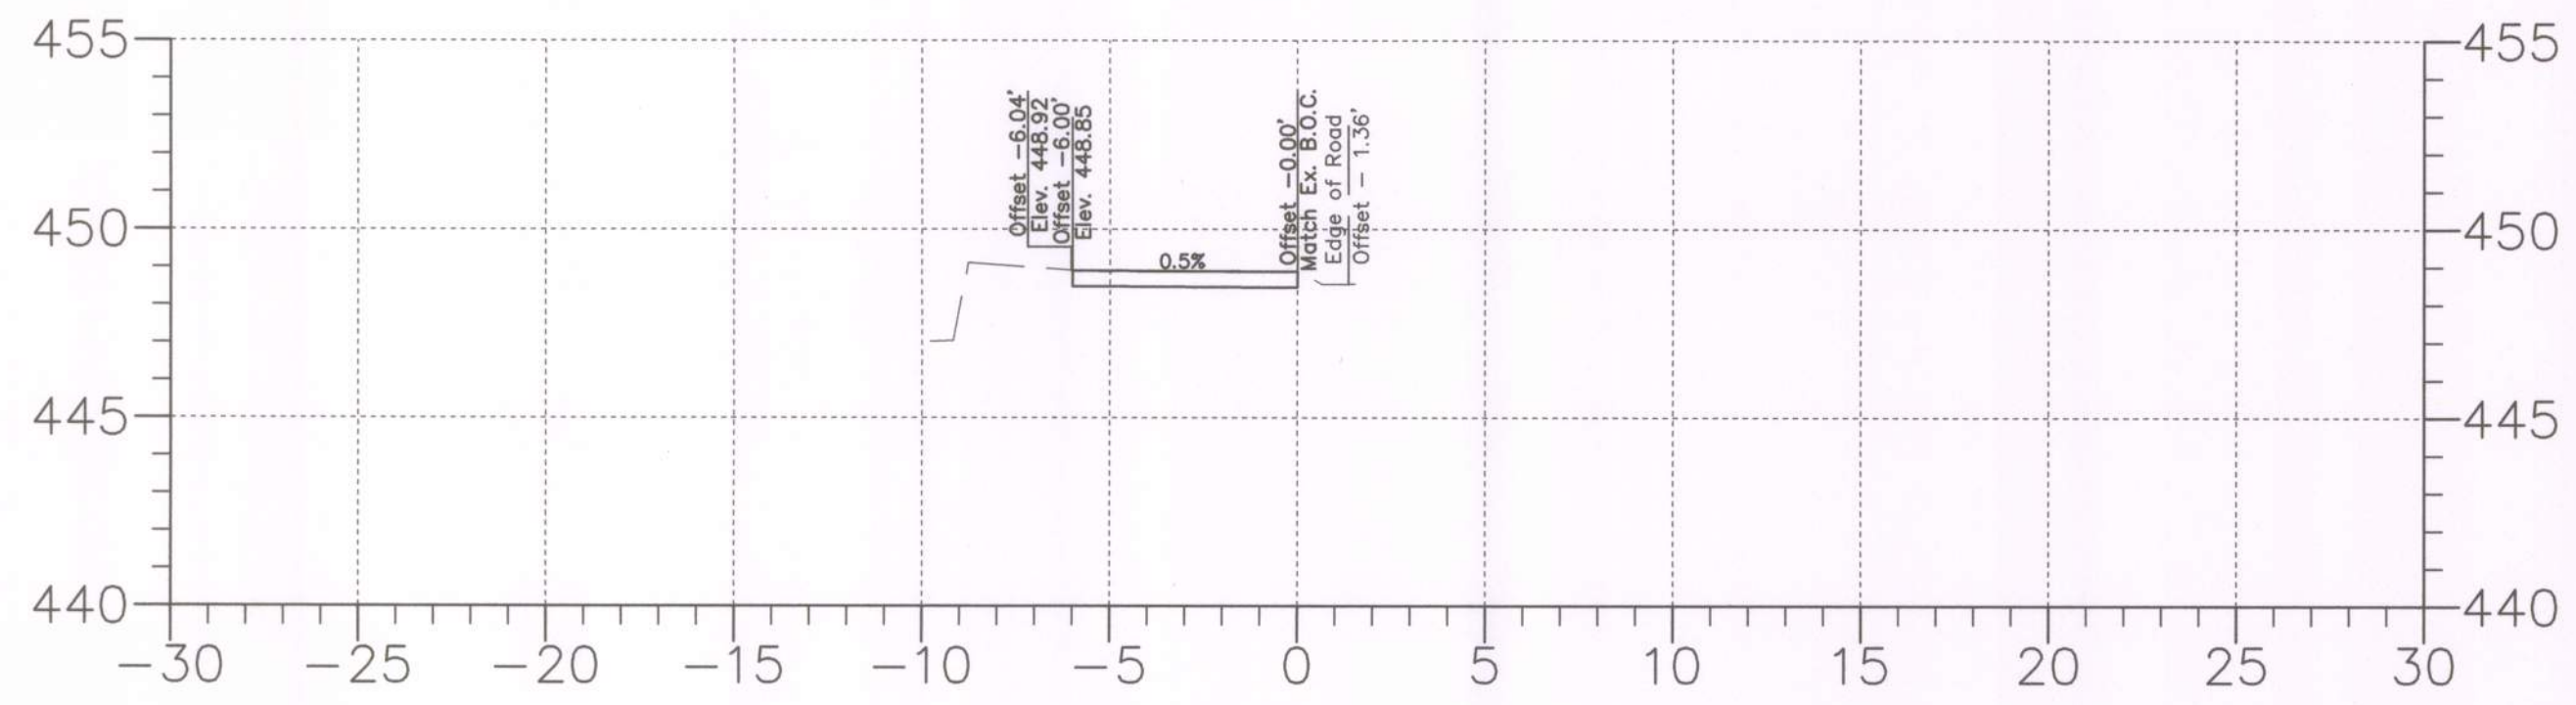


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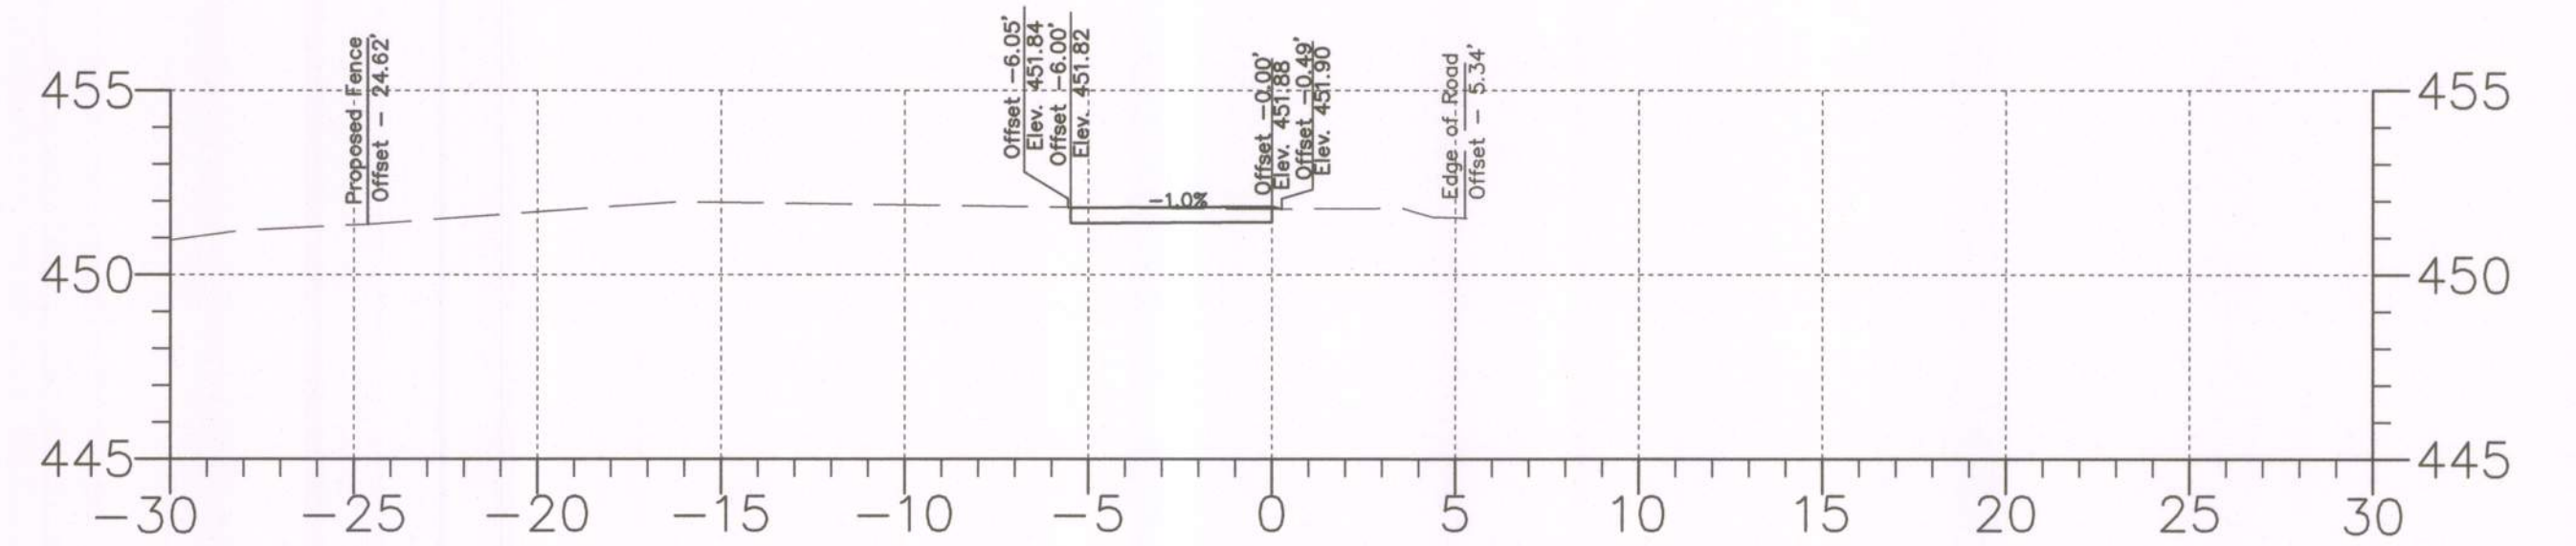
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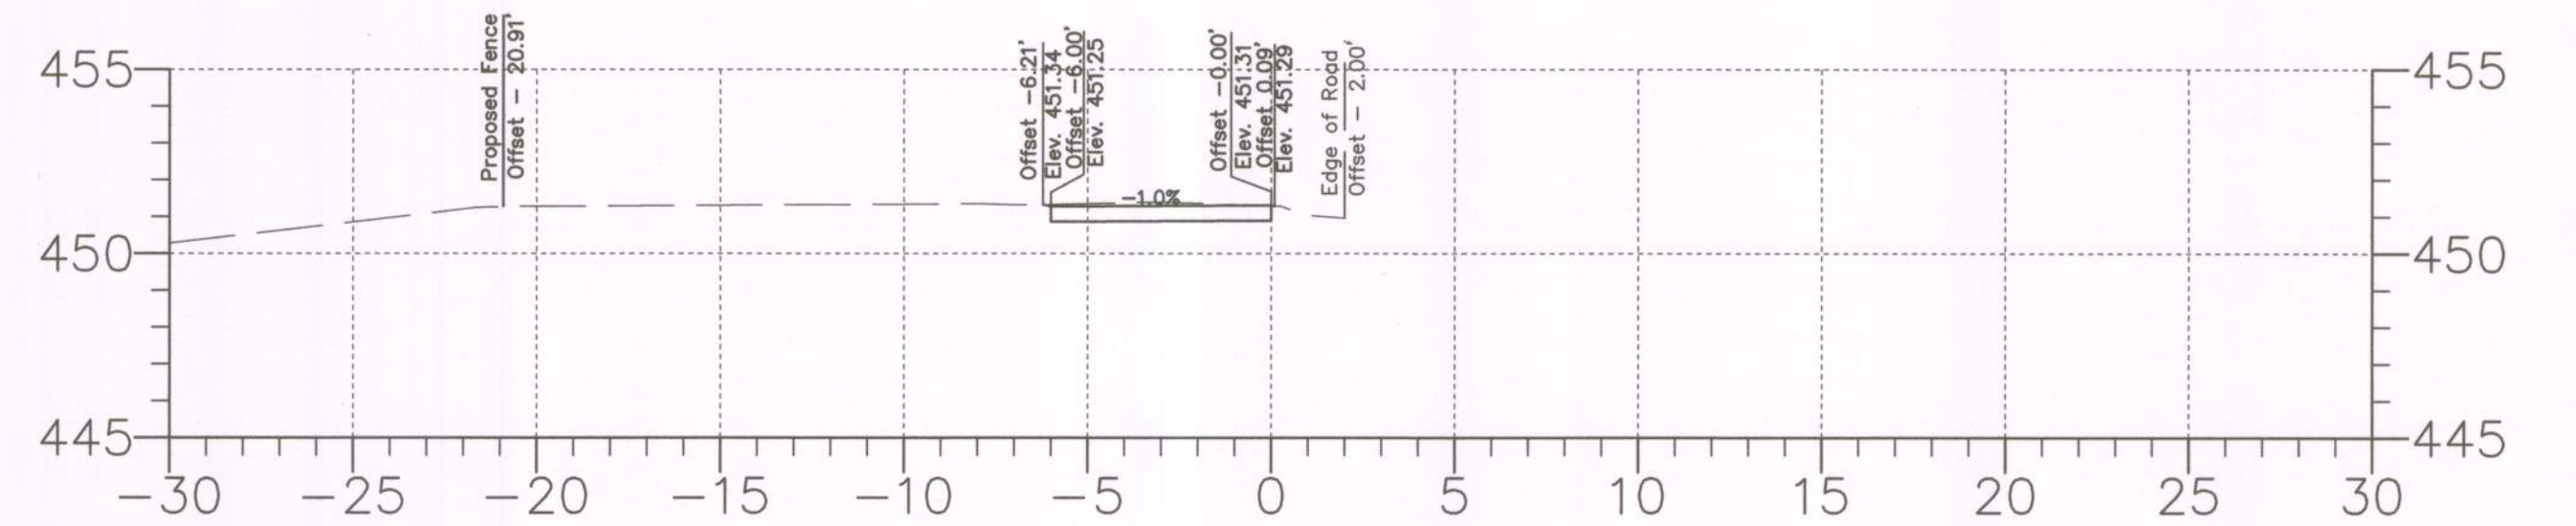
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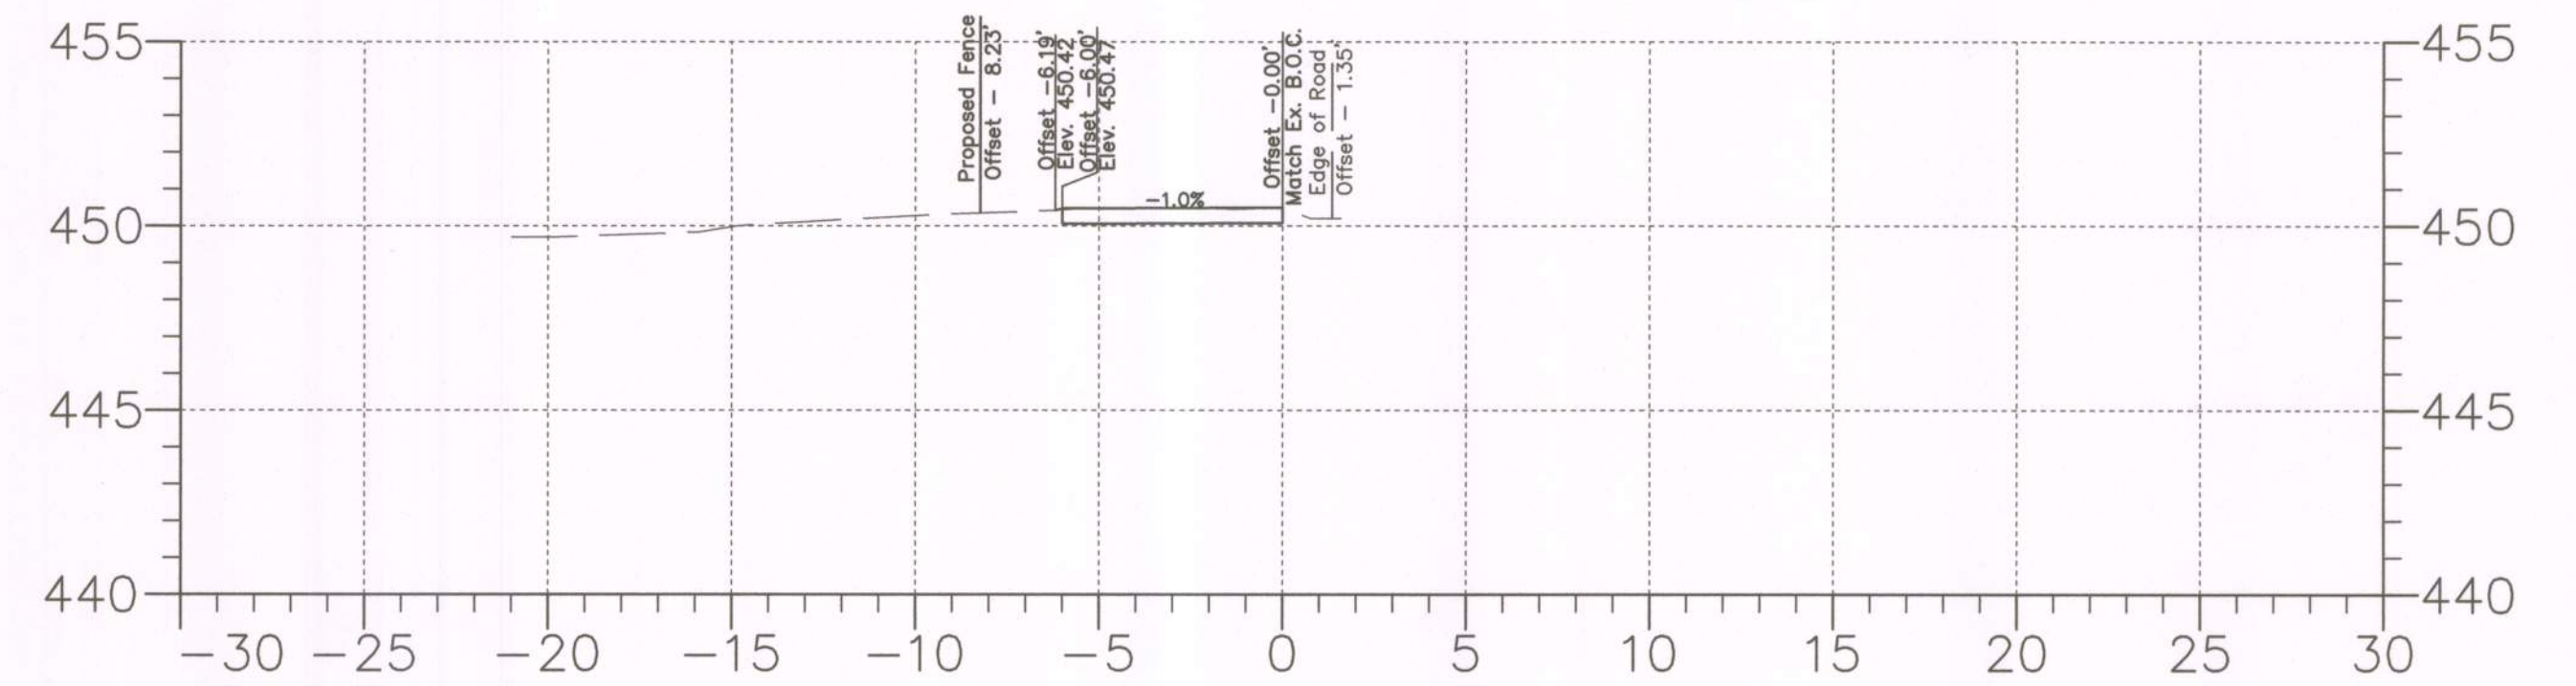
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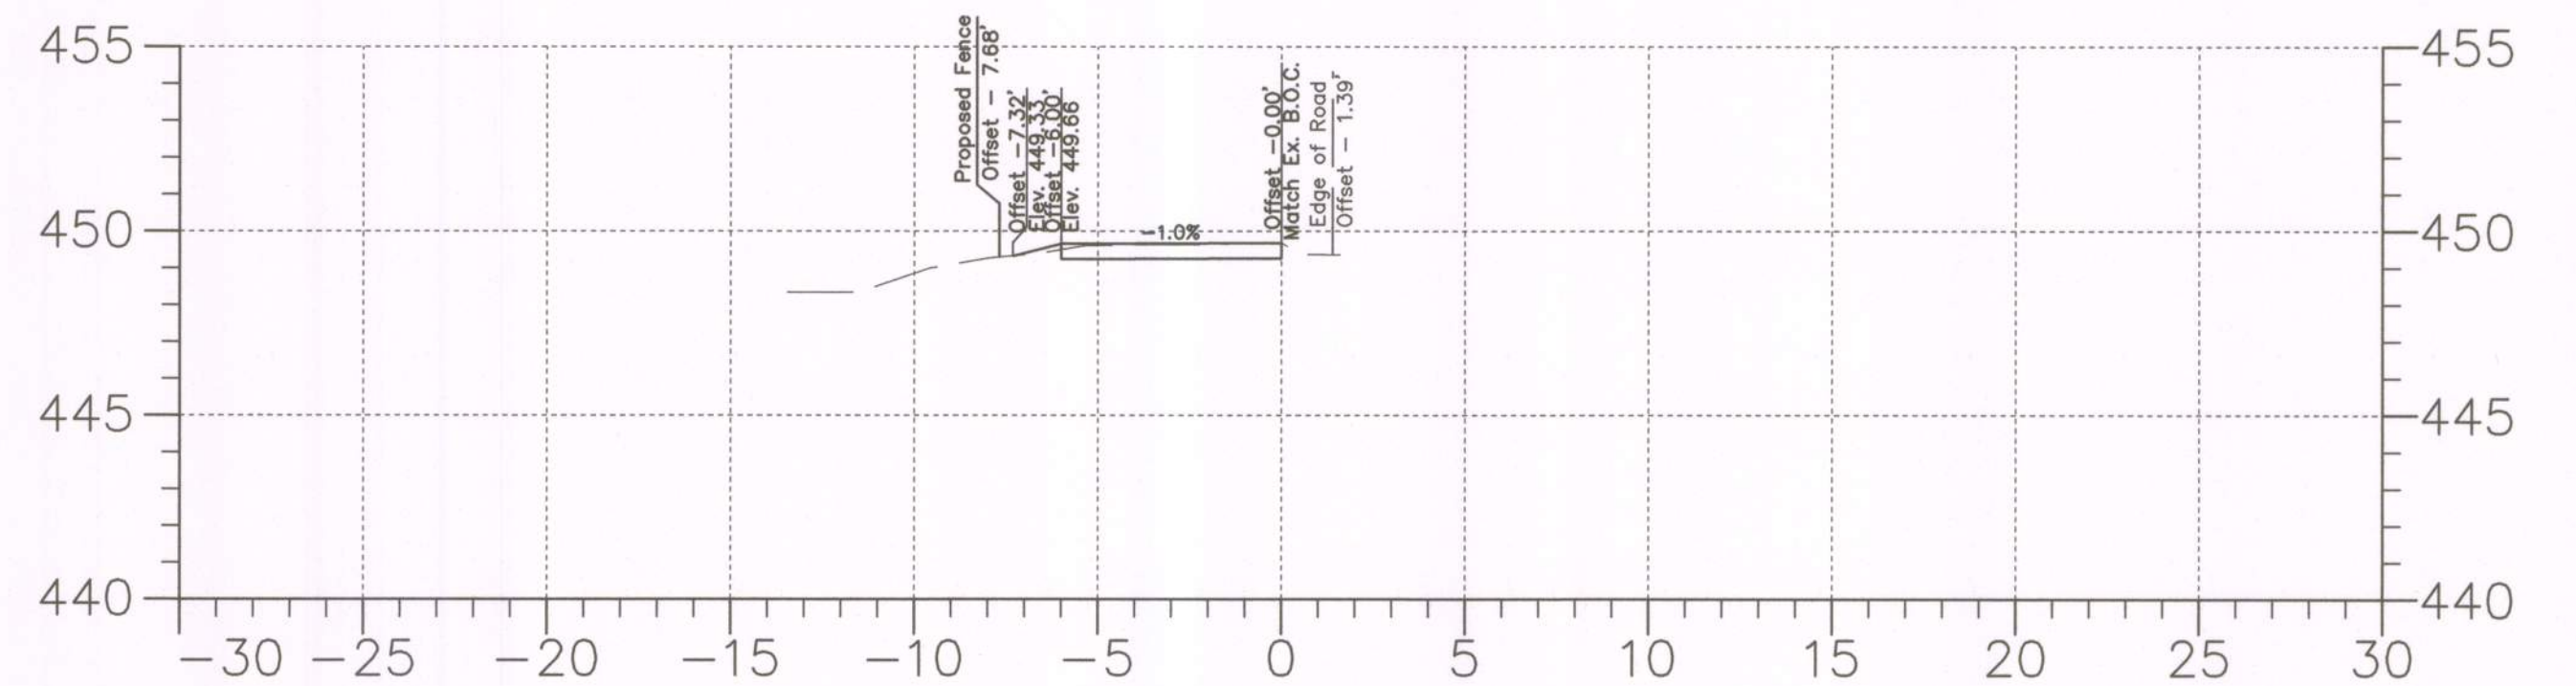
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STA. 3+50



STA. 3+25

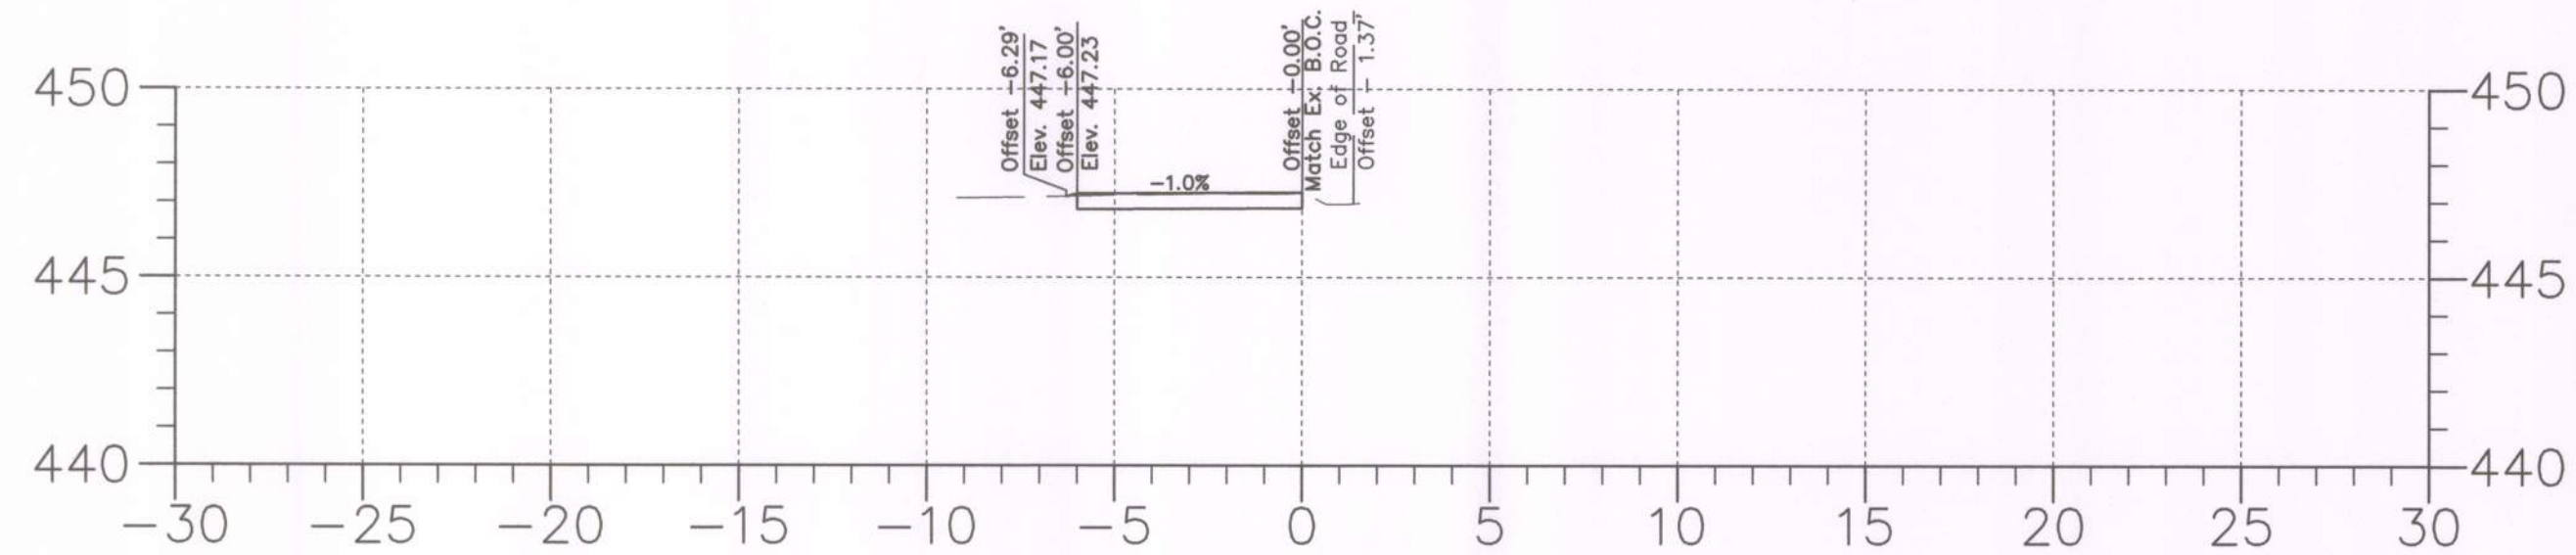

STA. 3+00

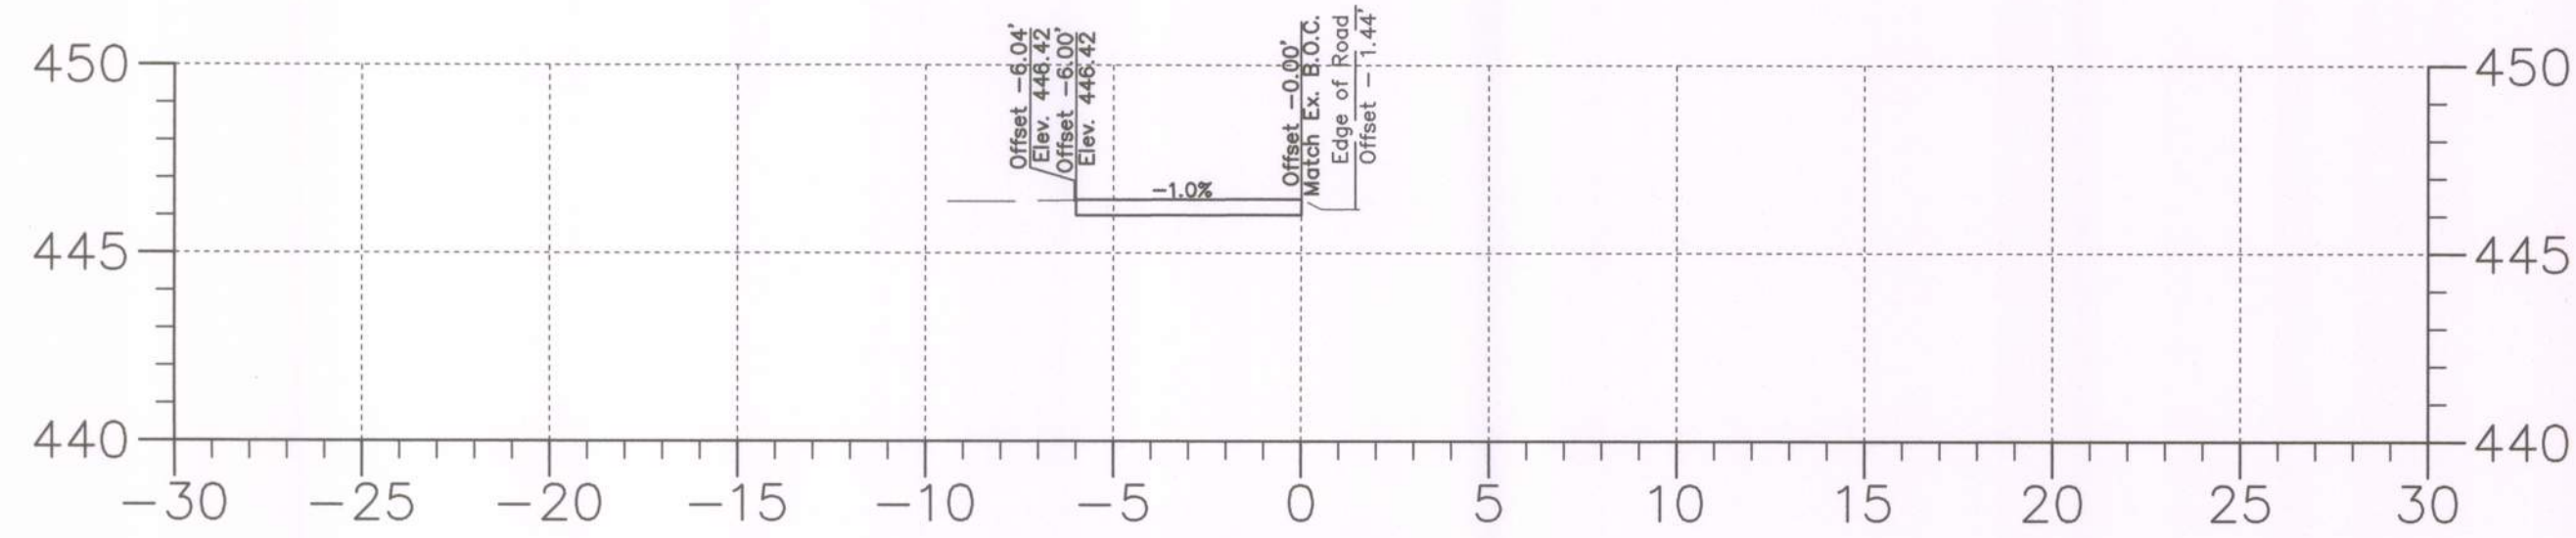

BY: Stratmeyer

PLOTTED: Friday, May 24, 2019 AT 02:10 PM
FILE: Q:\2013\130707_003_Montgomery_Village_CADD\mXC_MontVillage-001.dgn



PROFESSIONAL CERTIFICATION

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Douglas H. Simmons
DOUGLAS H. SIMMONS, PE









MONTGOMERY COUNTY
DEPARTMENT OF HOUSING AND COMMUNITY AFFAIRS
MONTGOMERY VILLAGE / SOUTH VILLAGE HOMES
LIGHTING AND SITE IMPROVEMENTS PROJECT

GROVER'S FORGE - CROSS SECTIONS

SCALE: 5" = 10' ADVERTISED DATE: N/A CONTRACT NO. _____

DESIGNED BY: RJS COUNTY: MONTGOMERY COUNTY
DRAWN BY: RJS LOGMILE: _____
CHECKED BY: JJR
DPS PERMIT: _____

DRAWING NO. **XS-02** OF **05** SHEET NO. 43 OF 46

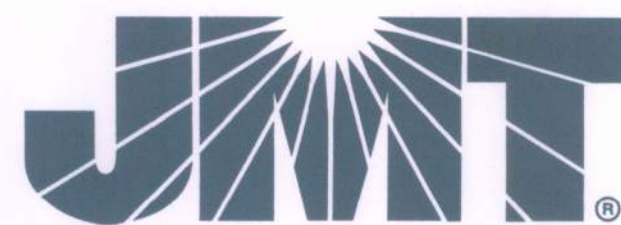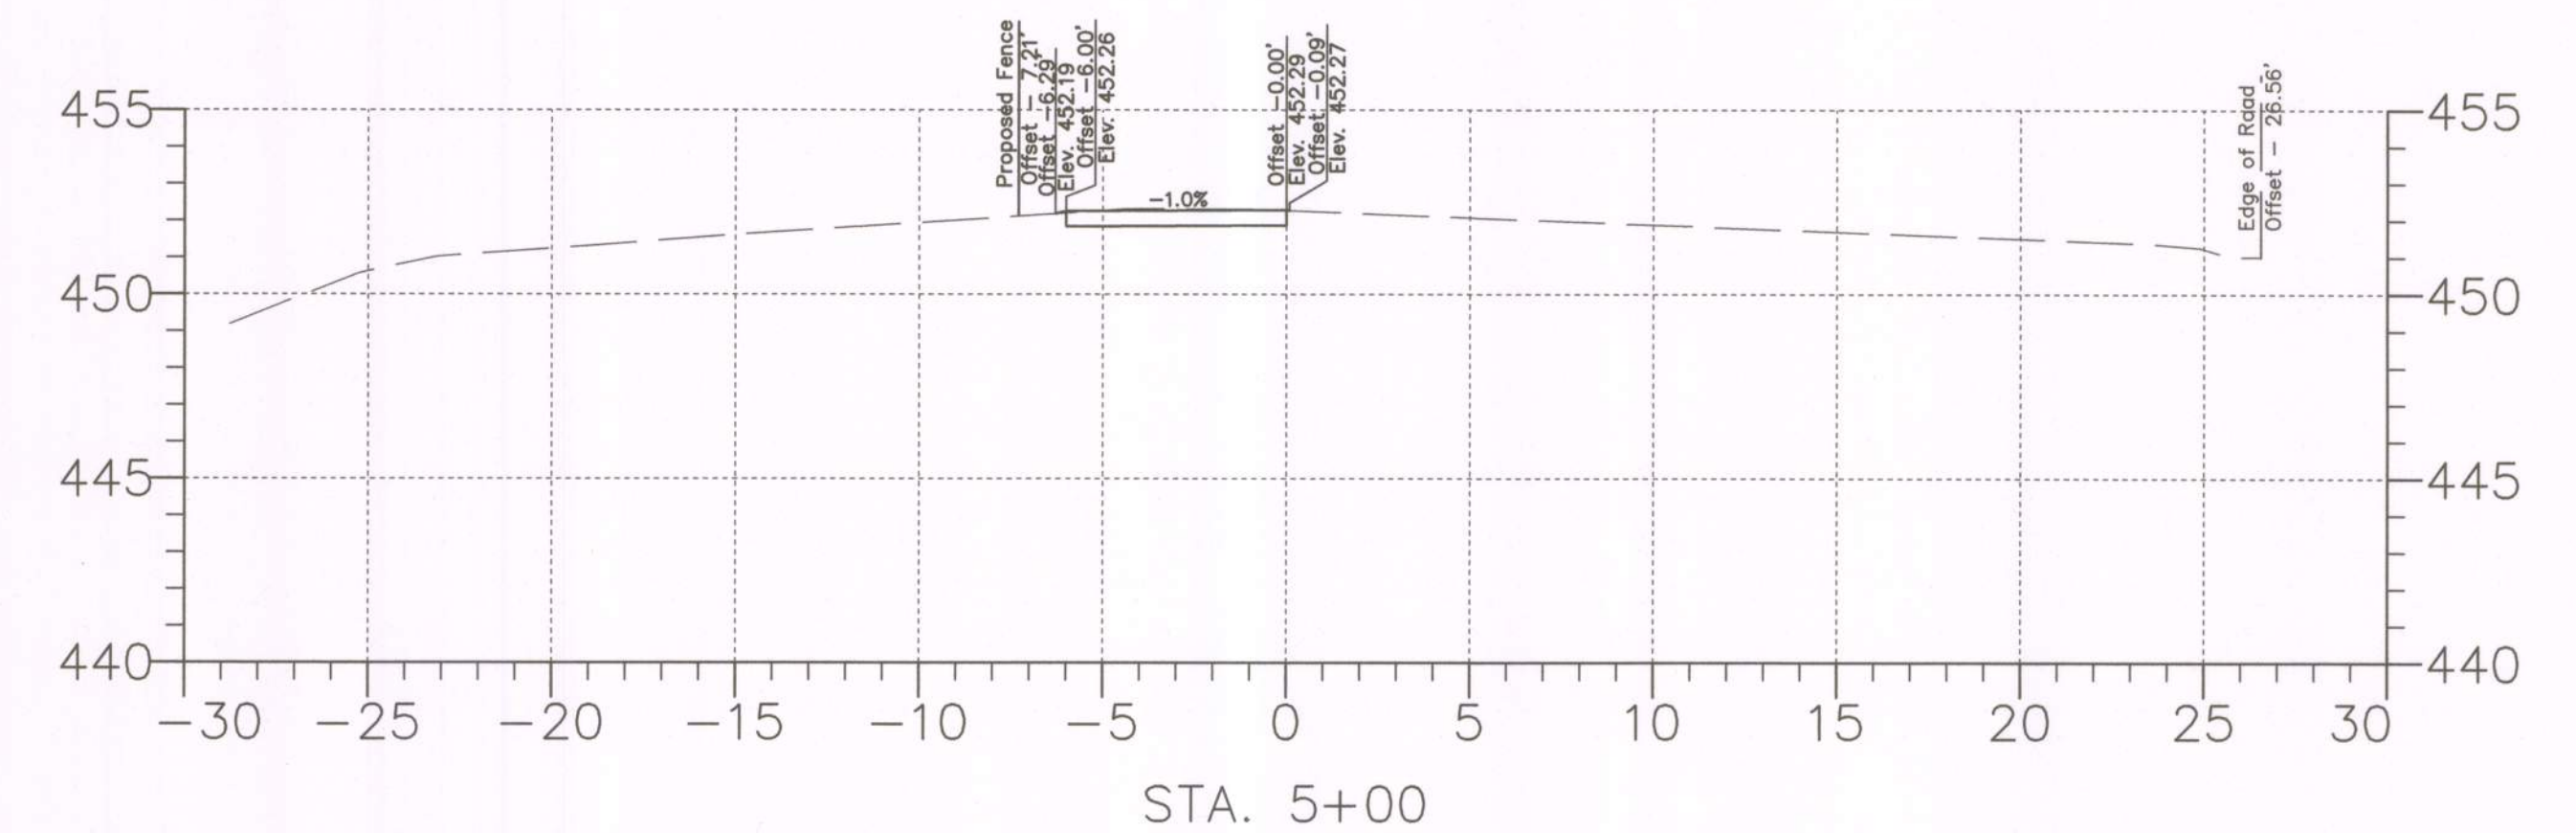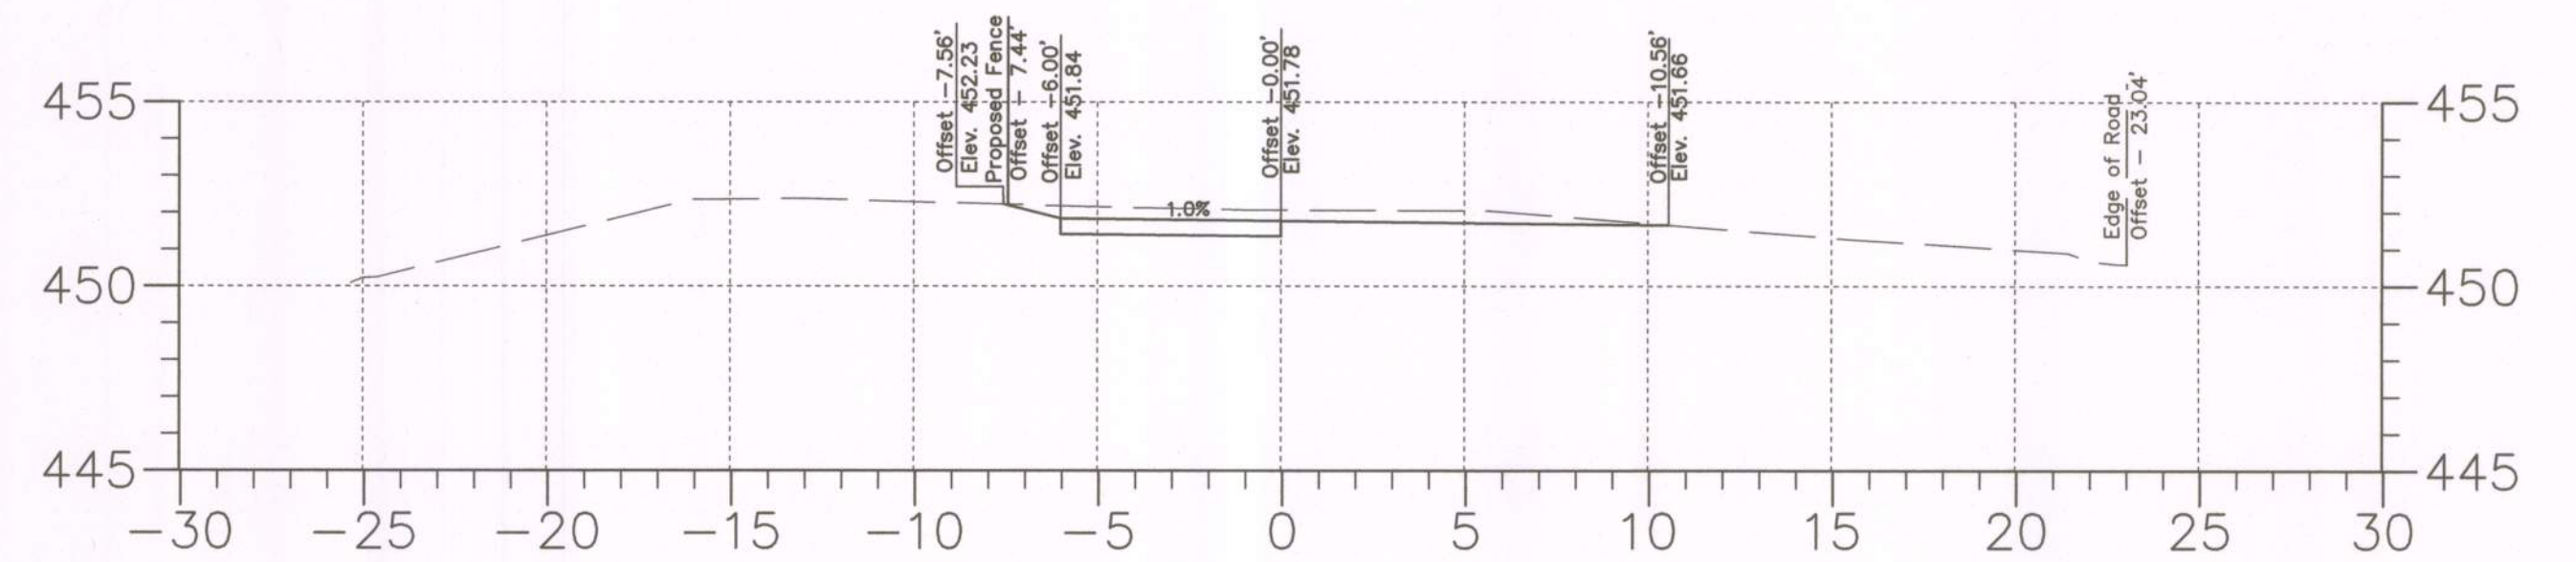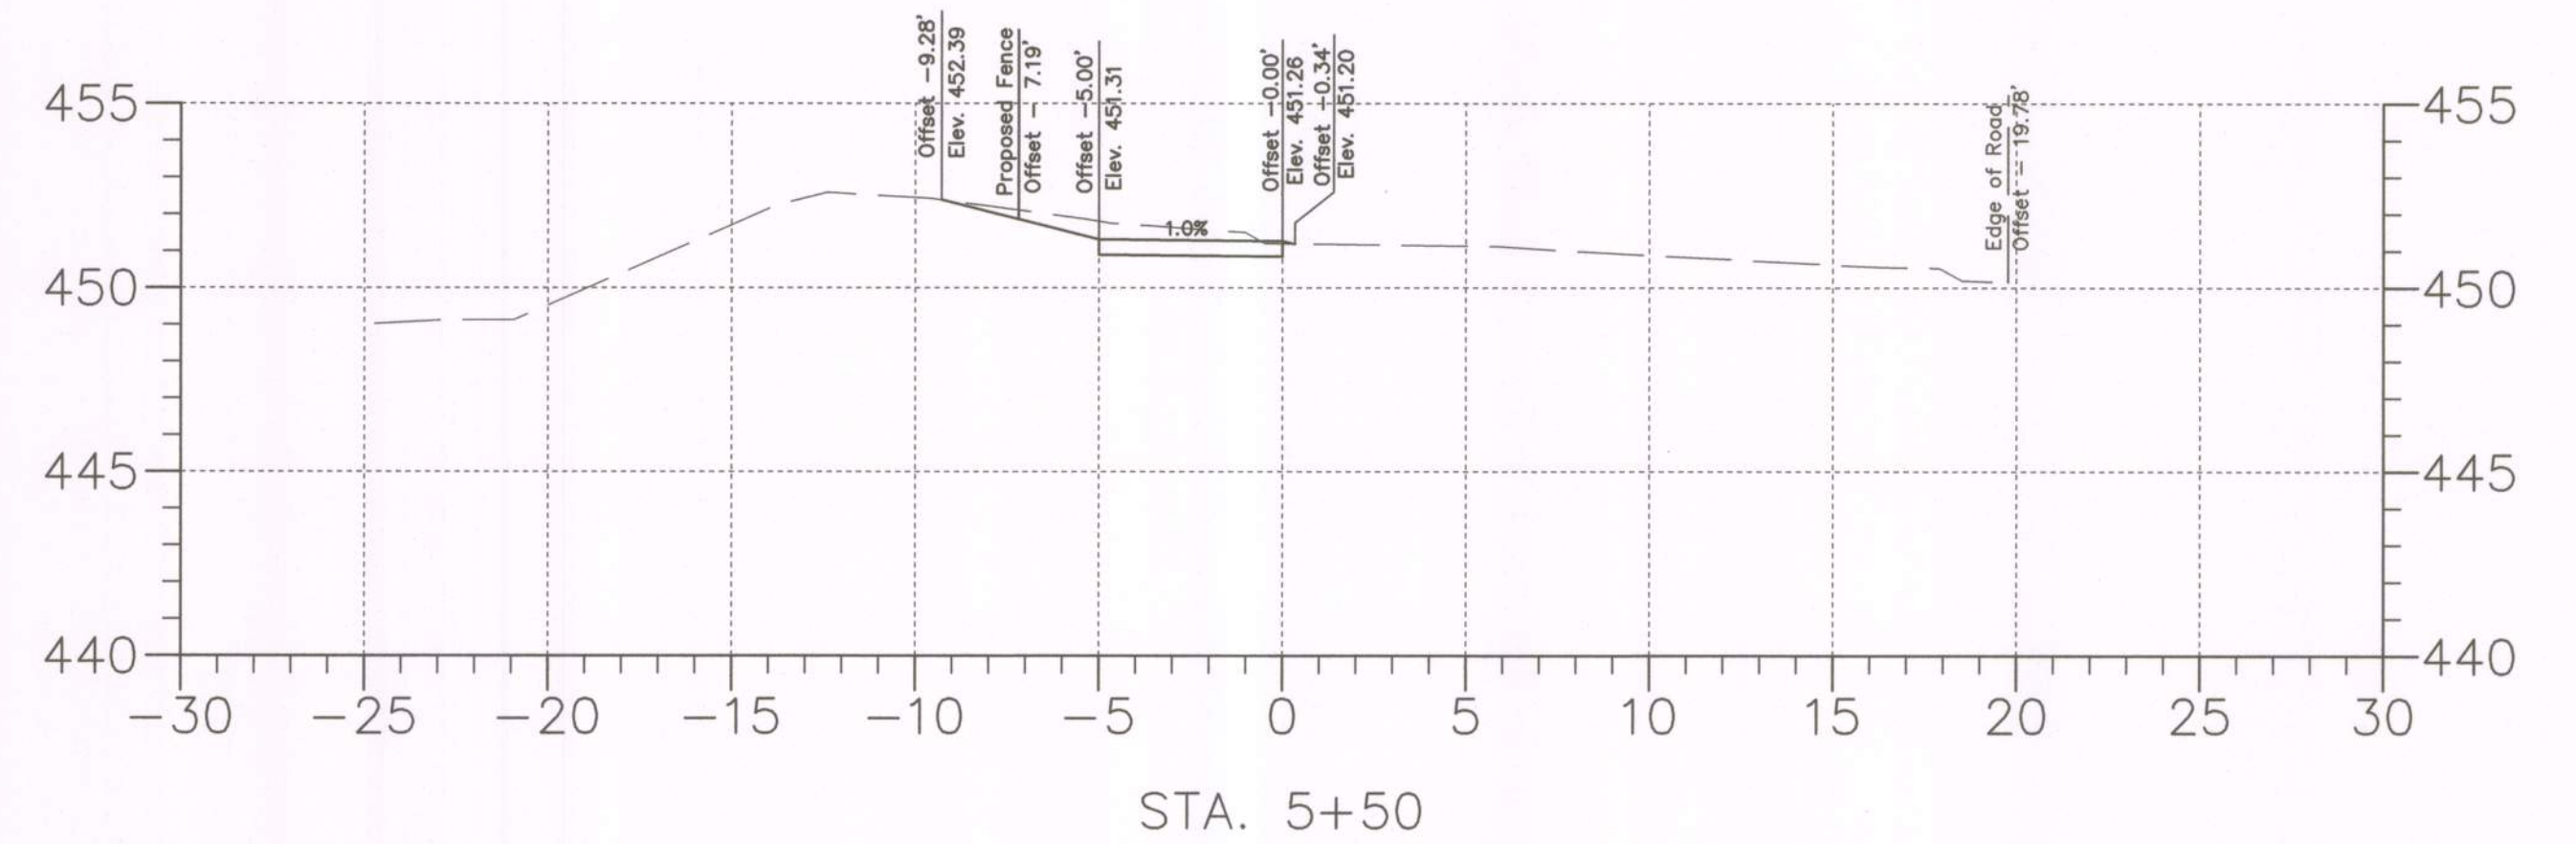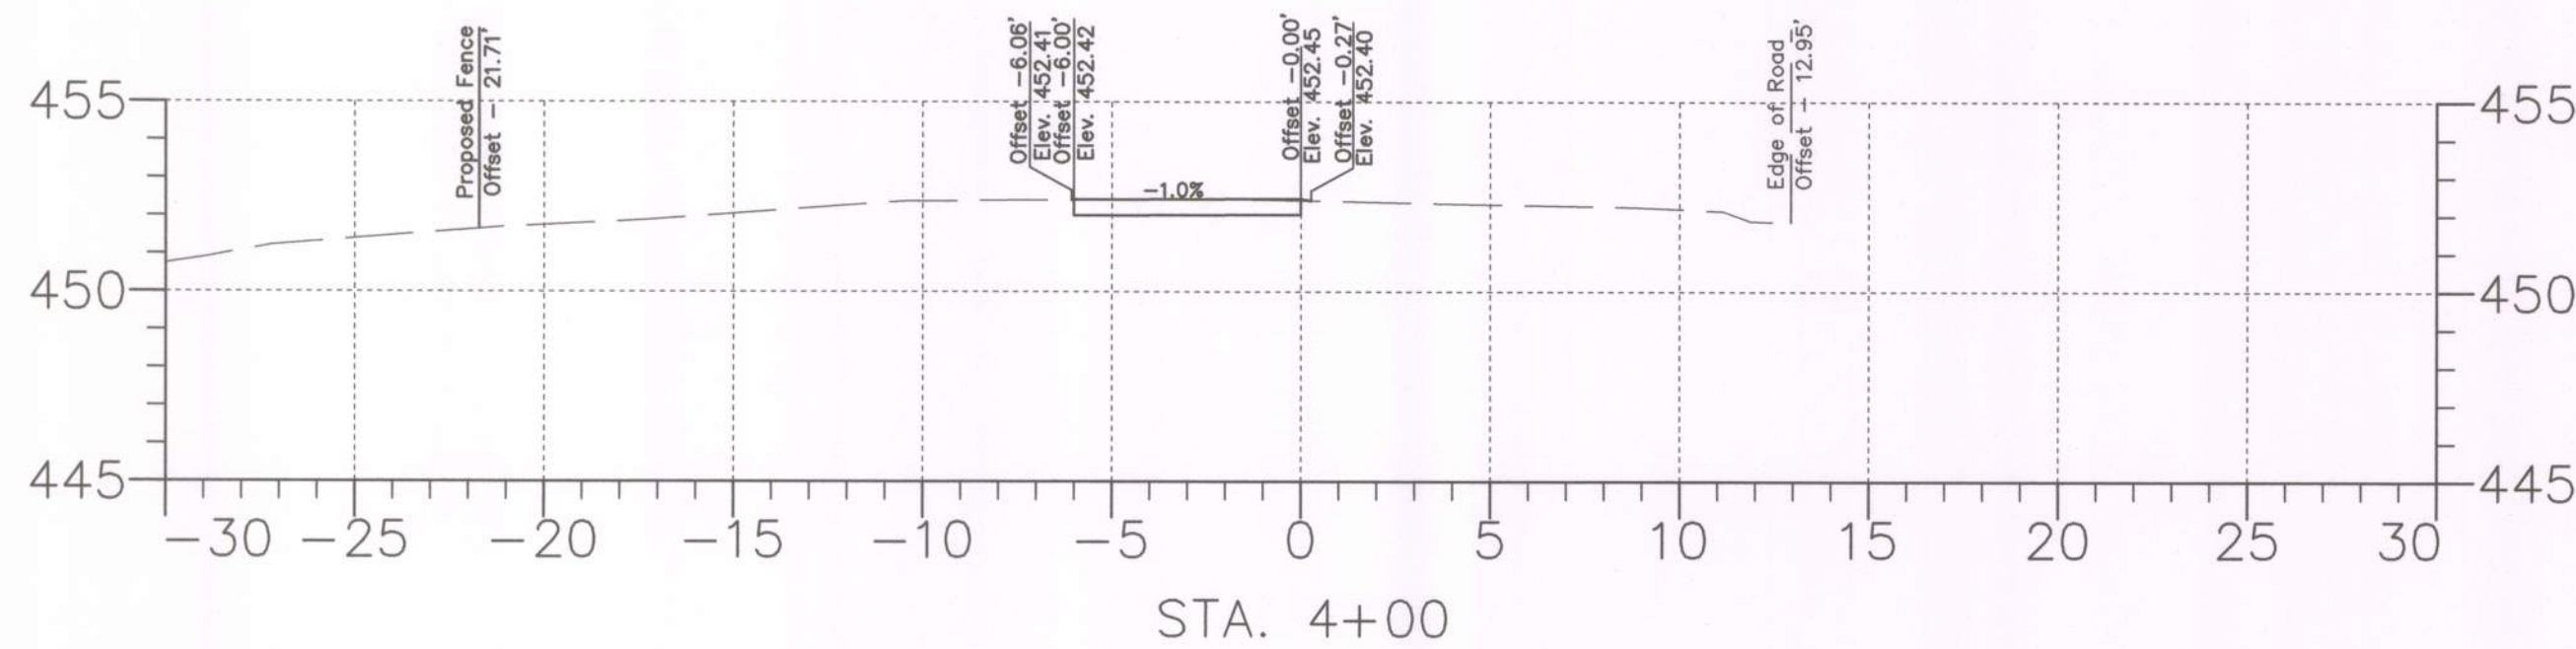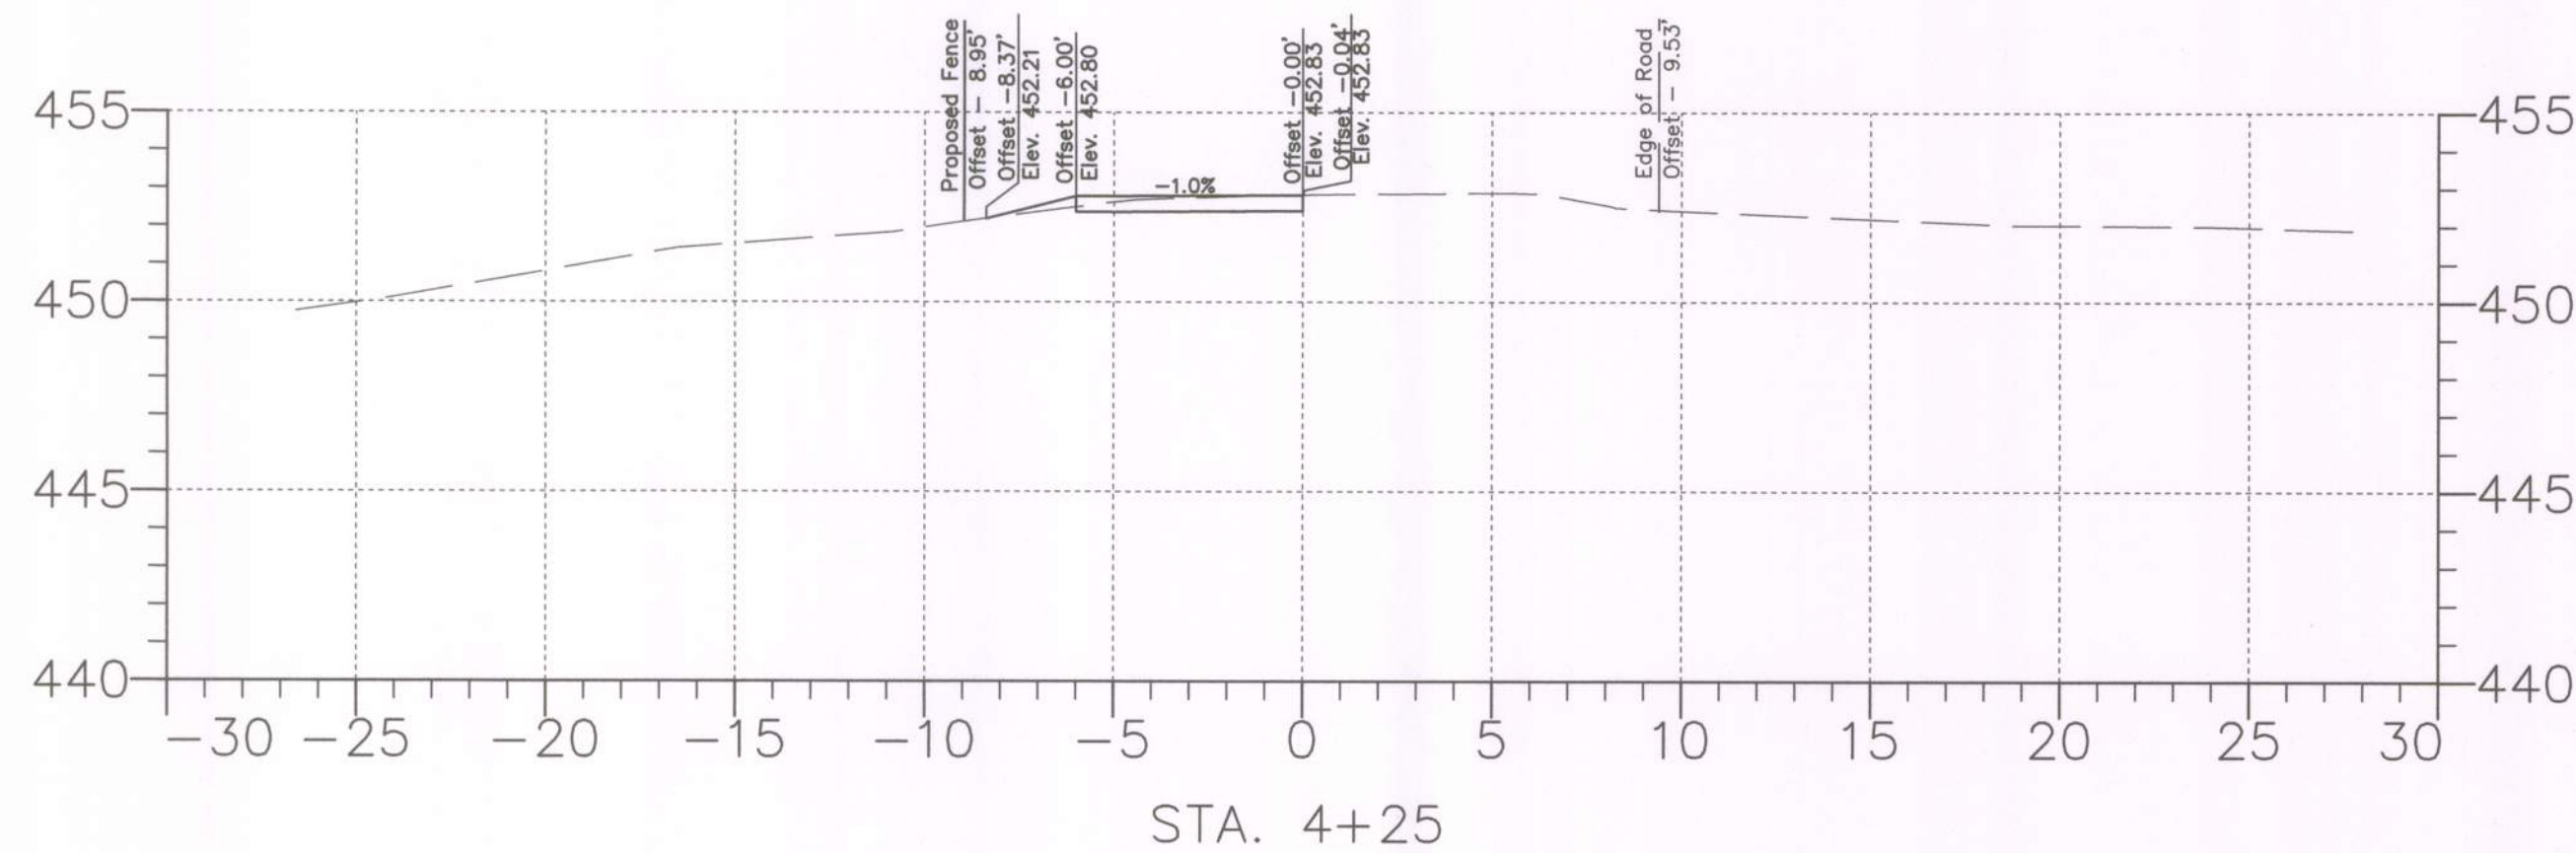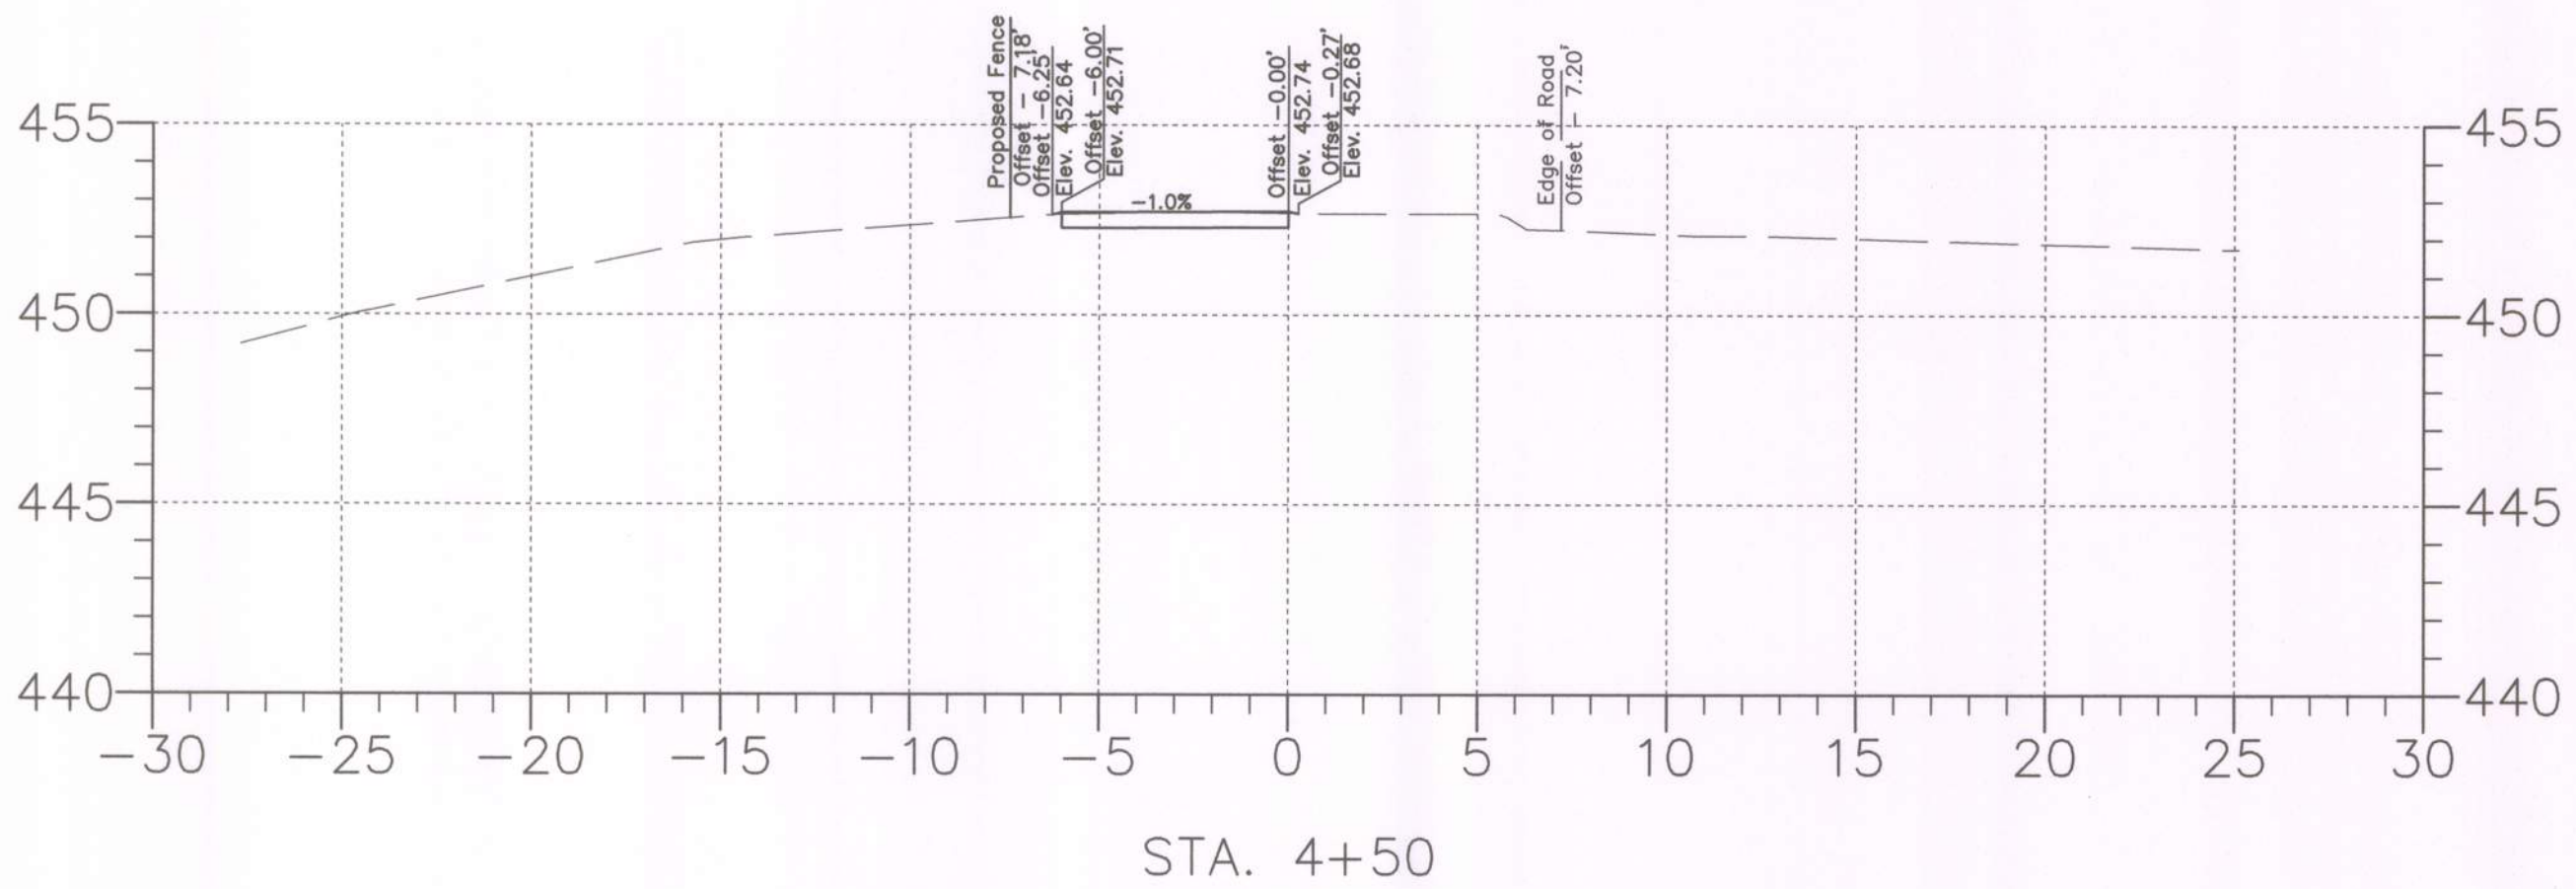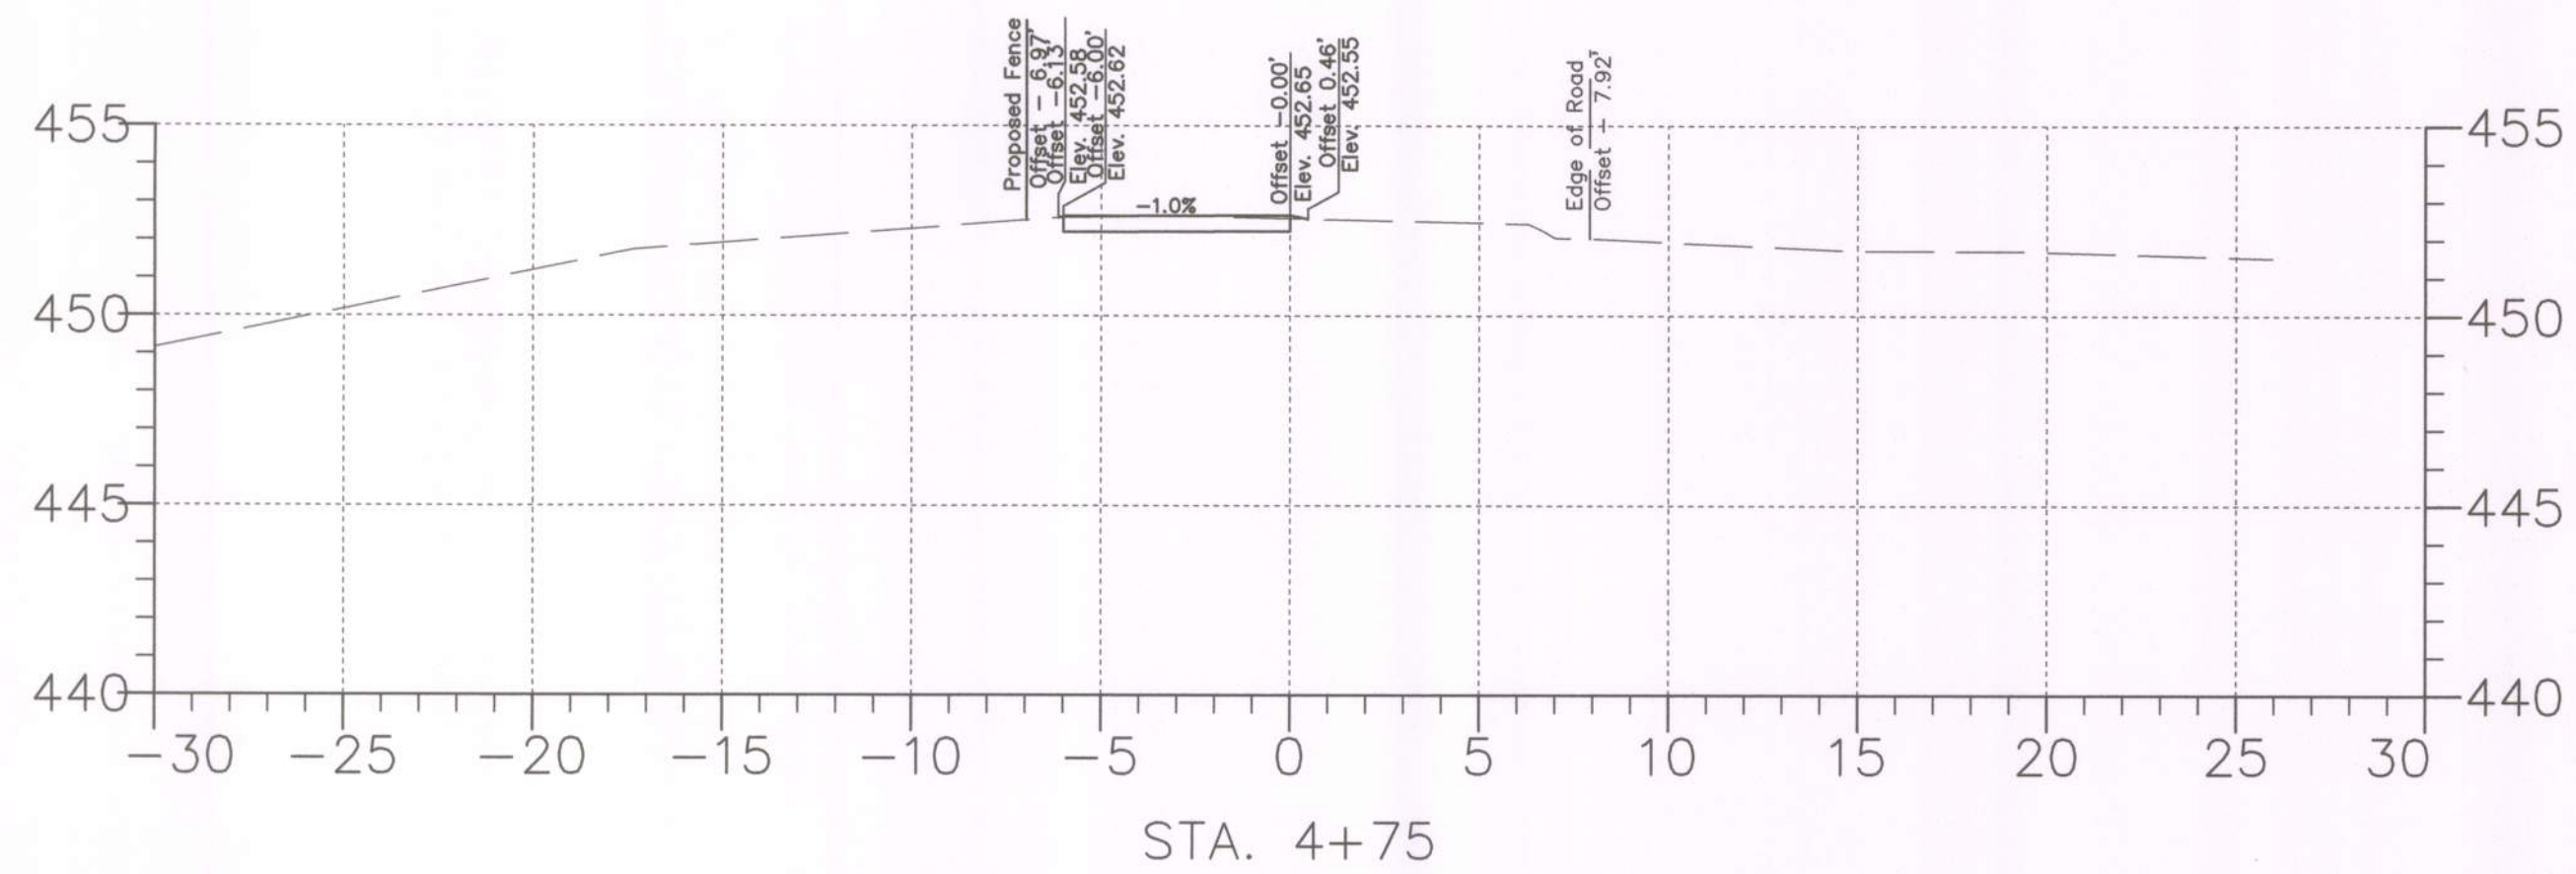

BY: Stratmeyer

PLOTTED: Thursday, May 23, 2019 AT 09:03 AM
FILE: Q:\2013\130707_003_Montgomery_Village_CADD\mxc_MontVillage-001.dgn



PROFESSIONAL CERTIFICATION

I HEREBY CERTIFY THAT THESE DOCUMENTS WERE PREPARED OR APPROVED BY ME, AND THAT I AM A DULY LICENSED PROFESSIONAL ENGINEER UNDER THE STATE LAWS OF THE STATE OF MARYLAND, LICENSE NO. 17873, EXPIRATION DATE: 01/29/2020.

DHS
DOUGLAS H. SIMMONS, PE

MONTGOMERY COUNTY
DEPARTMENT OF HOUSING AND COMMUNITY AFFAIRS
MONTGOMERY VILLAGE /SOUTH VILLAGE HOMES
LIGHTING AND SITE IMPROVEMENTS PROJECT

GROVER'S FORGE - CROSS SECTIONS

SCALE: 5" = 100' ADVERTISED DATE: N/A CONTRACT NO. _____







DESIGNED BY: RJS COUNTY: MONTGOMERY COUNTY

DRAWN BY: RJS LOGMILE: _____

CHECKED BY: JWR

DPS PERMIT: _____

DRAWING NO. **XS-03** OF **05** SHEET NO. 44 OF 46

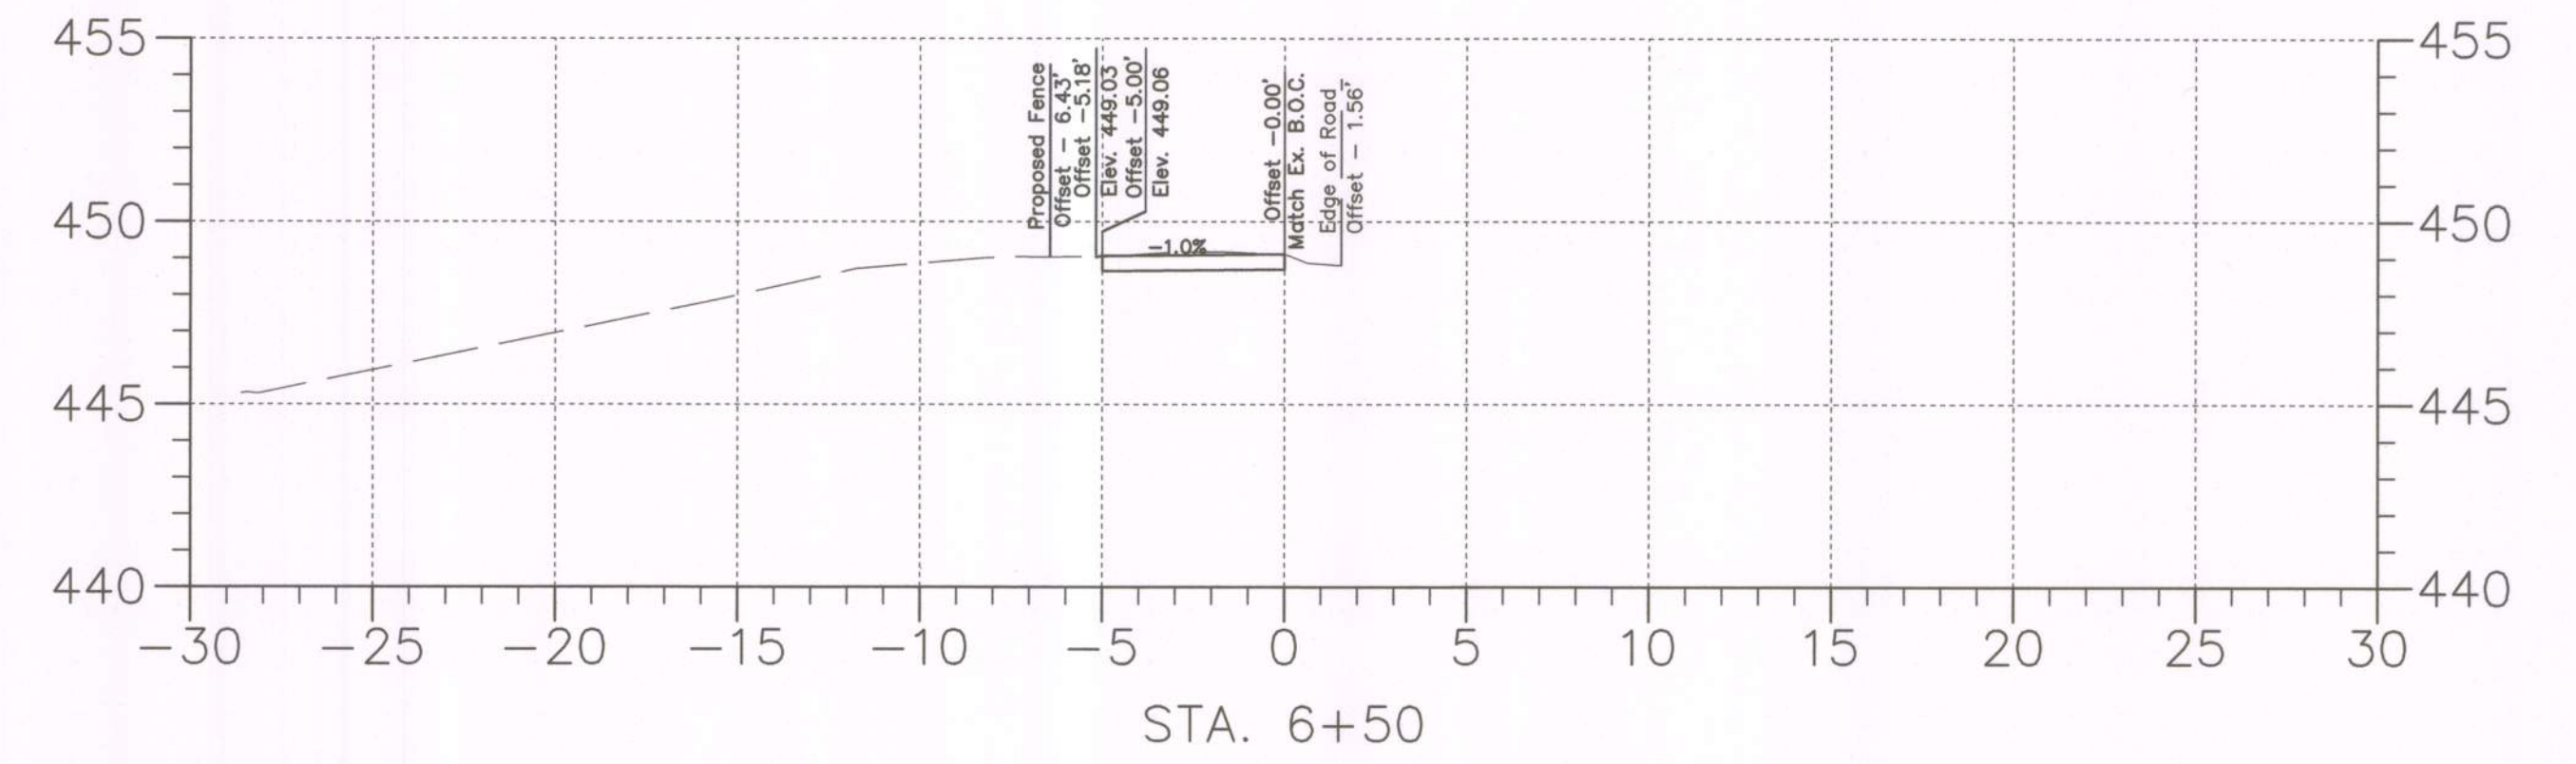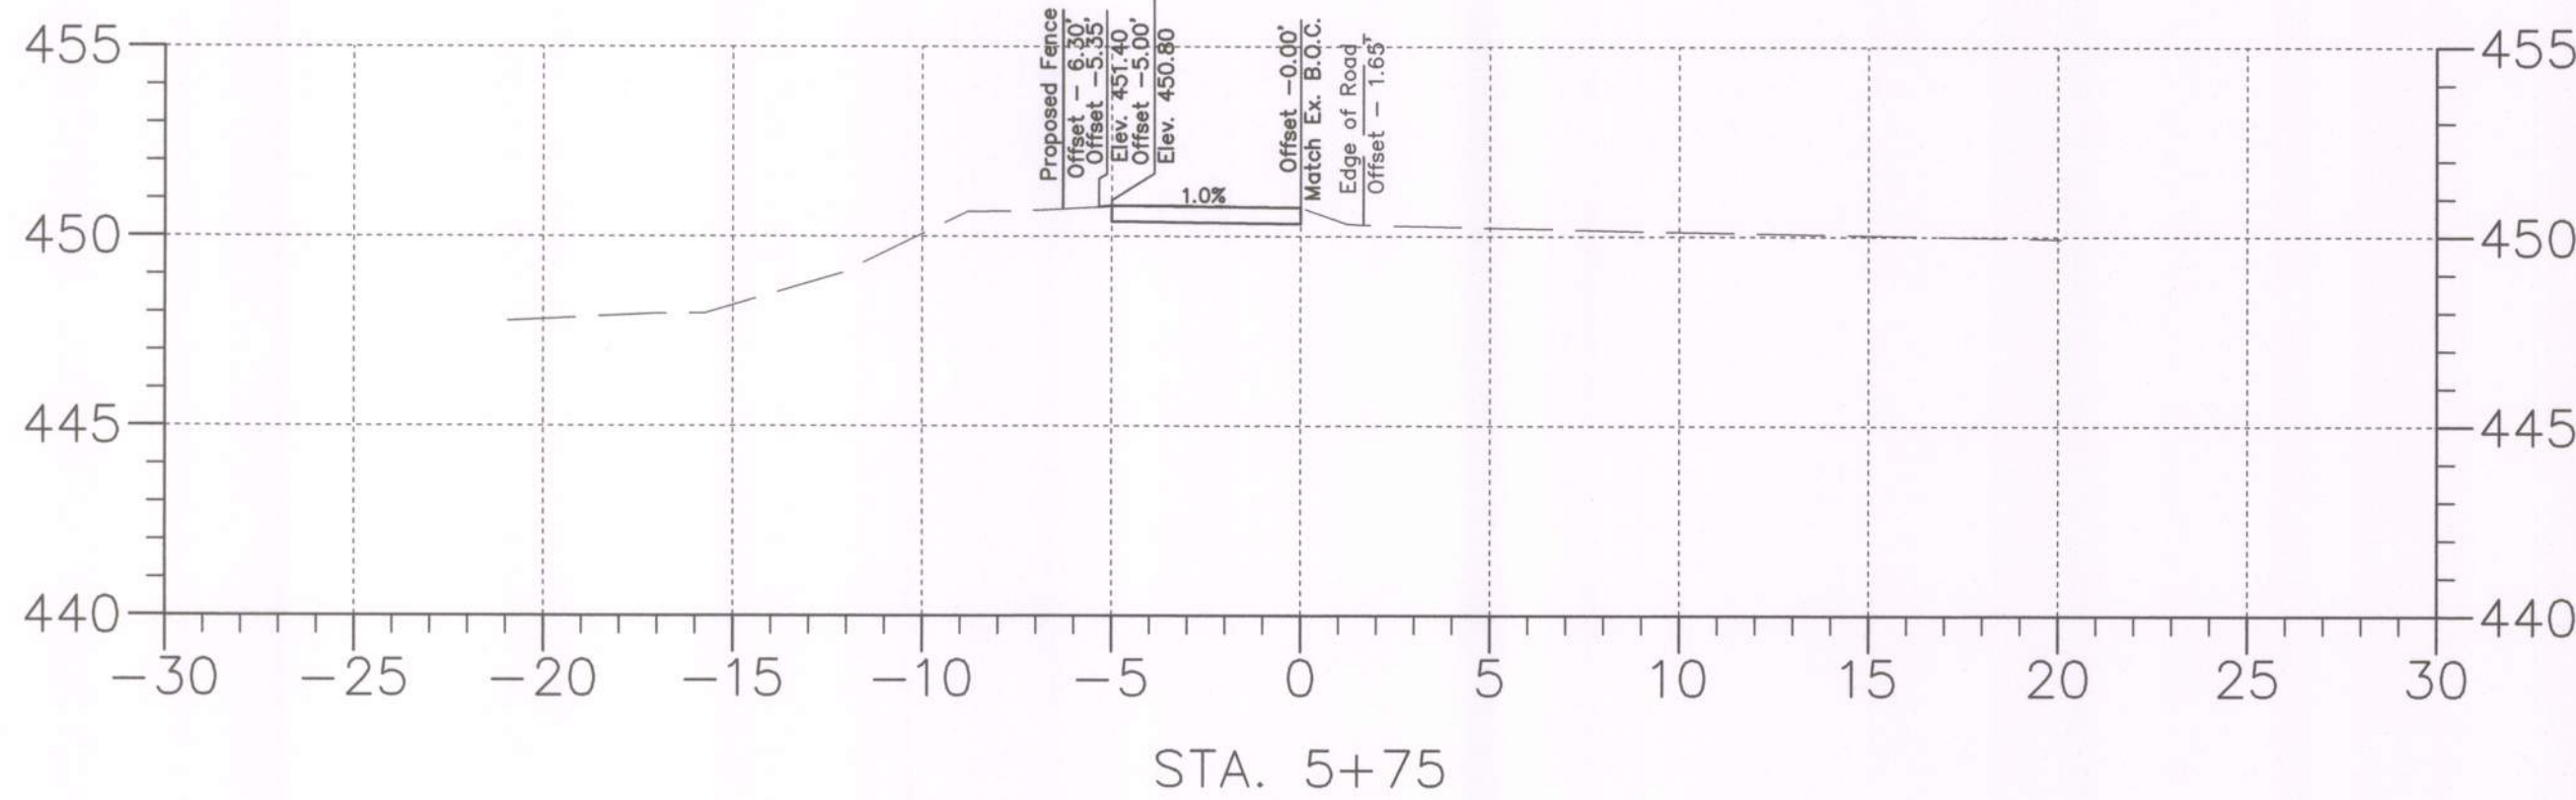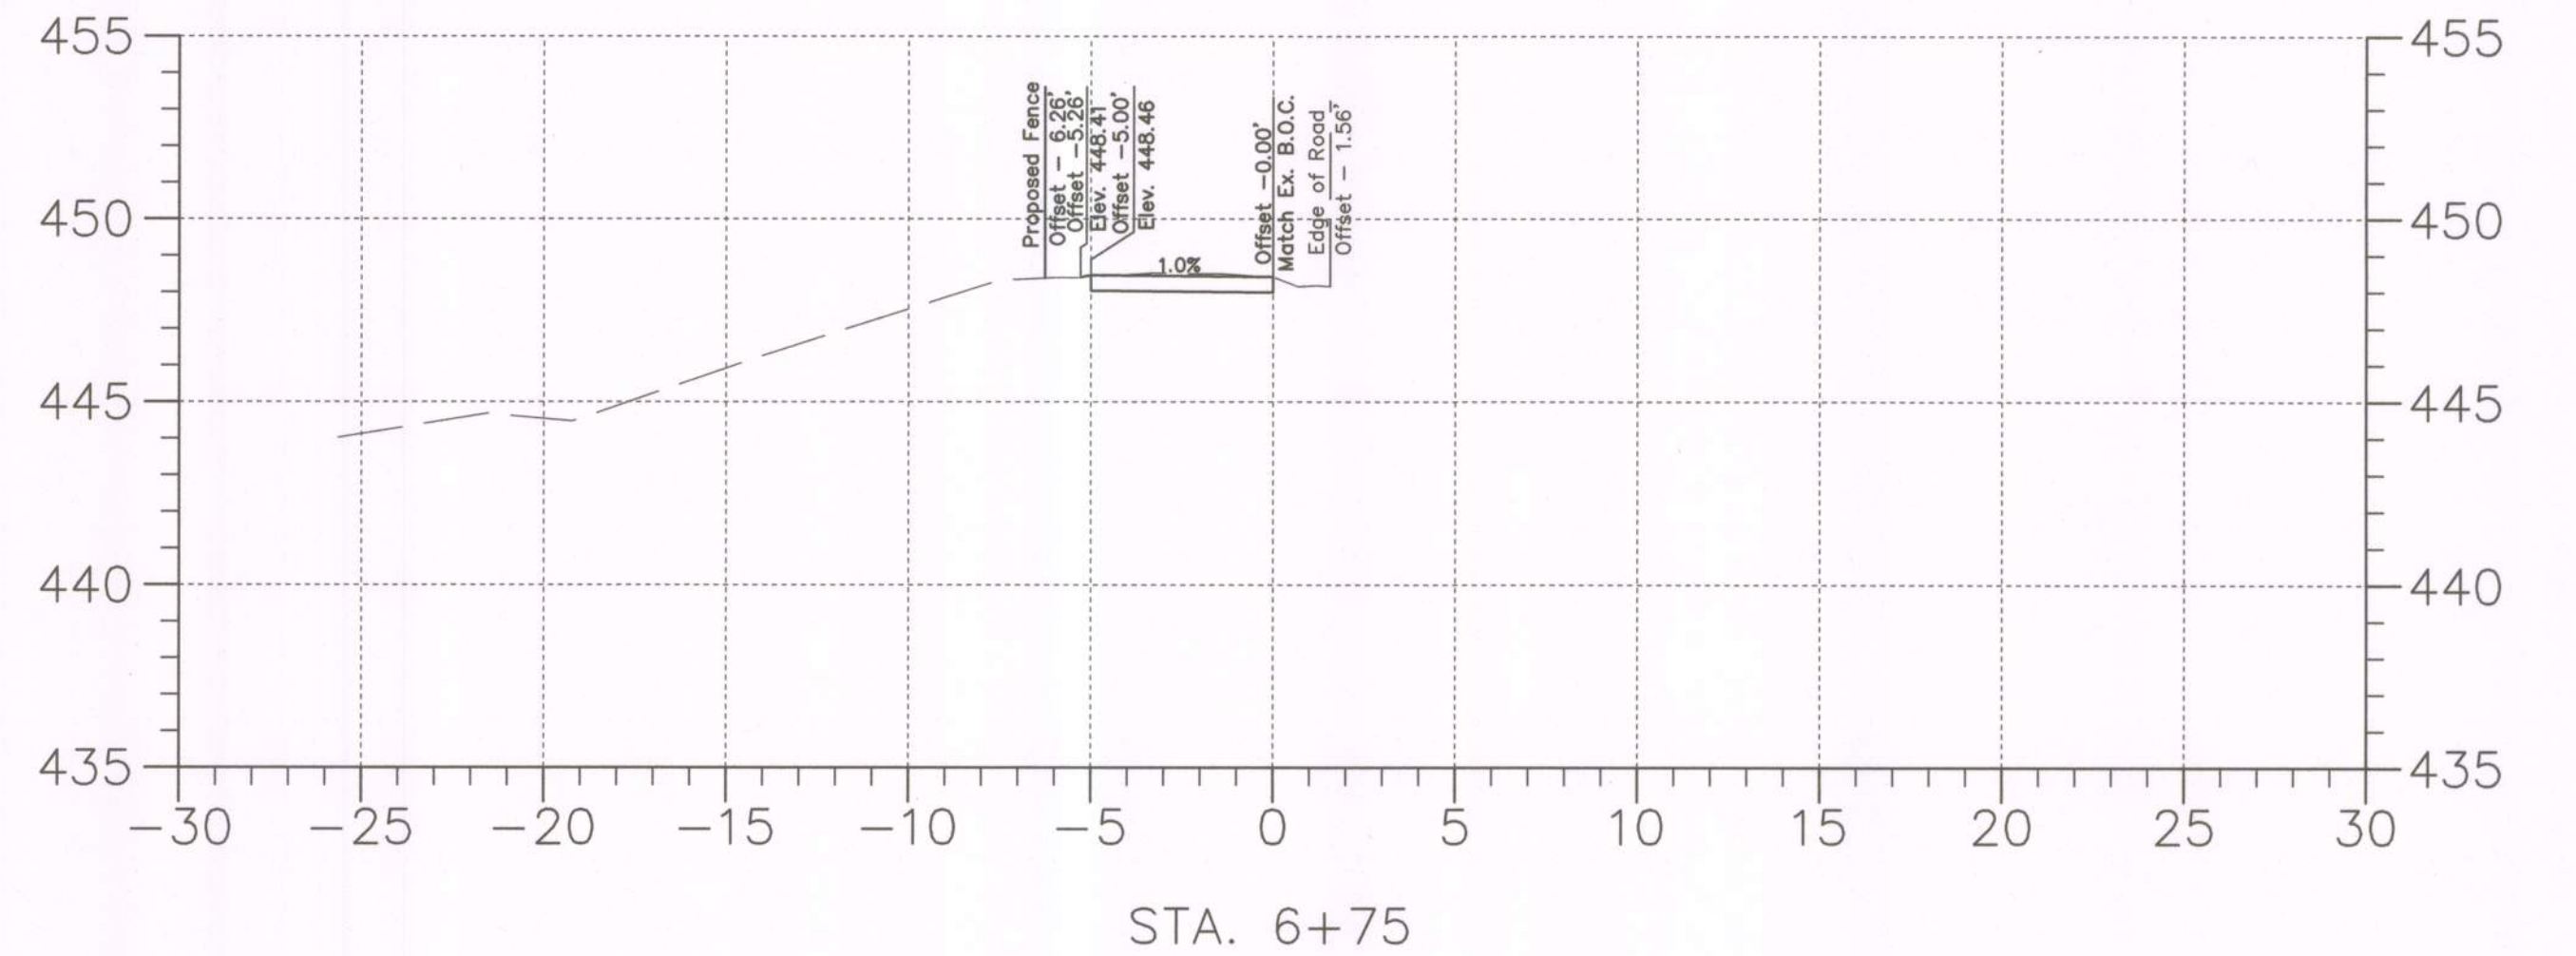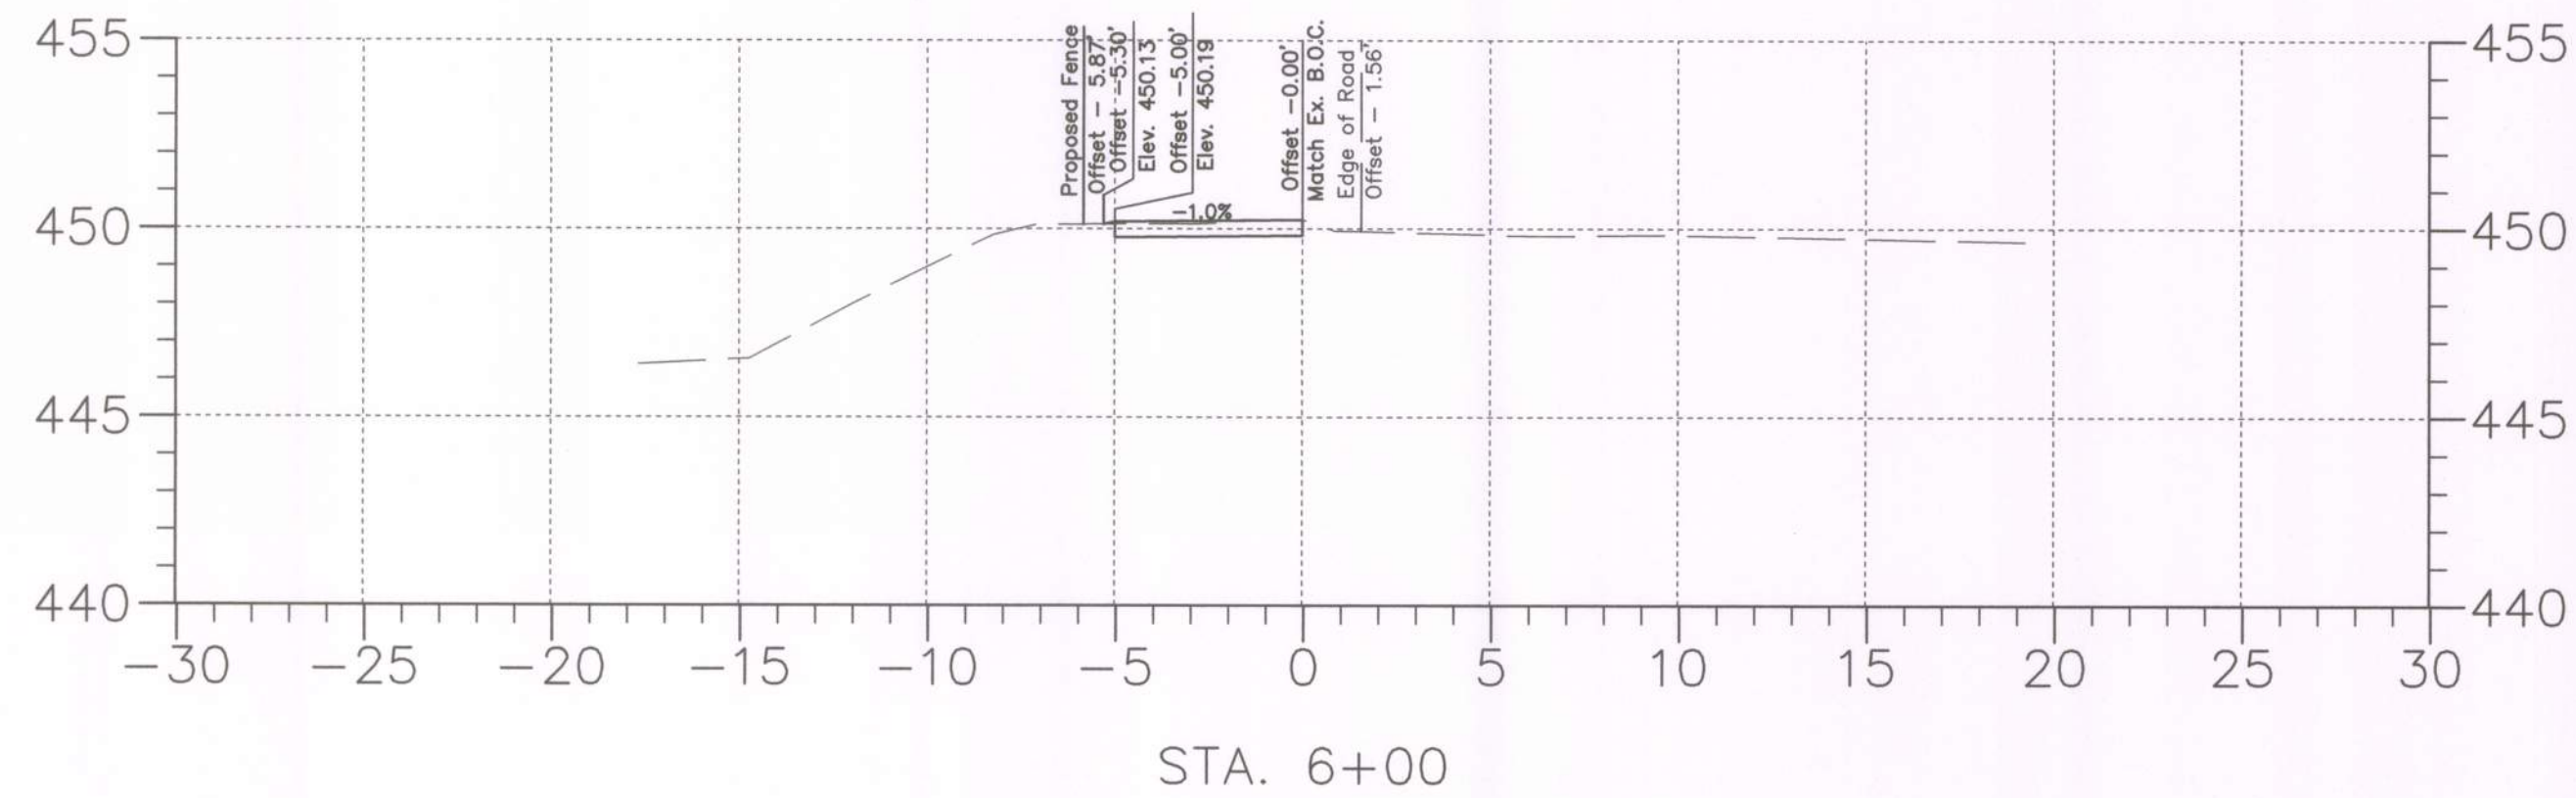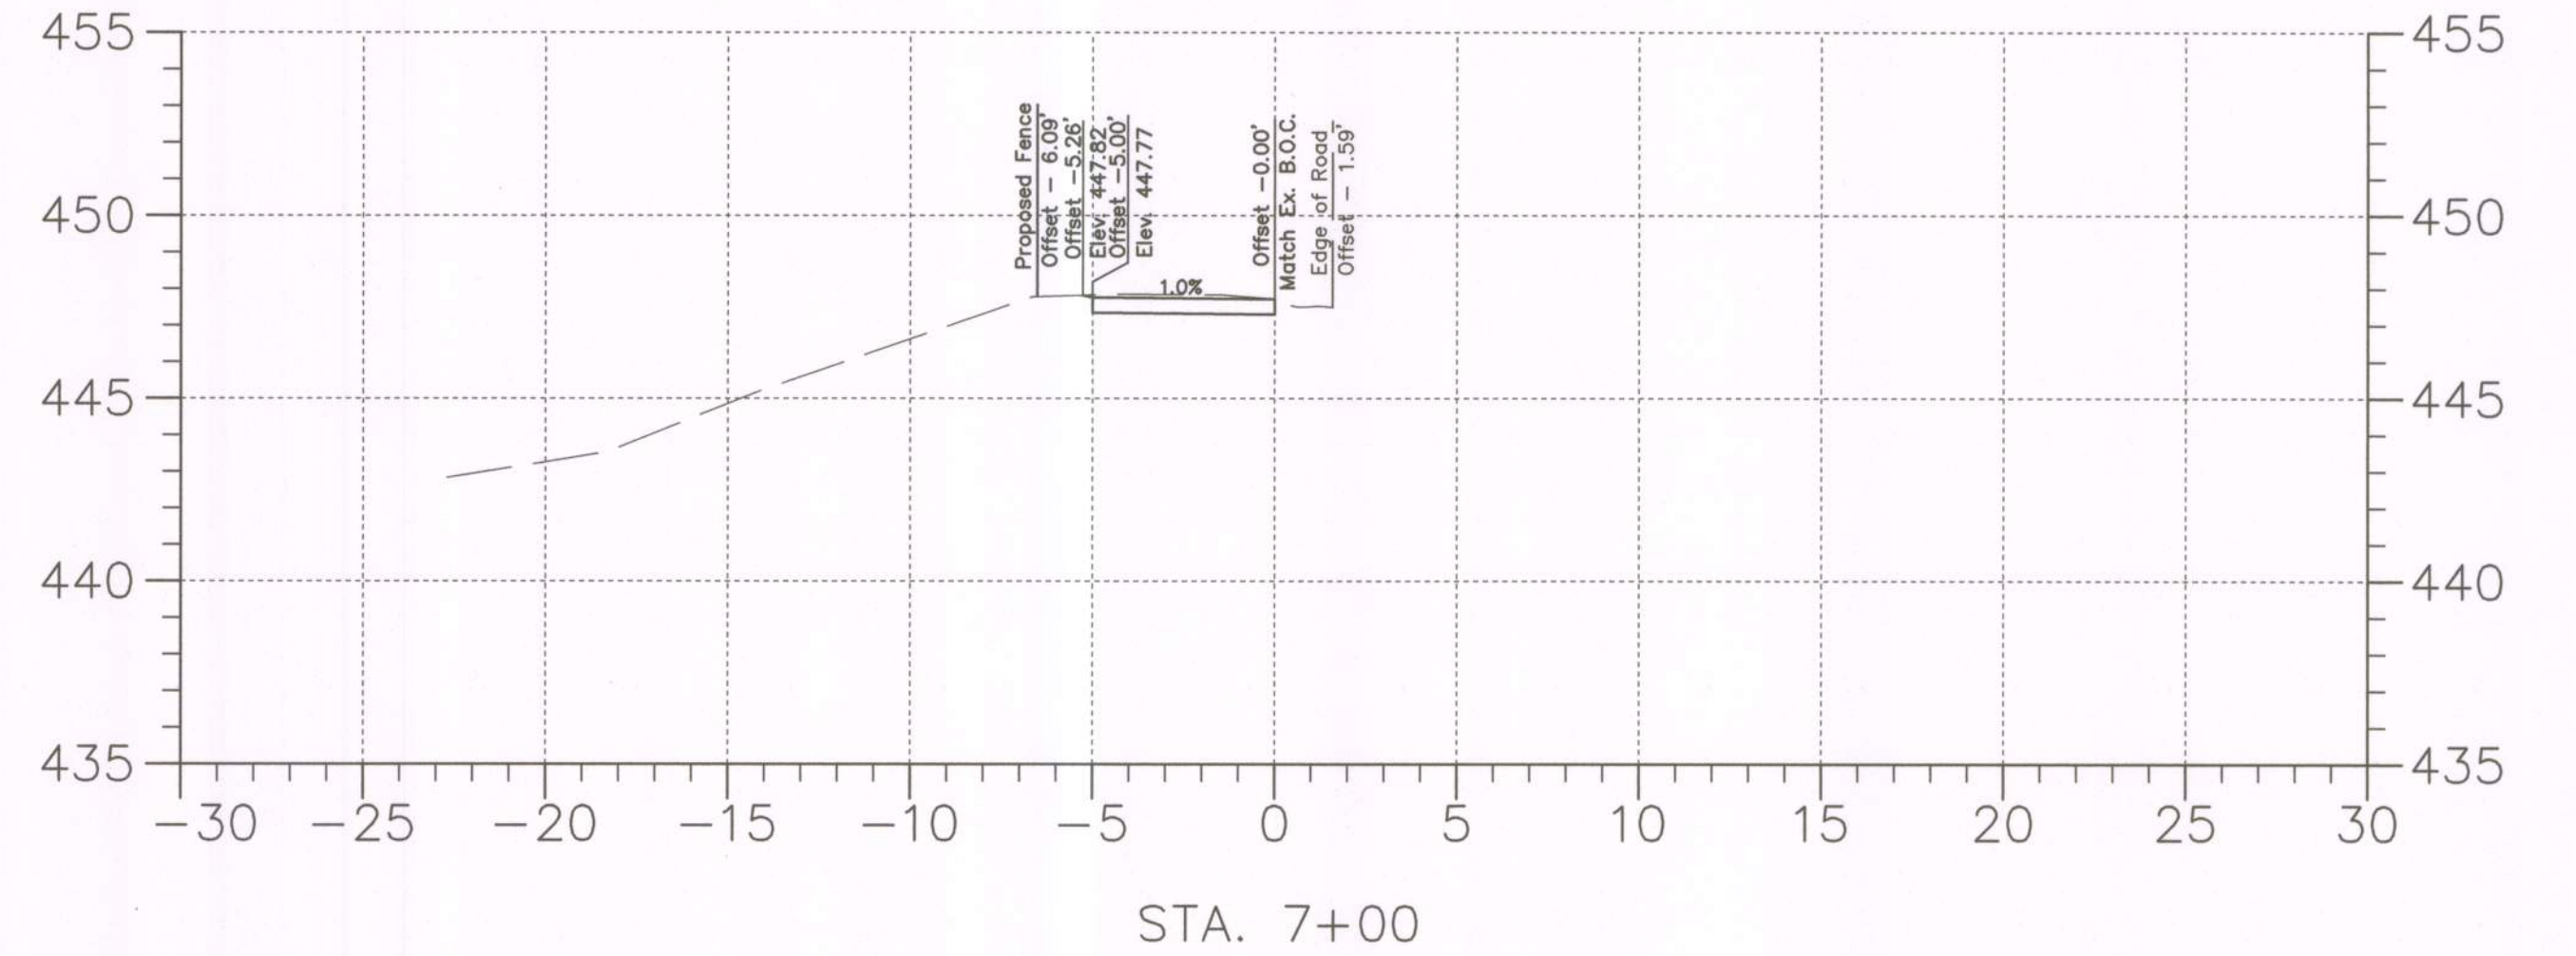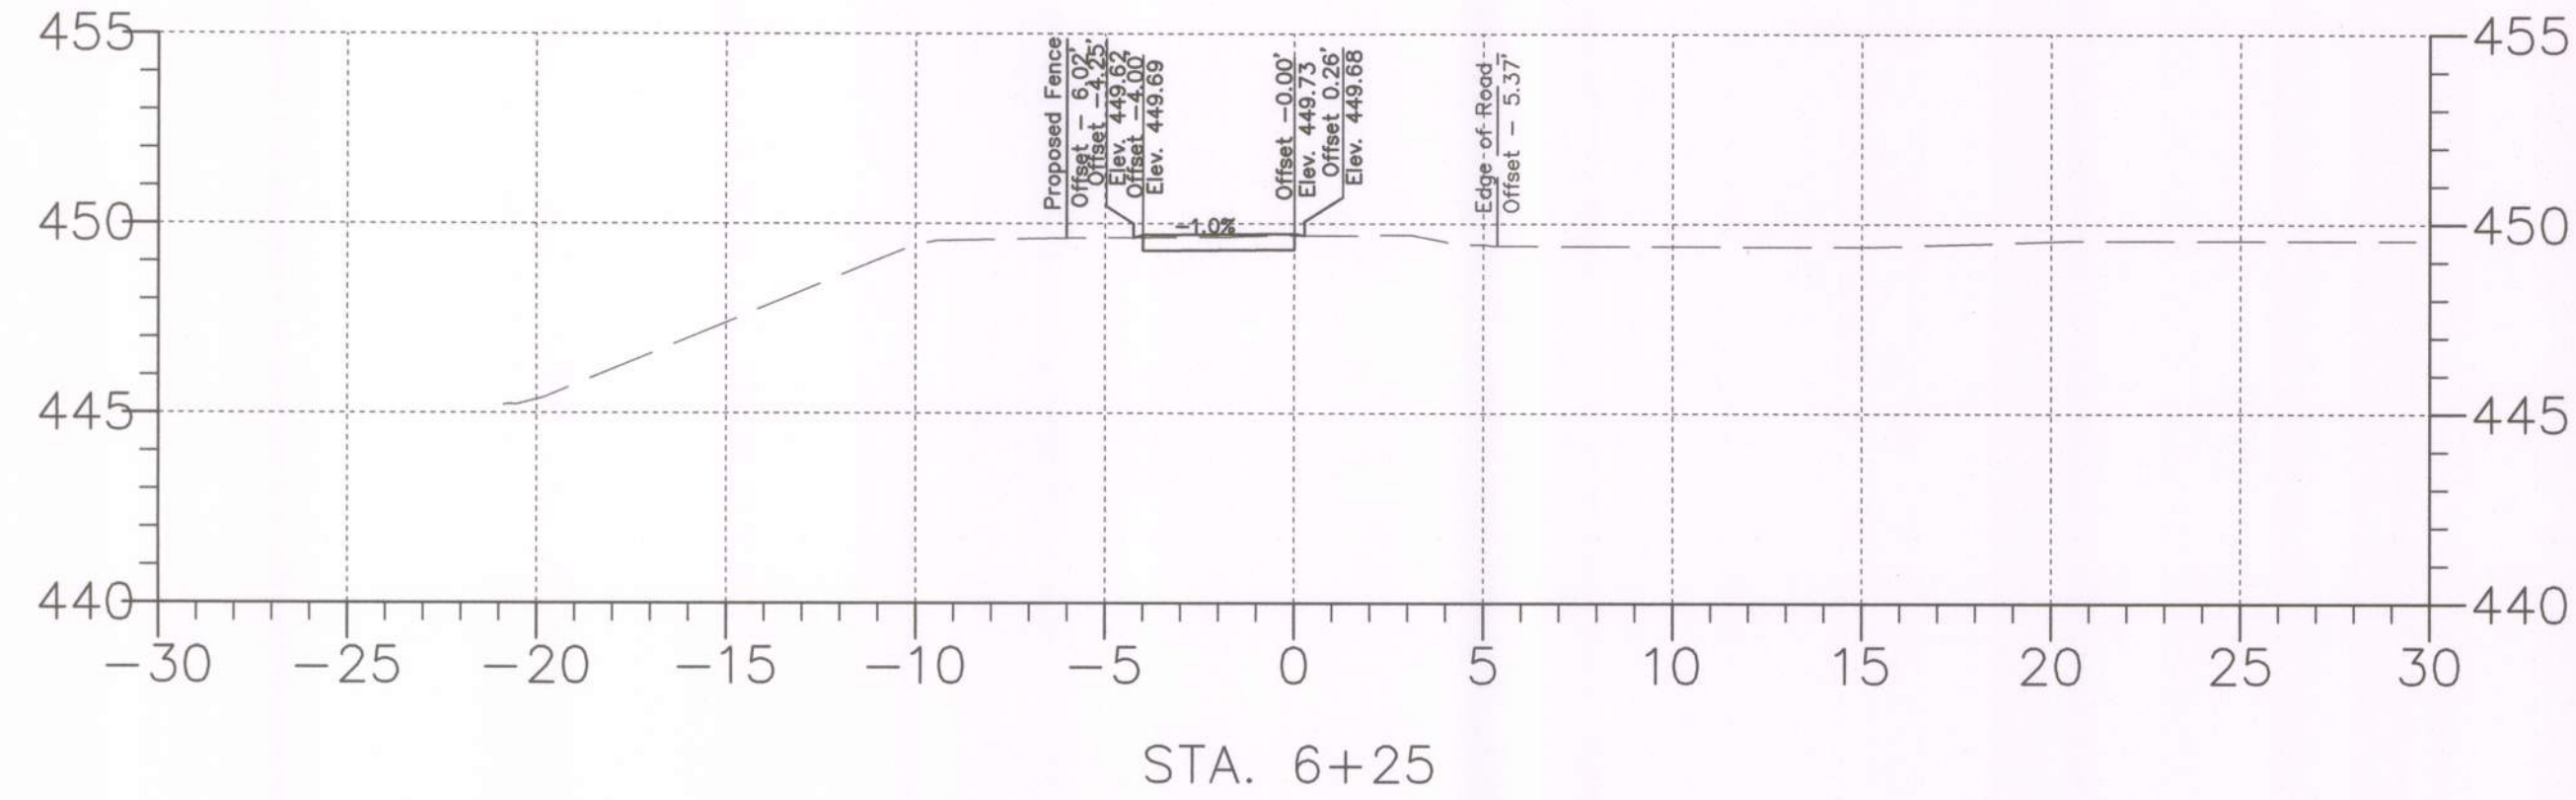

MONTGOMERY COUNTY
DEPARTMENT OF HOUSING AND COMMUNITY AFFAIRS

MONTGOMERY VILLAGE /SOUTH VILLAGE HOMES
LIGHTING AND SITE IMPROVEMENTS PROJECT

SCALE 5 SCALE ADVERTISED DATE N /A CONTRACT NO.


DESIGNED BY RJS COUNTY MONTGOMERY COUNTY
DRAWN BY RJS COUNTY LOGMILE
CHECKED BY JWR
DPS PERMIT

DRAWING NO. **XS - 04** OF **05** SHEET NO. 45 OF 46






PROFESSIONAL CERTIFICATION

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[Signature]
DOUGLAS H. SIMMONS, PE

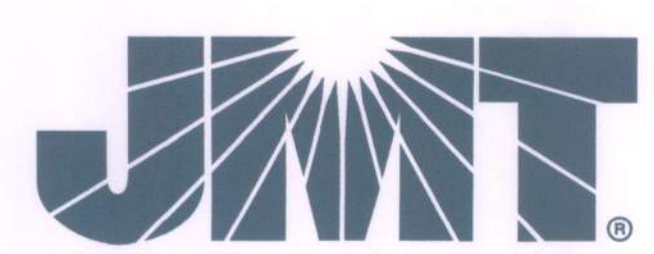

BY: Stratmeyer -

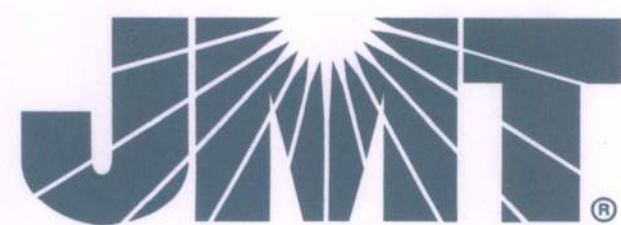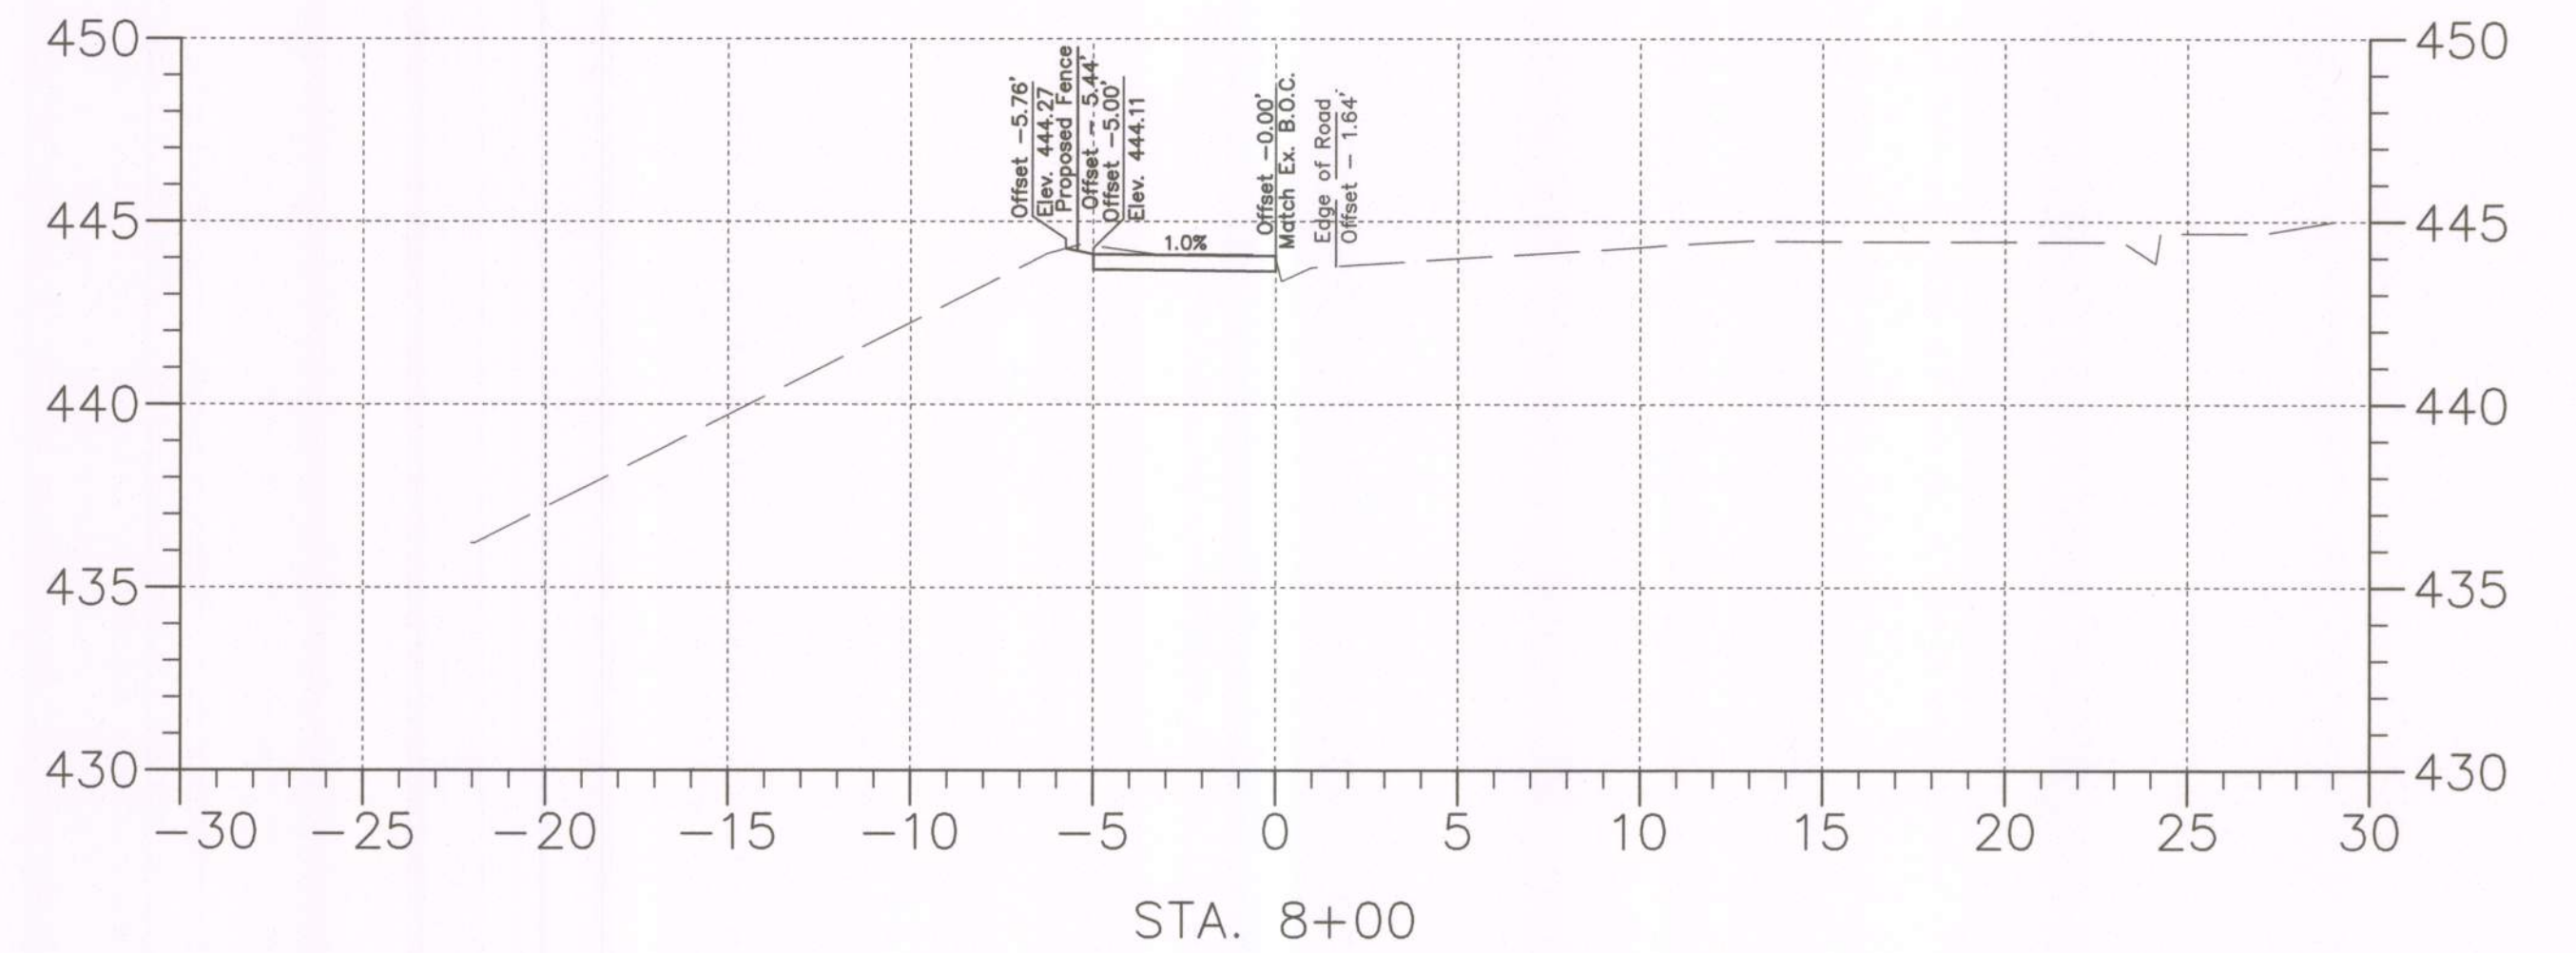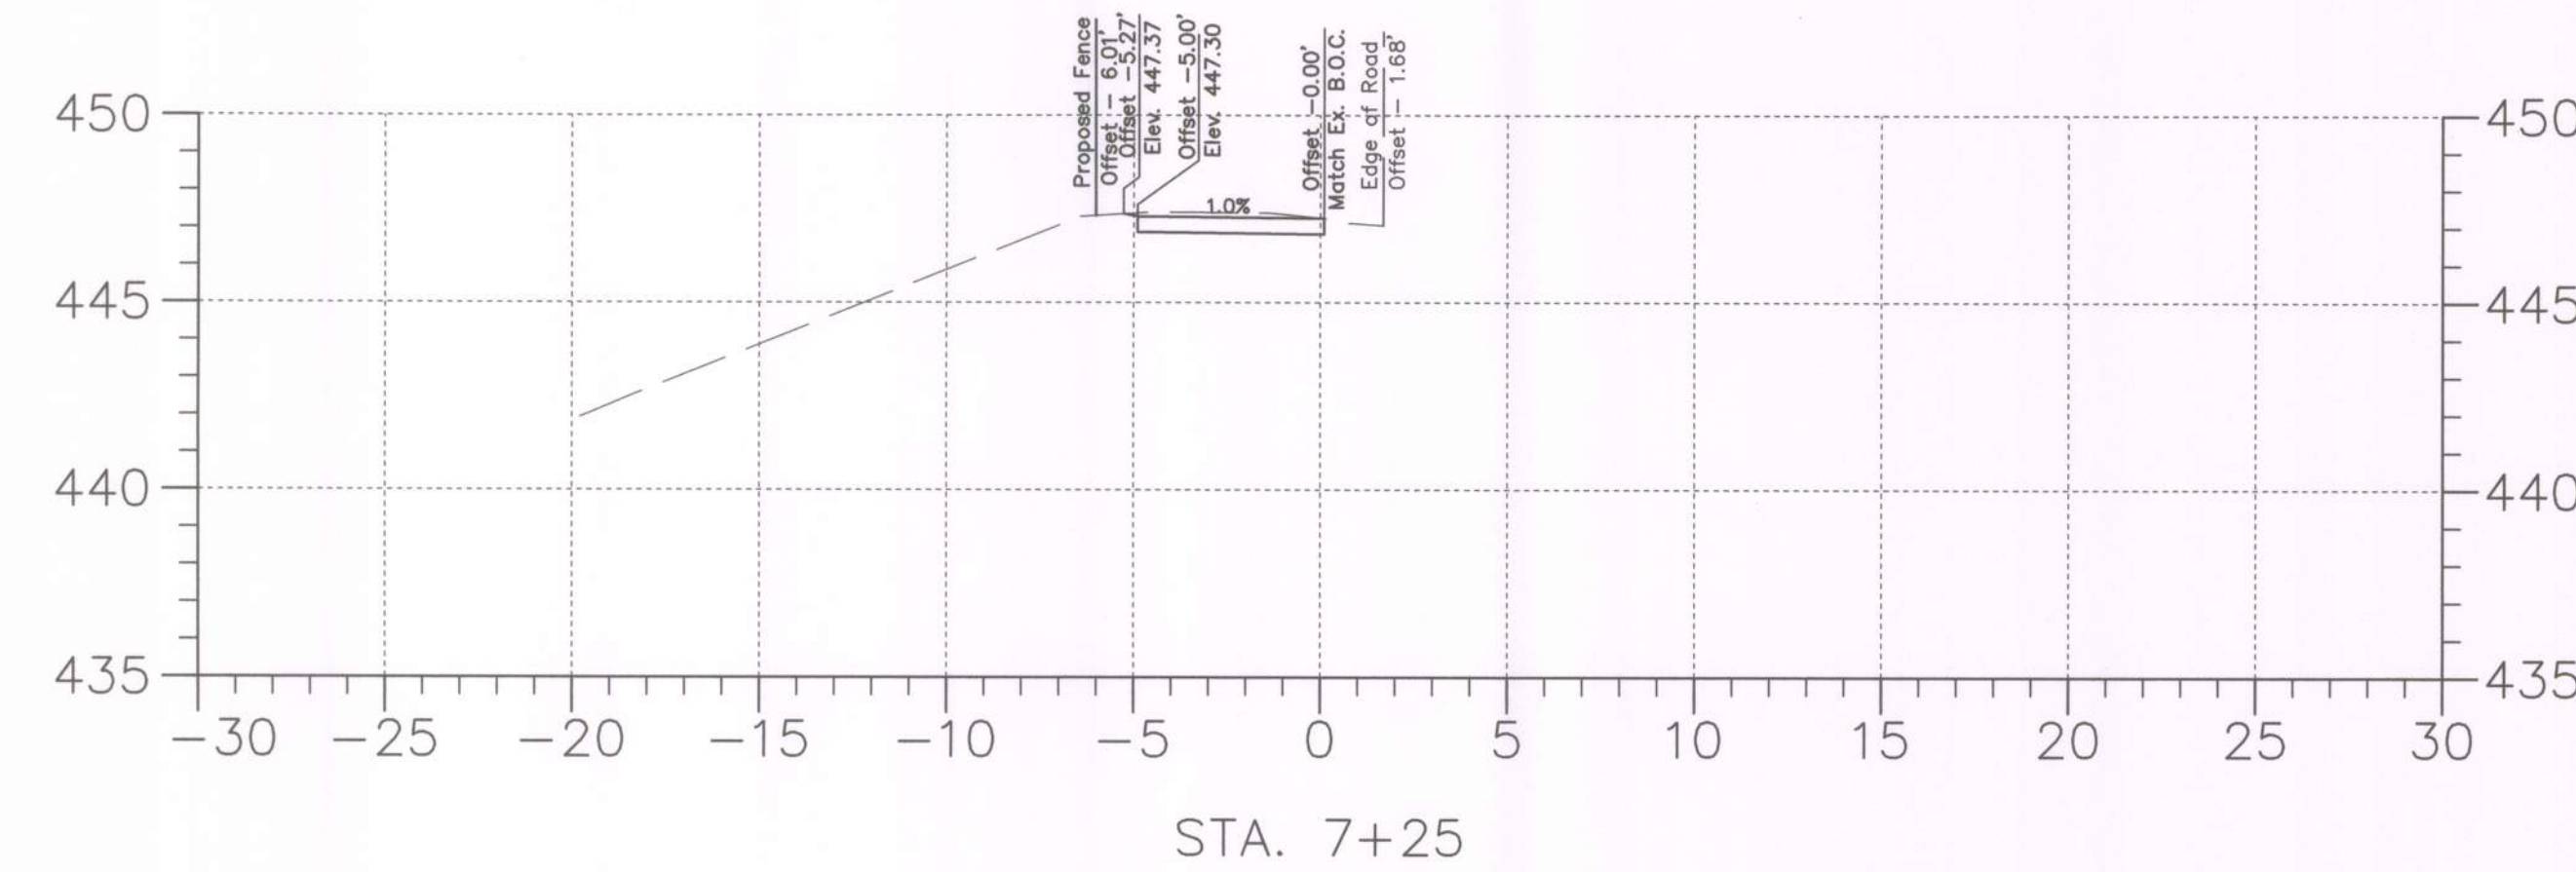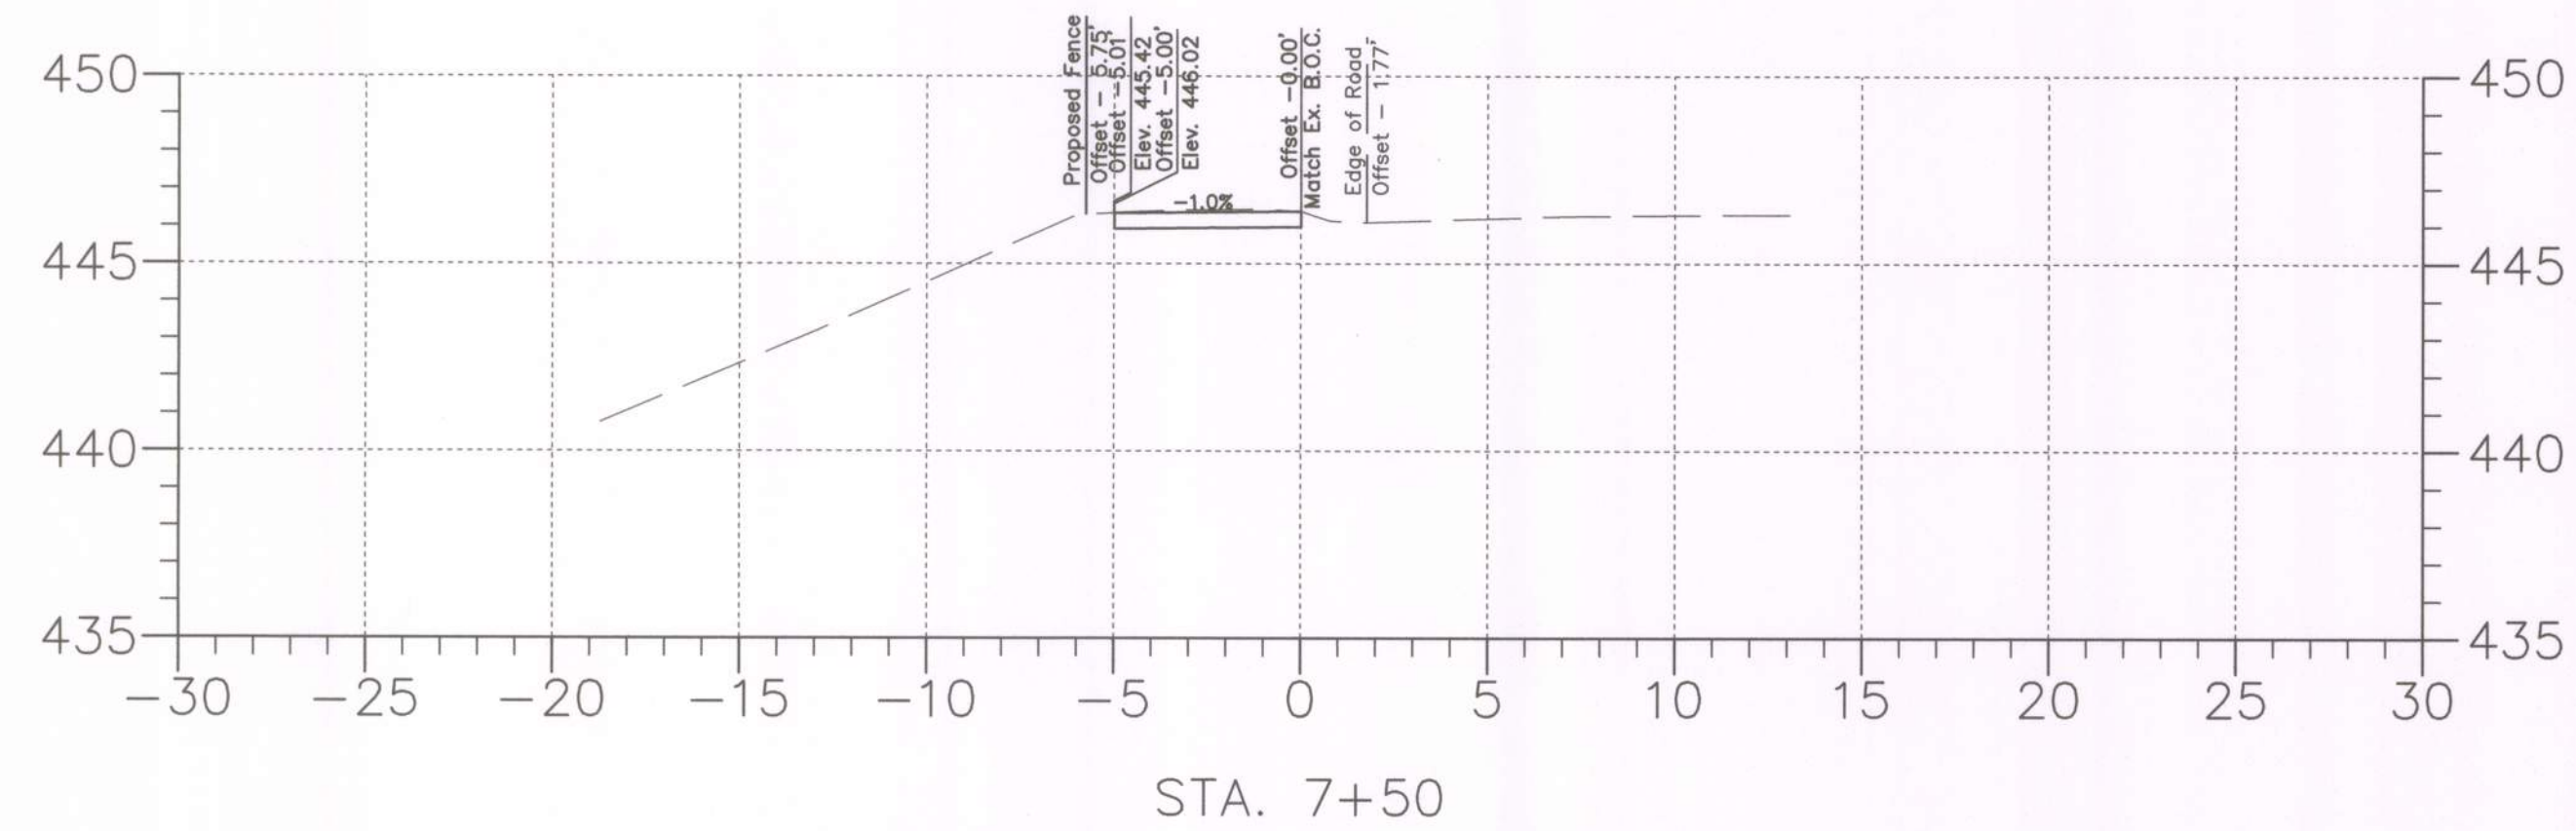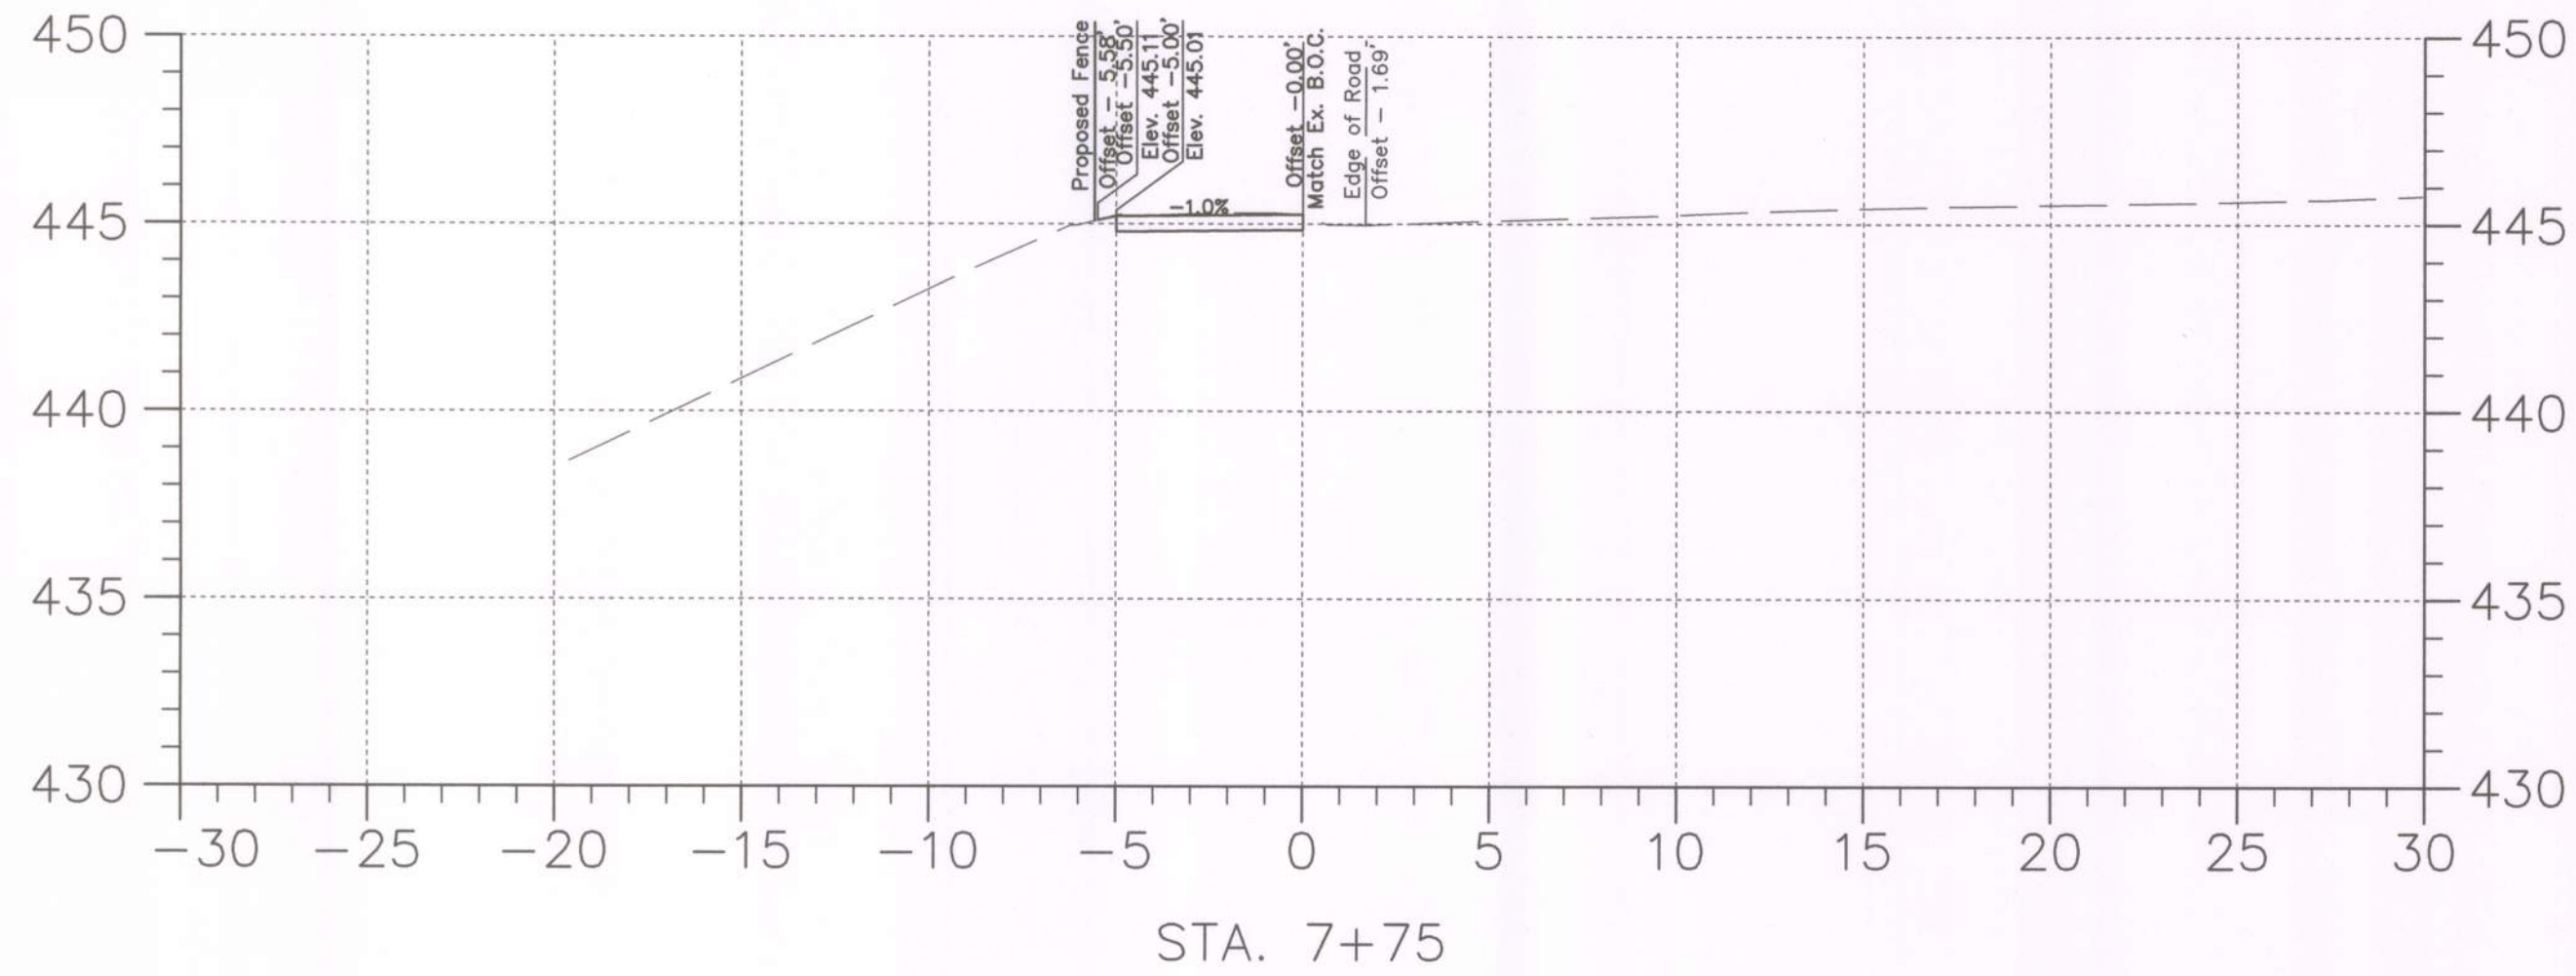

BY: Stratmeyer

PLOTTED: Thursday, May 23, 2019 AT 09:00 AM
FILE: Q:\2013\130707_003_Montgomery_Village_ICADD\mXC_MontVillage-001.dgn



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Douglas H. Simmons
DOUGLAS H. SIMMONS, PE

MONTGOMERY COUNTY
DEPARTMENT OF HOUSING AND COMMUNITY AFFAIRS
MONTGOMERY VILLAGE /SOUTH VILLAGE HOMES
LIGHTING AND SITE IMPROVEMENTS PROJECT

GROVER'S FORGE - CROSS SECTIONS

SCALE 5 SCALE ADVERTISED DATE N/A CONTRACT NO.

DESIGNED BY RJS COUNTY MONTGOMERY COUNTY
DRAWN BY RJS LOGMILE
CHECKED BY JJR
DPS PERMIT

DRAWING NO. **XS - 05** OF **05** SHEET NO. 46 OF 46